KING COUNTY HOUSING AUTHORITY

Westminster Manor - Exterior Improvements

PROJECT TEAM

OWNER: KING COUNTY HOUSING AUTHORITY 700 ANDOVER PARK W.

700 ANDOVER PARK W SUITE C SEATTLE, WA 98188 (206) 574-1249 CARL FRANKEL <CarlF@KCHA.org>

ARCHITECT: LAWHEAD ARCHITECTS P.S. 12342 NORTHUP WAY BELLEVUE, WA 98005

<FLawhead@Lawhead.com>

(425) 556-1220

FRANK LAWHEAD

STRUCTURAL: PCS STRUCTURAL SOLUTIONS, INC. 1011 WESTERN AVENUE SUITE 810 MECHANICAL/ ELECTRICAL: HULTZ BHU ENGINEERS INC. 1111 FAWCETT AVE. SUITE 100

1111 FAWCETT AVE.
SUITE 100
TACOMA, WA 98402
(253) 383-3257
RICK HULTZ
<RHultz@HultzBHU.com>

PROJECT DESCRIPTION / SCOPE OF WORK

SEATTLE, WA 98104

<TRyan@pcs-structural.com>

(206) 292-5076

TED RYAN

THE PROPOSED PROJECT CONSISTS OF THE FOLLOWING EXTERIOR IMPROVEMENTS TO AN EXISTING (4) STORY APARTMENT BUILDING CONSTRUCTED IN 1972, PROPERTY OF KING COUNTY HOUSING AUTHORITY: REPLACEMENT OF EXISTING LOW-SLOPE MEMBRANE ROOF, RELATED FLASHING, & ROOF DRAINAGE, WITH NEW; ADDITION OF NEW RAINSCREEN CLADDING SYSTEM OVER EXTERIOR WALLS; REPLACEMENT OF UNIT EXTERIOR DOORS & WINDOWS; REPLACEMENT OF UNIT DECK RAILING; OTHER RELATED WORK AS SHOWN IN THE DOCUMENTS;

ARCHITECTURAL ABBREVIATIONS


A.C.T.	ACOUSTIC CEILING TILE	EQ.	EQUAL	I.D.	INSIDE DIAMETER	R.O.	ROUGH OPENING
A.F.F.	ABOVE FINISH FLOOR	EQUIP.	EQUIPMENT	IN.	INCHES	R=	RADIUS
APPROX.	APPROXIMATE	EXIST.	EXISTING	INFO.	INFORMATION	RCP	REFLECTED CEILING PLAN
ARCH.	ARCHITECTURAL	EXP.	EXPOSED	INSUL.	INSULATION	REF.	REFER / REFERENCE
		EXT.			INTERIOR	NLF.	
BLDG.	BUILDING	EVI.	EXTERIOR	INT.		REFR.	REFRIGERATOR
BLKG.	BLOCKING	F.D.	FLOOR DRAIN	LAV.	LAVATORY	REINF.	REINFORCING
BOTT.	BOTTOM	F.E.	FIRE EXTINGUISHER	LB.	POUND	REQ.	REQUIRED / REQUIREMENTS
C.I.	CAST IRON	F.E.C.	FIRE EXTINGUISHER CABINET	LIN.FT.	LINEAR FEET	RM.	ROOM
C.J.	CONTROL JOINT;	F.F.	FACTORY FINISH	LOC.	LOCATE	S.S.	STAINLESS STEEL
	CONSTRUCTION JOINT	F.F.E.	FINISH FLOOR ELEVATION	MANUF.	MANUFACTURER;	SCWD	SOLID CORE WOOD DOOR
C.O.	CALL-OUT	F.H.C.	FIRE HOSE CABINET		MANUFACTURED	SECT.	SECTION
C.T.	CERAMIC TILE	F.O.	FACE OF	MATL.	MATERIAL	SIM.	SIMILAR
CEIL.	CEILING	F.O.I.C.	FURNISHED BY OWNER	MAX.	MAXIMUM	SL.	SEAL
CL	CENTERLINE		INSTALLED BY CONTRACTOR	MECH.	MECHANICAL	SPEC.	SPECIFICATIONS
CLR.	CLEAR	F.O.I.O.	FURNISHED BY OWNER	MEZZ.	MEZZANINE	SQ.	SQUARE
COL.	COLUMN	1.00.	INSTALLED BY OWNER	MFR.	MANUFACTURER	STD.	STANDARD
CONC.	CONCRETE	F.R.P.	FIBER REINFORCED PLASTIC	MIN.	MINIMUM	STL.	STEEL
CONN.	CONNECTION	F.V.	FIELD VERIFY	MISC.	MISCELLANEOUS	STRUCT.	STRUCTURAL
CONST.	CONSTRUCTION	FDN.	FOUNDATION	MTL.	METAL	SV	SHEET VINYL
		FDN.		N.I.C.		SYST.	SYSTEM
CONT.	CONTINUOUS	FIN.	FINISH	N.I.C.	NOT IN CONTRACT		5151EM
COORD.	COORDINATE	FT.	FOOT; FEET	N.T.S.	NOT TO SCALE	T.O.	TOP OF
ÇŞK.	COUNTERSINK	FTG.	FOOTING	NO.	NUMBER	TYP.	TYPICAL
D.F.	DRINKING FOUNTAIN	GA.	GAUGE	O.C.	ON CENTER	U.N.O.	UNLESS NOTED OTHERWISE
D.S.	DOWNSPOUT	GAL.	GALLON	O.D.	OUTSIDE DIAMETER	VB	VAPOR BARRIER
DBL.	DOUBLE	GALV.	GALVANIZED	OCC.	OCCUPANCY	VCT	VINYL COMPOSITE TILE
DEPT.	DEPARTMENT	GWB	GYPSUM WALLBOARD	OCC.'S	OCCUPANTS	VERT.	VERTICAL
DIA.	DIAMETER	GYP.	GYPSUM	OPP.	OPPOSITE	W.C.	WATER CLOSET
DIM.	DIMENSION	H.C.	BARRIER-FREE	P-LAM	PLASTIC LAMINATE	W/	WITH
E.J.	ELASTOMERIC JOINT /	H.M.	HOLLOW METAL	P.E.M.B.	PRE-ENGINEERED	W/O	WITHOUT
	EXPANSION JOINT	HORIZ.	HORIZONTAL		METAL BUILDING	WD	WOOD
EA.	EACH	HR	HOUR	P.L.	PROPERTY LINE	WDW.	WINDOW
ELECT.	ELECTRICAL	HT.	HEIGHT	PL.	PLATE	WGWB	WATER RESISTANT
ELEV.	ELEVATION/ELEVATIONS			PLUMB.	PLUMBING		GYPSUM WALLBOARD
FNI	ENI ARGED			PT.	POINT	WT	WEIGHT

ARCHITECTURAL SYMBOLS

ĮVII.					•
(123) A	DOOR C.O.	1-	KEY NOTE	1 A1-1	PARTIAL SECTION
A	WINDOW C.O.	8'-0"	CEILING OR HEADER HEIGHT		
X'-X" 1	WALL C.O. (X'-X" = HEIGHT)	4 A1-1 2	INTERIOR ELEVATIONS	1 A1-1	WALL SECTION
1	FLAG NOTE	1	BUILDING GRIDS	1 A1-1	DETAIL CALL-OUT
	REVISION NOTE	1 A1-1	DETAIL & ENLARGED PLAN CALL-OUTS		
1 A1.1	PARTIAL INTERIOR ELEVATIONS		CALL-OUTS		

VICINITY MAP

14701 DAYTON AVENUE NORTH, SHORELINE, WA 98133

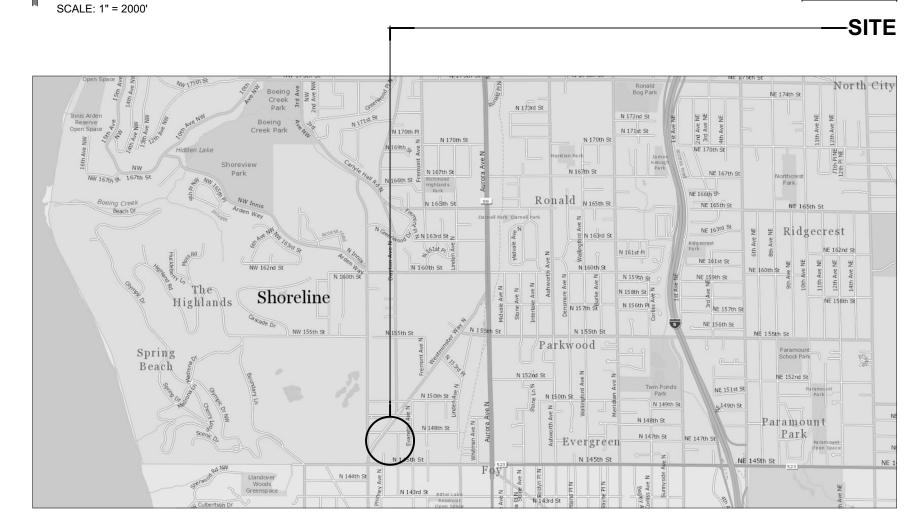

PROJECT DATA

SITE ADDRESS: 14701 DAYTON AVENUE NORTH

SHORELINE, WA 98133

PARCEL: #182604-9021

LOT AREA: 36,184 SQ. FT. (0.83 ACRES)

ZONING: R-48: RESIDENTIAL, 48 UNITS / ACRE

PARKING: NO CHANGE TO EXISTING.

BUILDING AREA: \pm 8,570 SQ. FT. x (4) STORIES = \pm 34,280 SQ. FT. TOTAL

(IBC 202) UNCHANGED

BUILDING HEIGHT: ± 35'-0" (4TH STORY ROOF) ≤ 60' (TABLE 504.3) (IBC 202) ± 44'-0" MAX. OVERALL HEIGHT (TOP OF PENTHOUSE)

(4) STORY BUILDING ≤ (4) ALLOWABLE STORIES ABOVE GRADE PLANE (TABLE 504.4)

CONSTRUCTION TYPE: UNKNOWN. MIXED-USE, SPRINKLERED PER NFPA 13R. (IBC 601) MINIMUM TYPE V-A CONSTRUCTION REQUIRED IN 2018

MINIMUM TYPE V-A CONSTRUCTION REQUIRED IN 2018 IBC FOR A FULLY-SPRINKLERED BUILDING MEETING IBC 903.3.1.2.

PRIMARY OCCUPANCY IS R-2.
NO CHANGE TO CURRENT FLOOR AREA

OR OCCUPANCY.

ON OCCUPANCI.

R-2 OCCUPANCY IS MOST CRITICAL OCC. TYPE. = 12,000 SF TABULAR BUILDING AREA.

> PER IBC 506.2.3, EQUATION 5-2: $A_a = [A_t + (NS \times I_f)] \times S_a$

 $A_a = [12,000 + (12,000 \times 0)] \times 3 = 36,000 \text{ SF MAX}.$

(EXCLUDING FRONTAGE INCREASE)

APPLICABLE CODES:

(IBC TABLE 506.2)

MAX. ALLOWABLE AREA:

OCCUPANCY:

(IBC 302)

SHORELINE MUNICIPAL CODE (SMC) 2018 IBC, WAC 51-50 2009 ICC/ANSI A117.1 2018 IFC, WAC 51-54A 2018 WSEC, WAC 51-11C 2018 IMC, WAC 51-52 2020 NEC (NFPA 70), WAC 296-46B-010

LEGAL DESCRIPTION

E 150 FT OF N 1/2 OF SW 1/4 OF SW 1/4 OF SW 1/4 LESS CO RD

INDEX

CS COVER SHEET

ARCHITECTURAL

Δ1-1	SITE PLAN

AD-1 AD-2 AD-3 AD-4 AD-5 AD-6	1ST FLOOR DEMO PLAN 2ND FLOOR DEMO PLAN 3RD FLOOR DEMO PLAN 4TH FLOOR DEMO PLAN ROOF DEMO PLAN FLEVATION DEMO PHOTOS
AD-5 AD-6	ROOF DEMO PLAN ELEVATION DEMO PHOTOS
AD-0 AD-7	ROOF DEMO PHOTOS

A2-1 1ST FLOOR PLAN
A2-2 2ND FLOOR PLAN
A2-3 3RD FLOOR PLAN
A2-4 4TH FLOOR PLAN
A2-5 ROOF PLAN
A2-6 SCHEDULES

A3-1 ELEVATIONS

A4-1 BUILDING SECTIONS
A4-2 BUILDING SECTIONS
A4-3 BUILDING SECTIONS

A5-1 WALL SECTIONS A5-2 WALL SECTIONS

A8-1 EXTERIOR DETAILS
A8-2 EXTERIOR DETAILS
A8-3 EXTERIOR DETAILS
A8-4 EXTERIOR DETAILS
A8-5 EXTERIOR DETAILS

STRUCTURAL

S1-1 GENERAL NOTES S1-2 DETAILS

MECHANICAL

M0-1 MECHANICAL LEGEND & NOTES
M1-0 FIRST FLOOR PLAN - MECHANICAL
M2-0 ROOF PLAN - MECHANICAL

ELECTRICAL

E0-1 ABBREVIATIONS, LEGEND, & GENERAL NOTES

E0-2 ELECTRICAL SPECIFICATIONS

E3-1 1ST FLOOR PLAN E3-4 4TH FLOOR PLAN


ROOF PLAN

EAST FACADE PERSPECTIVE



LAWHEAD ARCHITECTS P.S.

1239 120TH AVE. N.E., STE. I BELLEVUE, WA 9800

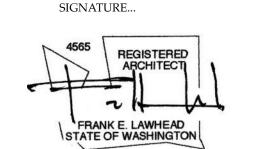

OWNER...



WESTMINSTER MANOR

Freedom & Roof Project

PHASE...

Bid Set

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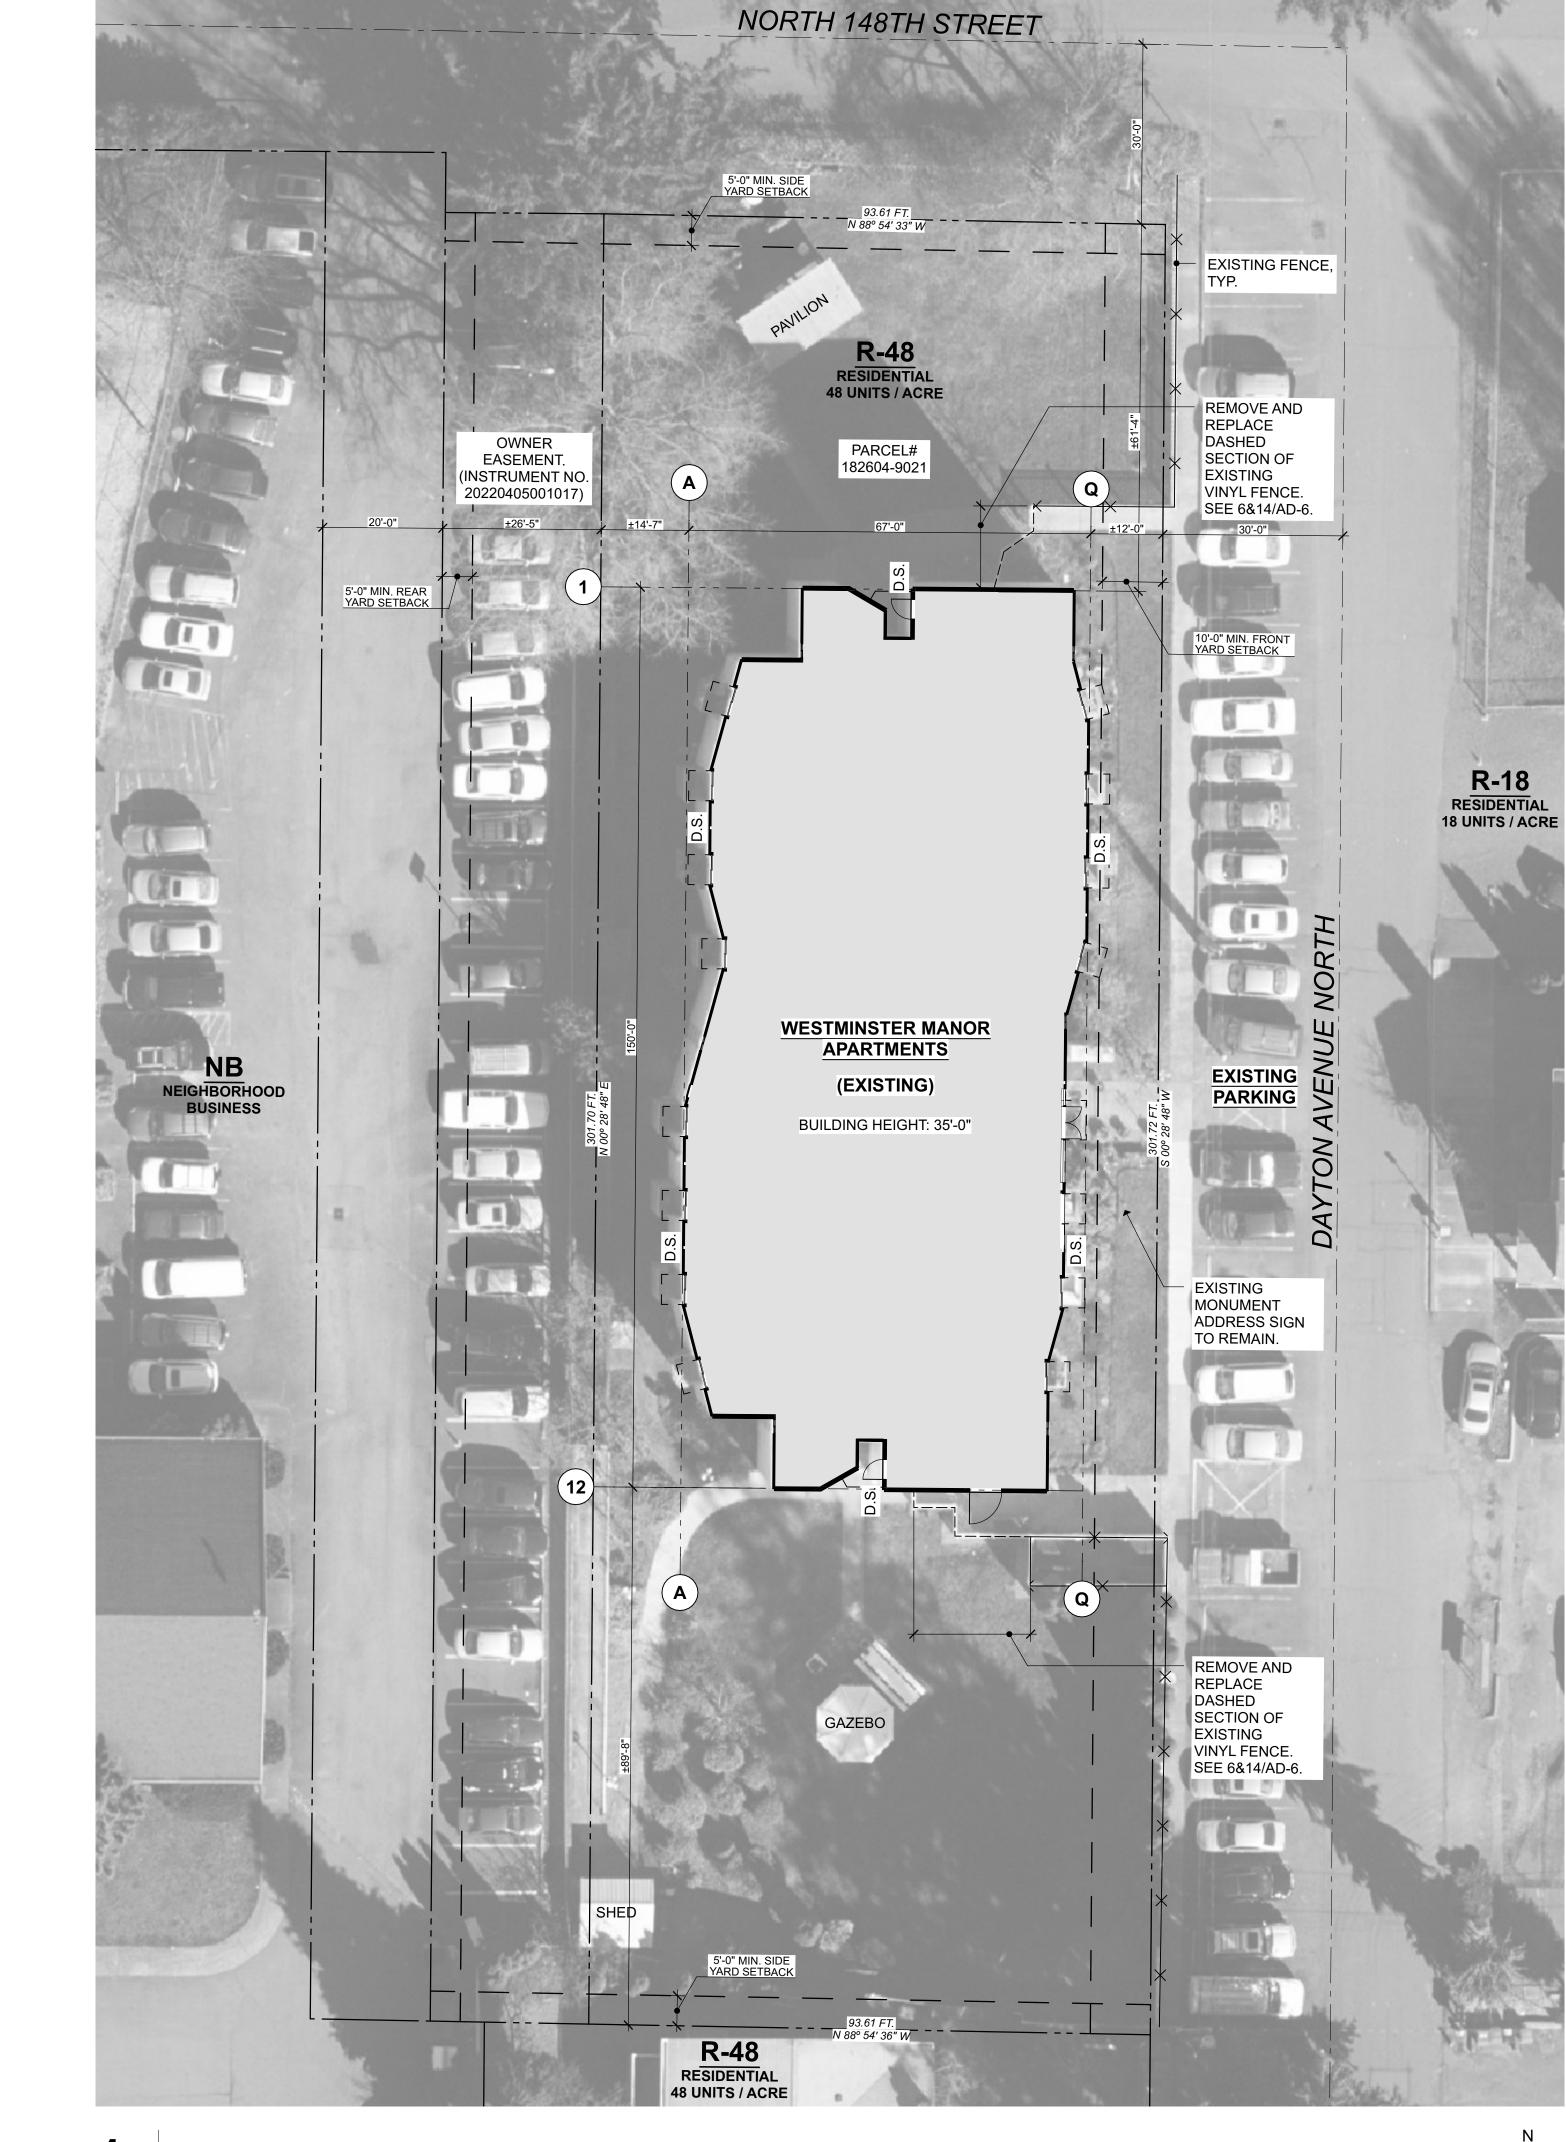
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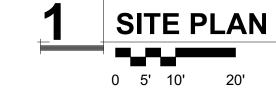
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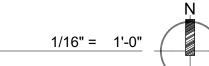
8/13/24

Cover Sheet

SHEET NO...







King County Housing Authorin
WESTMINSTER MANC

LAWHEADARCHITECTS

1239 120TH AVE. N.E., STE. D BELLEVUE, WA 98005 (425) 556-1220

SIGNATURE...

OWNER...

+--PHASE...

Bid Set

JOB NO...

23-10

DATE...
8/13/24

SHEET TITLE...

Site Plan

SHEET NO... **1**

(c)

- - - DEMOLISH EXISTING STUCCO, WEATHER BARRIER, AND ASSOCIATED TRIM.

| | |

CORE TYPE

LIVING

KITCHEN

KITCHEN

BEDROOM

D.S.

COMMUNITY

KEY NOTES:

LAUNDRY

SERVICES

VESTIBULE

- (1.3) PROTECT & MAINTAIN EXISTING DOOR AND STOREFRONT.
- PROTECT & MAINTAIN EXISTING DOOR AND STOREFRONT. REMOVE OPERATOR, INSTALL NEW OPERATOR UNDER NEW SCOPE OF WORK.

- (1.9) PROTECT & MAINTAIN WALL MOUNTED FIRE DEPARTMENT CONNECTION (FDC).

(6)

BEDROOM

STORAGE

HALLELEVATOR

OFFICE

BEDROOM

KITCHEN

<u>KITCHEN</u>

GENERAL NOTES:

- 1. CONTRACTOR IS RESPONSIBLE FOR MAINTAINING SAFE & SECURE ACCESS TO TENANTS IN CONSTRUCTION AREAS AT ALL TIMES.
- 2. ASBESTOS-CONTAINING MATERIALS (ACM) HAVE BEEN IDENTIFIED IN STUCCO CLADDING. COORDINATE WITH OWNER FOR COPY OF HAZ-MAT REPORT AND PLAN FOR HAZARDOUS MATERIALS ABATEMENT.
- 3. REMOVE ALL EXISTING STUCCO SIDING, AIR / WEATHER BARRIER, TRIM, AND EXTERIOR SHEATHING. PRIOR TO INSTALLING NEW SHEATHING, INSULATE WALLS TO A FULL DEPTH WITH INSULATION HAVING A MINIMUM NOMINAL VALUE OF R-3.0 PER INCH.
- 4. REMOVE EXISTING DOORS & WINDOWS INDICATED PER KEY NOTES 1.2 & 1.7 TO MAKE WAY

FOR NEW. COORDINATE WITH OWNER ON SEQUENCING OF REPLACEMENT.

- 5. REMOVE, SALVAGE, & SAFELY STORE ALL EXISTING FIXTURES & EQUIPMENT DESIGNATED TO BE RE-USED IN THE AREA OF WORK.
- 6. CONTRACTOR TO COORDINATE REQUIRED SHUTDOWNS WITH OWNER.
- 7. NOTIFY OWNER IMMEDIATELY IF WATER DAMAGE IS OBSERVED IN THE COURSE OF THE
- 8. CONTRACTOR TO FIELD VERIFY ALL DIMENSIONS.
- 9. PROTECT EXISTING LANDSCAPE.


CORE TYPE

CORE

BEDROOM

BEDROOM

10. SEE MECHANICAL AND ELECTRICAL FOR ADDITIONAL DEMO WORK NOT SHOWN HERE, INCLUDING BUT NOT LIMITED TO: HVAC, PLUMBING, GAS, ELECTRIC, & CABLE UTILITIES.

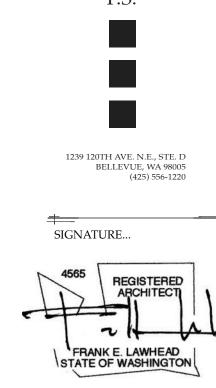

LAWHEAD ARCHITECTS





JOB NO...

DATE... 8/13/24

SHEET TITLE...

1st Floor Demo Plan



- DEMO EXISTING STUCCO SIDING, METAL LATH, WEATHER BARRIER, TRIM, AND EXTERIOR SHEATHING.
- REMOVE EXISTING DOOR, DOOR FRAME, DOOR HARDWARE, DOOR THRESHOLD, AND ASSOCIATED INTERIOR TRIM.

- PROTECT & MAINTAIN EXISTING DOOR AND FRAME. STRIP PAINT AND REMOVE RUST. PREPARE DOOR AND FRAME FOR NEW PAINT.
- PROTECT & MAINTAIN EXISTING DOOR AND FRAME. PATCH/REPAIR DENTS WITH BONDO. PREPARE DOOR AND FRAME FOR NEW PAINT.
- REMOVE EXISTING WINDOW, EXTERIOR, INTERIOR TRIM. IF WINDOW GUARDS EXIST, REMOVE/SALVAGE, RE-INSTALL AFTER NEW WINDOWS HAVE BEEN INSTALLED.
- 1.8 PROTECT & MAINTAIN EXISTING STOREFRONT WINDOW.


- - - DEMOLISH EXISTING STUCCO, WEATHER BARRIER, AND ASSOCIATED TRIM.

KEY NOTES:


- DEMO EXISTING STUCCO SIDING, METAL LATH, WEATHER BARRIER, TRIM, AND EXTERIOR SHEATHING.
- REMOVE EXISTING DOOR, DOOR FRAME, DOOR HARDWARE, DOOR THRESHOLD, AND ASSOCIATED INTERIOR TRIM.
- REMOVE EXISTING WINDOW, EXTERIOR, INTERIOR TRIM. REMOVE/SALVAGE WINDOW GUARDS, RE-INSTALL AFTER NEW WINDOWS HAVE BEEN INSTALLED.
- (2.4) REMOVE EXISTING WINDOW, EXTERIOR, INTERIOR TRIM.
- (2.5) REMOVE EXISTING ANGLED WINDOW, EXTERIOR, INTERIOR TRIM.
- (2.6) REMOVE EXISTING DECK COATING AND DECK RAILING SYSTEM.
- REMOVE EXISTING FLUID APPLIED COATING. IF GRINDING IS REQUIRED FOR REMOVAL, CONTROL ANY DUST GENERATED FROM THE REMOVAL PROCESS.
- REMOVE/SALVAGE EXISTING FLUE, RE-INSTALL AFTER NEW SIDING HAS BEEN INSTALLED. SEE MECHANICAL.

GENERAL NOTES:

- CONTRACTOR IS RESPONSIBLE FOR MAINTAINING SAFE & SECURE ACCESS TO TENANTS IN CONSTRUCTION AREAS AT ALL TIMES.
- 2. ASBESTOS-CONTAINING MATERIALS (ACM) HAVE BEEN IDENTIFIED IN STUCCO CLADDING. COORDINATE WITH OWNER FOR COPY OF HAZ-MAT REPORT AND PLAN FOR HAZARDOUS MATERIALS ABATEMENT.
- 3. REMOVE ALL EXISTING STUCCO SIDING, AIR / WEATHER BARRIER, TRIM, AND EXTERIOR SHEATHING. PRIOR TO INSTALLING NEW SHEATHING, INSULATE WALLS TO A FULL DEPTH WITH INSULATION HAVING A MINIMUM NOMINAL VALUE OF R-3.0 PER INCH.
- REMOVE ALL EXISTING DOORS & WINDOWS INDICATED PER KEY NOTES 2.2 & 2.4 TO MAKE WAY FOR NEW. COORDINATE WITH OWNER ON SEQUENCING OF REPLACEMENT.
- 5. REMOVE, SALVAGE, & SAFELY STORE ALL EXISTING FIXTURES & EQUIPMENT DESIGNATED TO BE RE-USED IN THE AREA OF WORK.
- 6. CONTRACTOR TO COORDINATE REQUIRED SHUTDOWNS WITH OWNER.
- 7. NOTIFY OWNER IMMEDIATELY IF WATER DAMAGE IS OBSERVED IN THE COURSE OF THE PROJECT.
- 8. CONTRACTOR TO FIELD VERIFY ALL DIMENSIONS.
- 9. SEE MECHANICAL AND ELECTRICAL FOR ADDITIONAL DEMO WORK NOT SHOWN HERE, INCLUDING BUT NOT LIMITED TO: HVAC, PLUMBING, GAS, ELECTRIC, & CABLE UTILITIES.

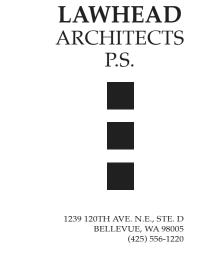


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OWNER...

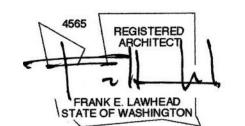



8/13/24

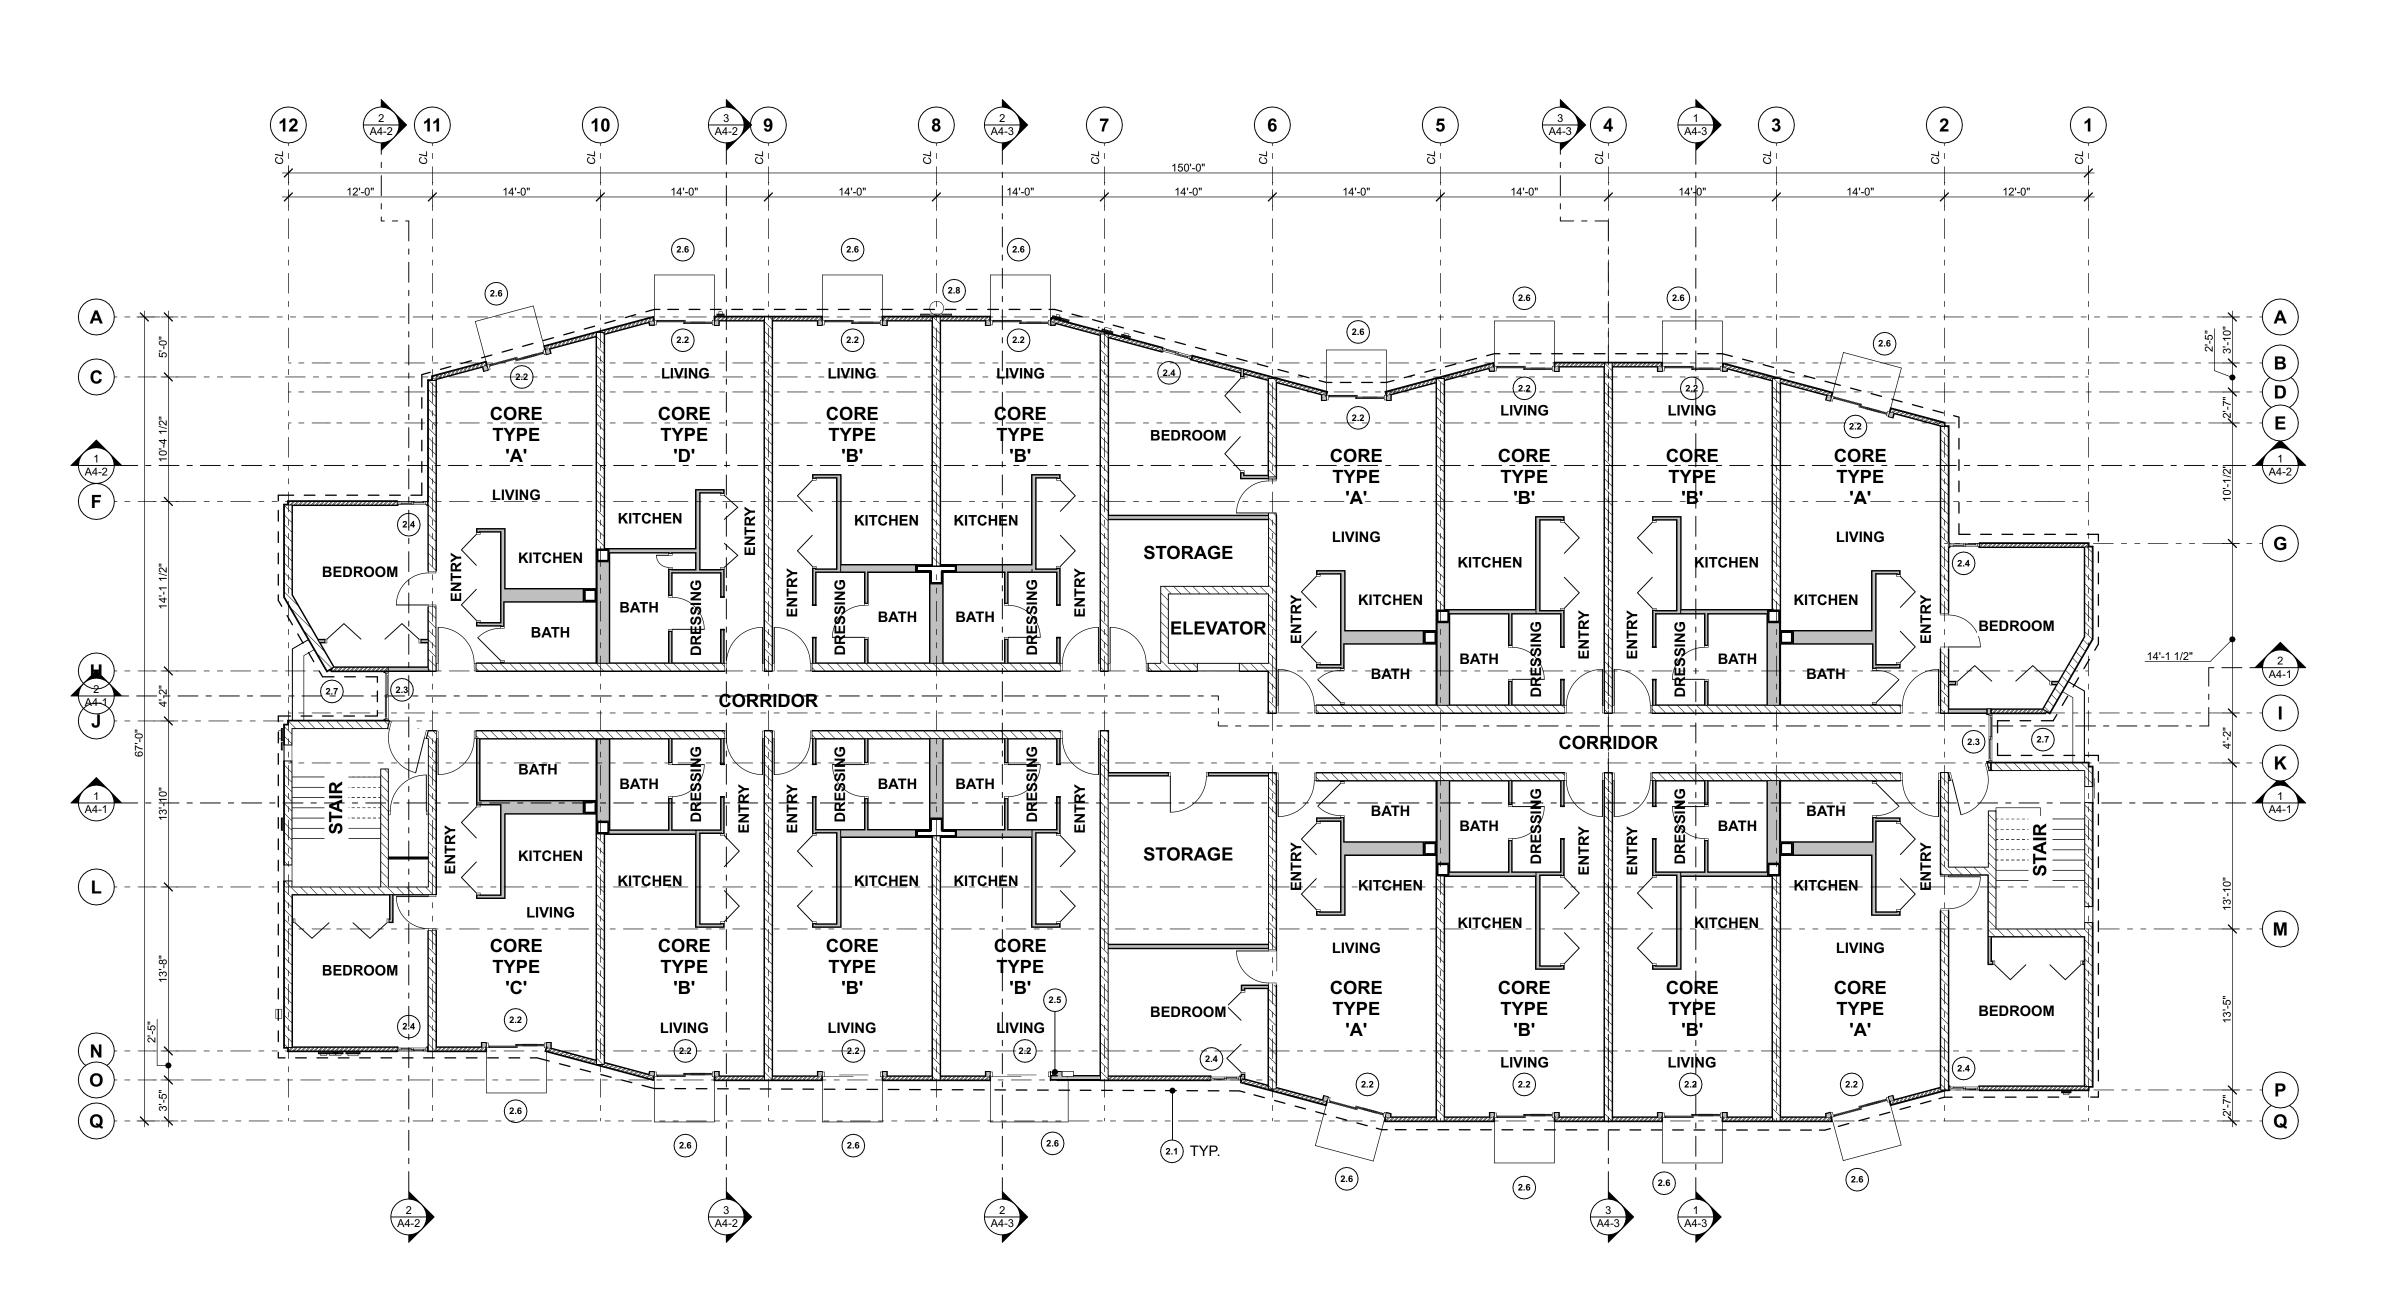SHEET TITLE...

JOB NO...

2nd Floor Demo Plan

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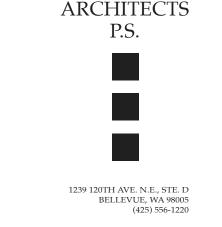
- - - DEMOLISH EXISTING STUCCO, WEATHER BARRIER, AND ASSOCIATED TRIM.

KEY NOTES:

- DEMO EXISTING STUCCO SIDING, METAL LATH, WEATHER BARRIER, TRIM, AND EXTERIOR SHEATHING.
- REMOVE EXISTING DOOR, DOOR FRAME, DOOR HARDWARE, DOOR THRESHOLD, AND ASSOCIATED INTERIOR TRIM.
- REMOVE EXISTING WINDOW, EXTERIOR, INTERIOR TRIM. REMOVE/SALVAGE WINDOW GUARDS, RE-INSTALL AFTER NEW WINDOWS HAVE BEEN INSTALLED.
- (3.4) REMOVE EXISTING WINDOW, EXTERIOR, INTERIOR TRIM.
- (3.5) REMOVE EXISTING DECK COATING AND DECK RAILING SYSTEM.
- REMOVE/SALVAGE EXISTING FLUE, RE-INSTALL AFTER NEW SIDING HAS BEEN INSTALLED. SEE MECHANICAL.


GENERAL NOTES:

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- 3. REMOVE ALL EXISTING STUCCO SIDING, AIR / WEATHER BARRIER, TRIM, AND EXTERIOR SHEATHING. PRIOR TO INSTALLING NEW SHEATHING, INSULATE WALLS TO A FULL DEPTH WITH INSULATION HAVING A MINIMUM NOMINAL VALUE OF R-3.0 PER INCH.
- 4. REMOVE ALL EXISTING DOORS & WINDOWS INDICATED PER KEY NOTES 3.2 & 3.4 TO MAKE WAY FOR NEW. COORDINATE WITH OWNER ON SEQUENCING OF REPLACEMENT.
- 5. REMOVE, SALVAGE, & SAFELY STORE ALL EXISTING FIXTURES & EQUIPMENT DESIGNATED TO BE RE-USED IN THE AREA OF WORK.
- 6. CONTRACTOR TO COORDINATE REQUIRED SHUTDOWNS WITH OWNER.
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- 8. CONTRACTOR TO FIELD VERIFY ALL DIMENSIONS.
- 9. SEE MECHANICAL AND ELECTRICAL FOR ADDITIONAL DEMO WORK NOT SHOWN HERE, INCLUDING BUT NOT LIMITED TO: HVAC, PLUMBING, GAS, ELECTRIC, & CABLE UTILITIES.




LAWHEAD

SIGNATURE...

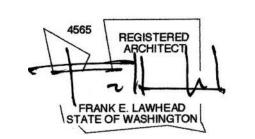

OWNER...



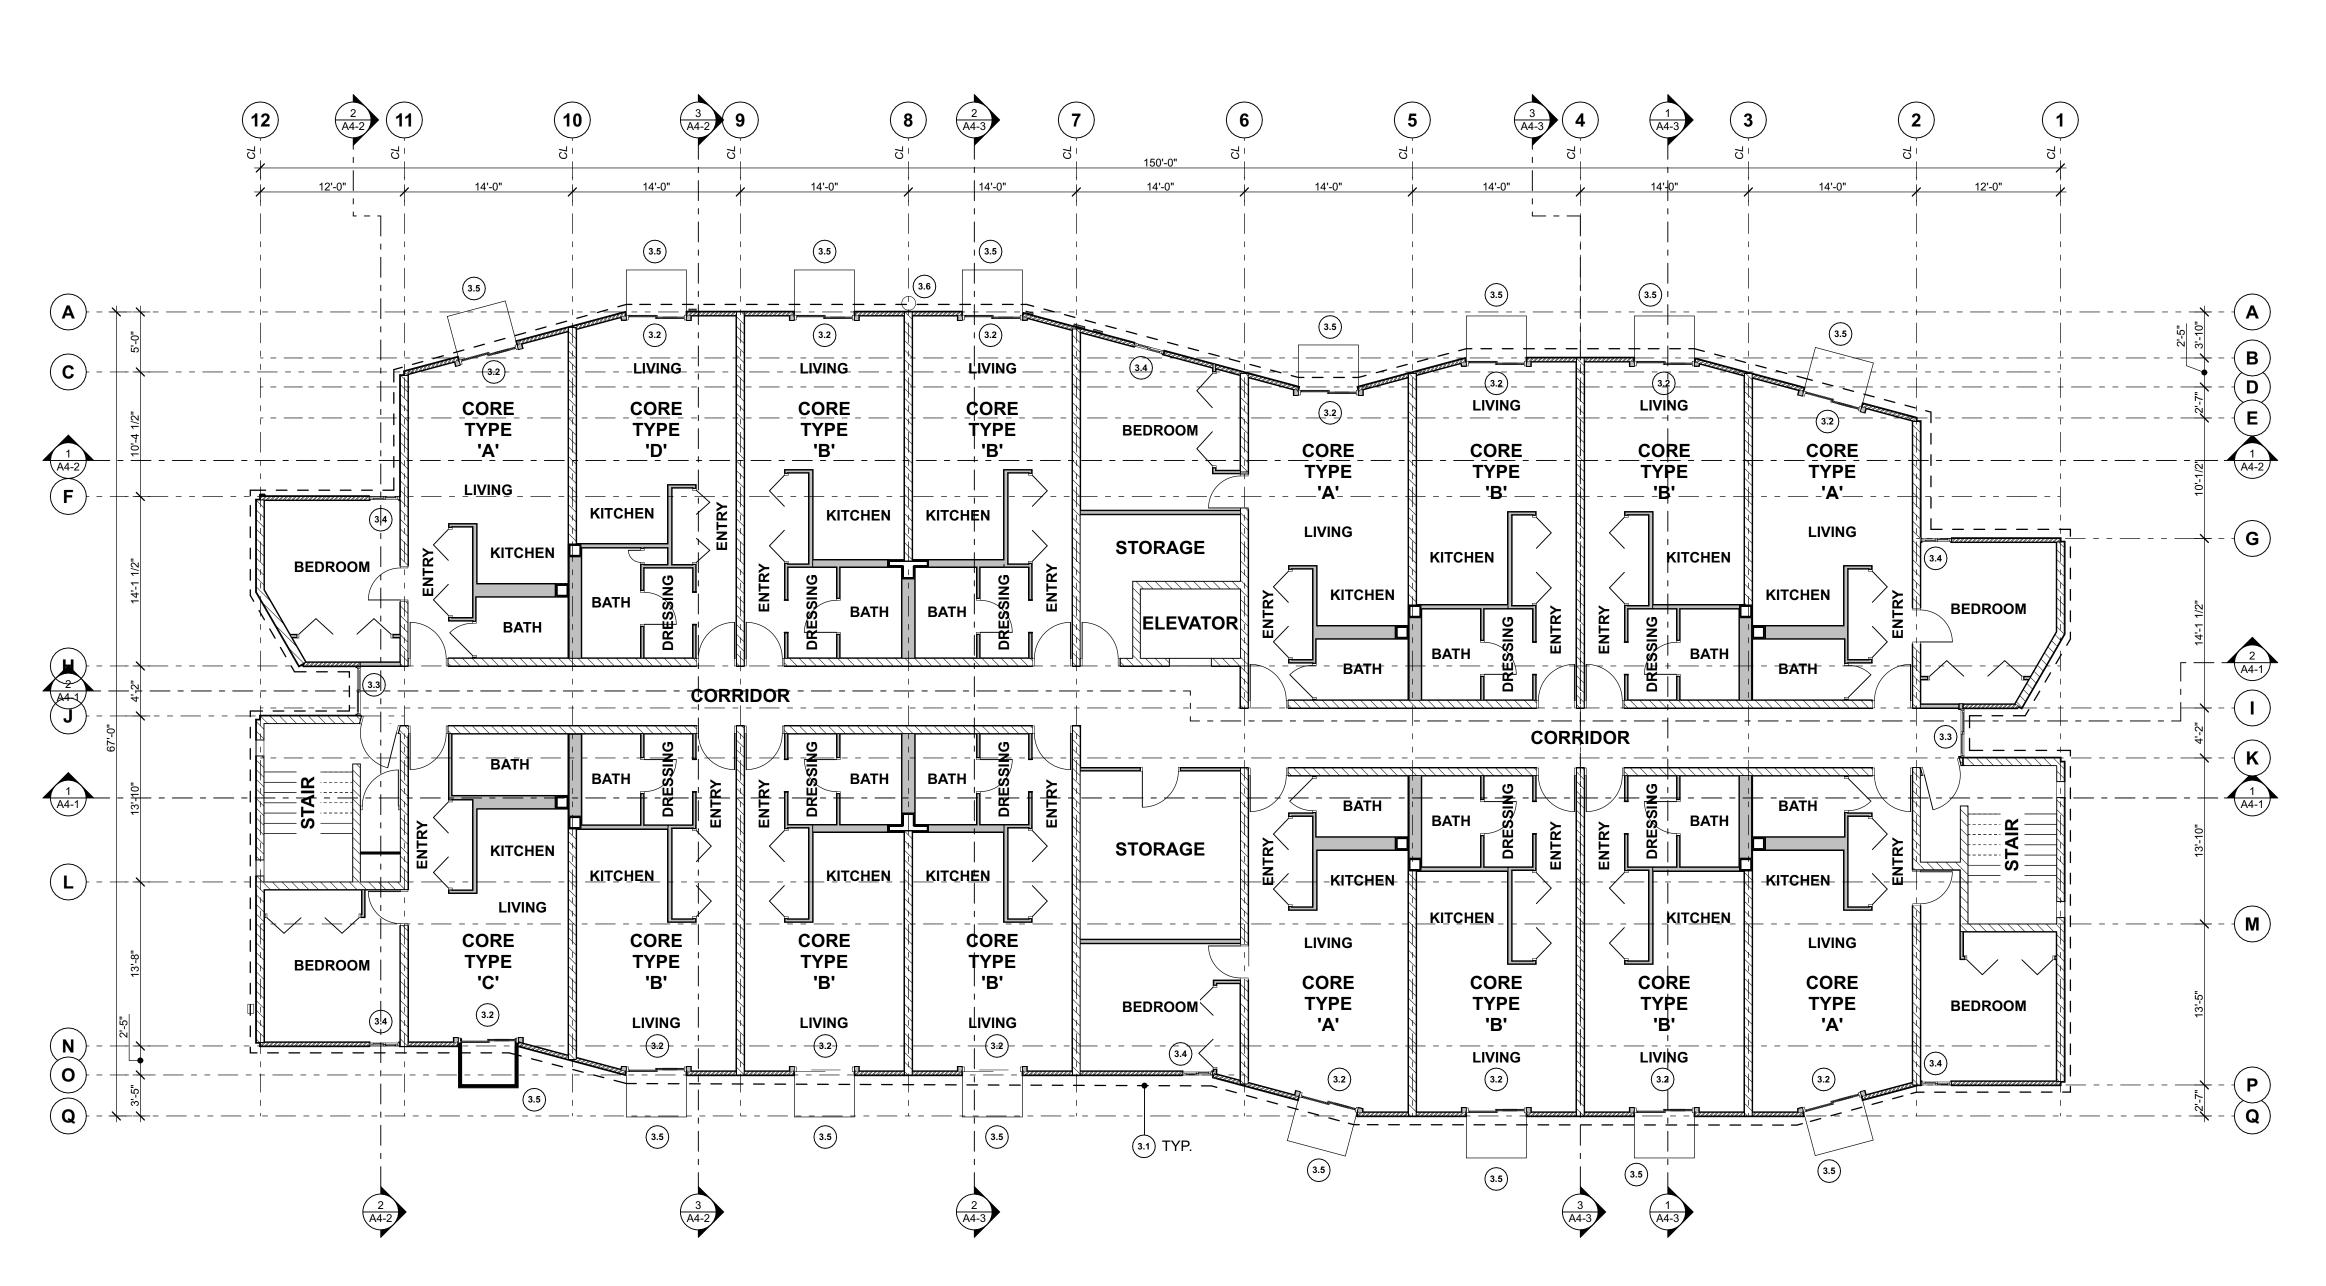

1 3RD FLOOR DEMO PLAN

1/8" = 1'-0"

AD-3

JOB NO...

23-10

DATE...

SHEET TITLE...

8/13/24

3rd Floor Demo Plan


- - - DEMOLISH EXISTING STUCCO, WEATHER BARRIER, AND ASSOCIATED TRIM.

KEY NOTES:

- DEMO EXISTING STUCCO SIDING, LATH, WEATHER BARRIER, TRIM, AND EXTERIOR SHEATHING.
- REMOVE EXISTING DOOR, DOOR FRAME, DOOR HARDWARE, DOOR THRESHOLD, AND ASSOCIATED INTERIOR TRIM.
- REMOVE EXISTING WINDOW, EXTERIOR, INTERIOR TRIM. REMOVE/SALVAGE WINDOW GUARDS, RE-INSTALL AFTER NEW WINDOWS HAVE BEEN INSTALLED.
- (4.4) REMOVE EXISTING WINDOW, EXTERIOR, INTERIOR TRIM.
- (4.5) REMOVE EXISTING DECK COATING AND DECK RAILING SYSTEM.
- REMOVE/SALVAGE EXISTING FLUE, RE-INSTALL AFTER NEW SIDING HAS BEEN INSTALLED. SEE MECHANICAL.


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- 3. REMOVE ALL EXISTING STUCCO SIDING, AIR / WEATHER BARRIER, TRIM, AND EXTERIOR SHEATHING. PRIOR TO INSTALLING NEW SHEATHING, INSULATE WALLS TO A FULL DEPTH WITH INSULATION HAVING A MINIMUM NOMINAL VALUE OF R-3.0 PER INCH.
- 4. REMOVE ALL EXISTING DOORS & WINDOWS INDICATED PER KEY NOTES 4.2 & 4.4 TO MAKE WAY FOR NEW. COORDINATE WITH OWNER ON SEQUENCING OF REPLACEMENT.
- 5. REMOVE, SALVAGE, & SAFELY STORE ALL EXISTING FIXTURES & EQUIPMENT DESIGNATED TO BE RE-USED IN THE AREA OF WORK.
- 6. CONTRACTOR TO COORDINATE REQUIRED SHUTDOWNS WITH OWNER.
- 7. NOTIFY OWNER IMMEDIATELY IF WATER DAMAGE IS OBSERVED IN THE COURSE OF THE PROJECT.
- 8. CONTRACTOR TO FIELD VERIFY ALL DIMENSIONS.
- 9. SEE MECHANICAL AND ELECTRICAL FOR ADDITIONAL DEMO WORK NOT SHOWN HERE, INCLUDING BUT NOT LIMITED TO: HVAC, PLUMBING, GAS, ELECTRIC, & CABLE UTILITIES.

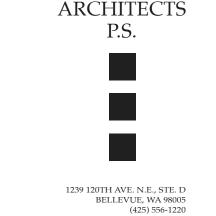


LAWHEAD

SIGNATURE...

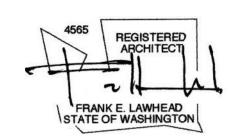

OWNER...



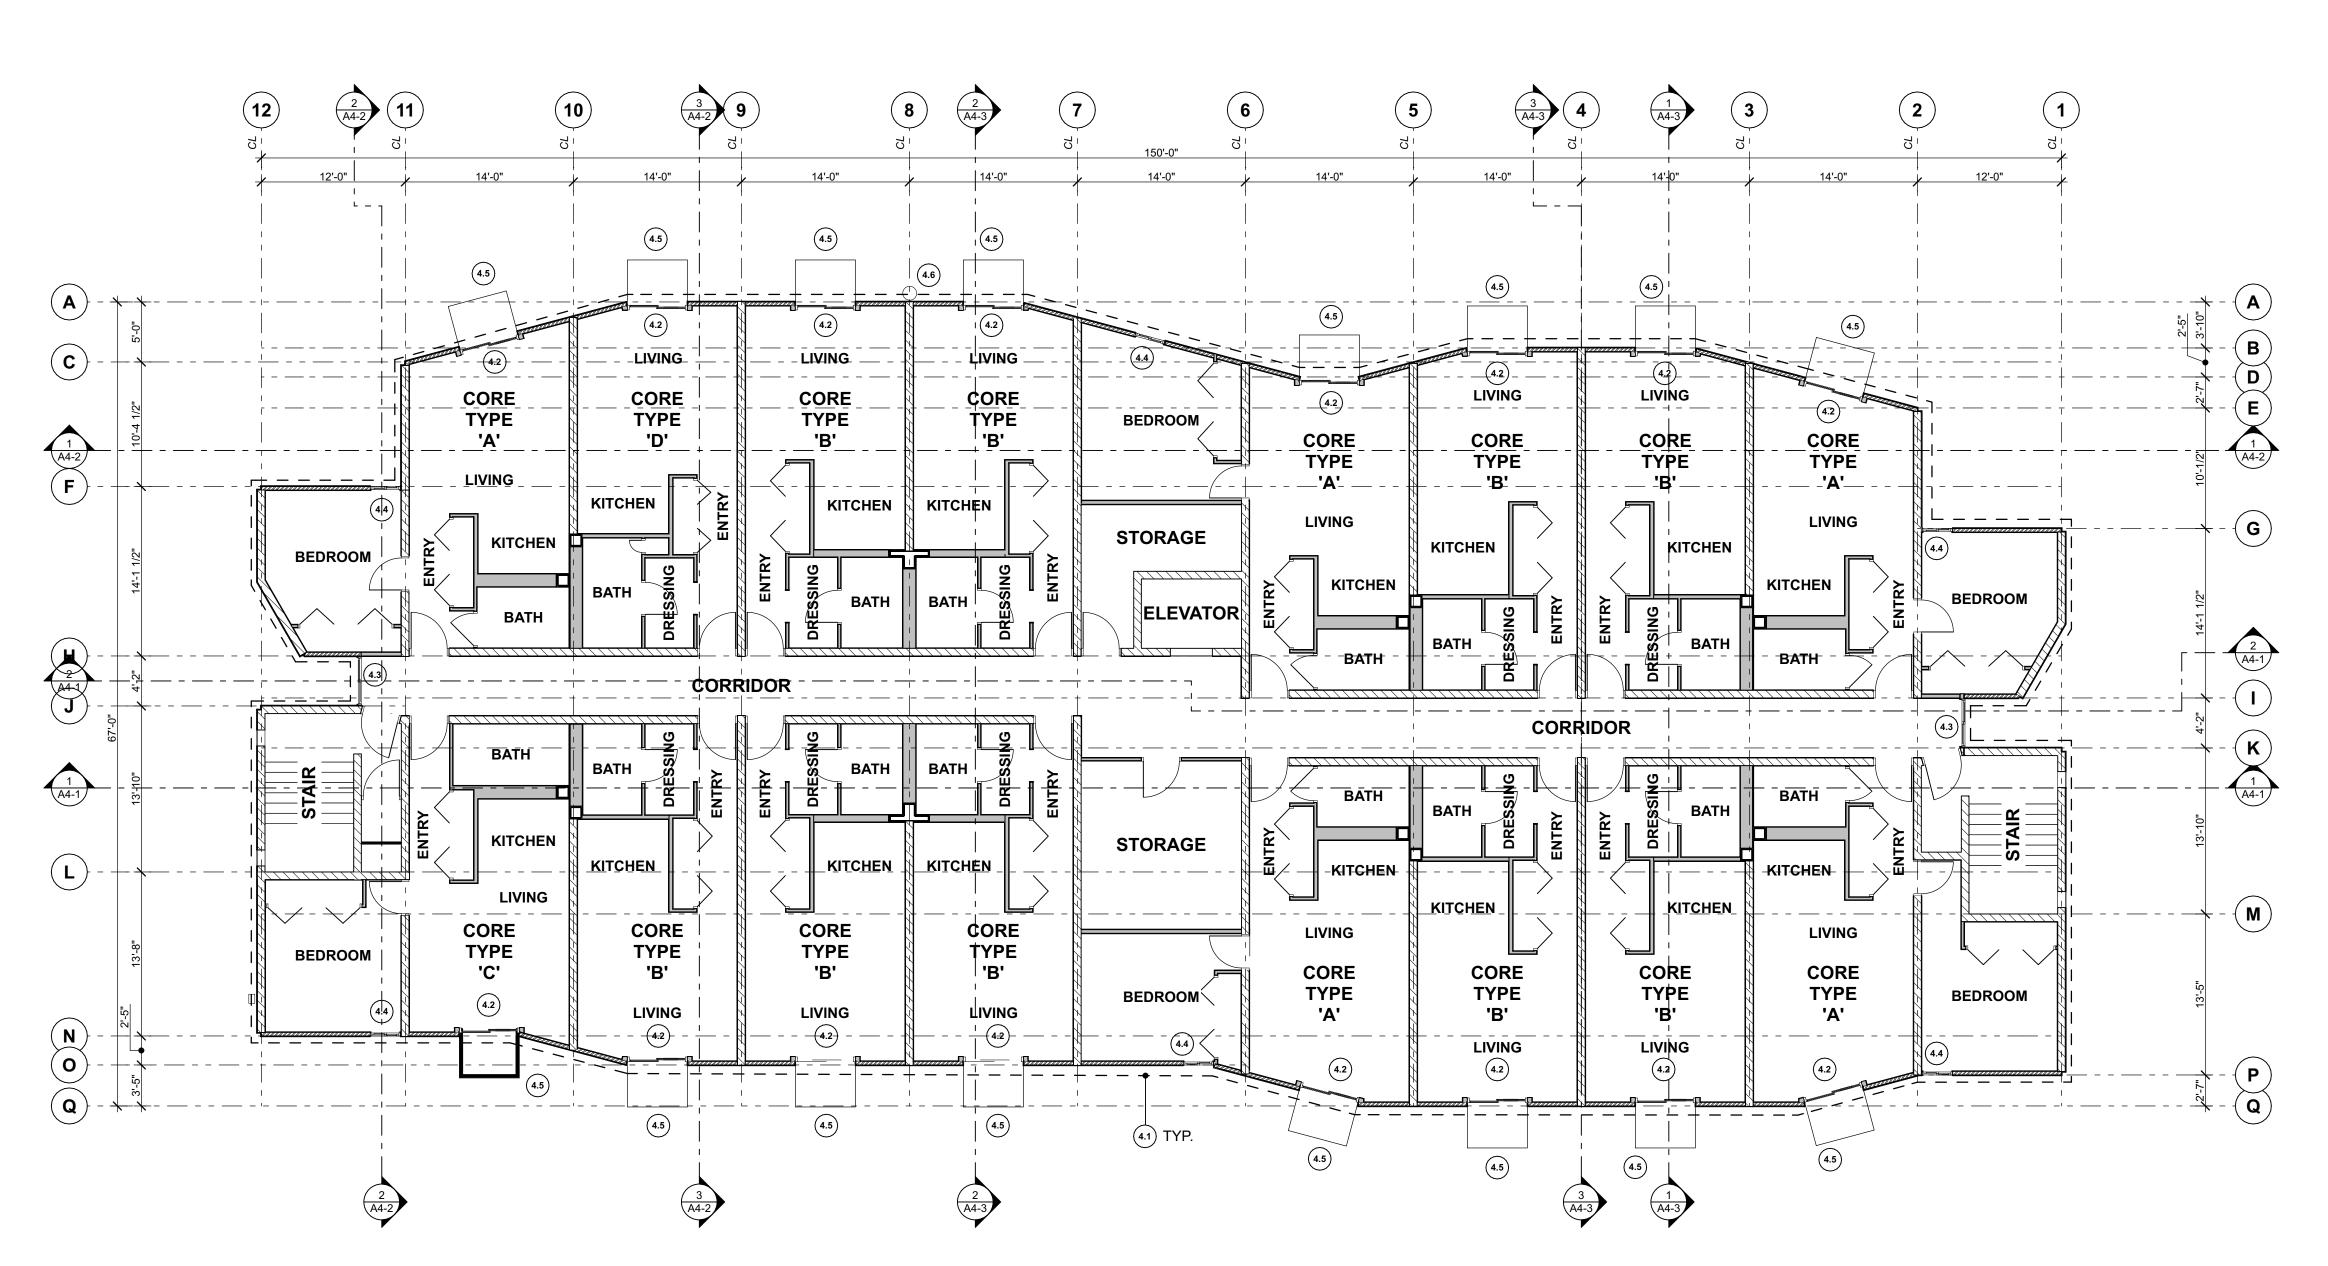

† PHASE...

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JOB NO...

DATE...

SHEET TITLE...

8/13/24

4th Floor Demo Plan

DEMO LEGEND:

 - - - DEMOLISH EXISTING STUCCO, WEATHER BARRIER, AND ASSOCIATED TRIM.

DEMOLISH EXISTING ROOF MEMBRANE, INSULATION, CONCRETE TOPPING, AND ASSOCIATED FLASHING

KEY NOTES:

- DEMO EXISTING STUCCO SIDING, LATH, WEATHER BARRIER, TRIM, AND EXTERIOR SHEATHING.
- REMOVE EXISTING ROOFING, COVER BOARD, INSULATION, FLASHING, AND CONCRETE TOPPING.
- REMOVE METAL COPING, STRIP FLASHING, COVERBOARD, WOOD PLATE AT ROOF PARAPET.
- (5.4) REMOVE EXISTING SCUPPER AND DOWNSPOUT
- (5.5) REMOVE EXISTING PIPE BOOT AND FLASHING
- (5.6) REMOVE EXISTING ONE-WAY PRESSURE RELIEF ROOF VENTS
- REMOVE EXISTING FALL ARREST SYSTEM CABLE PER OWNER DIRECTION. FALL ARREST ANCHORS TO REMAIN IN PLACE.
- SALVAGE EXISTING MECH UNIT, FLASHING, CONDUIT, AND WIRING FOR REINSTALLATION. VACUUM OUT DUCT PRIOR TO REINSTALL.
- (5.9) REMOVE EXISTING LIGHTING AND ASSOCIATED CONDUIT/CABLE
- REMOVE EXISTING DOOR, FRAME, THRESHOLD, AND RELATED HARDWARE. NEW DOOR & FRAME TO BE INSTALLED.
- (5.11) REMOVE EXISTING ANTENNA MAST
- (5.12) PROTECT AND MAINTAIN EXISTING FIRE SPRINKLER STANDPIPE.
- REMOVE/SALVAGE EXISTING FLUE, RE-INSTALL AFTER NEW SIDING HAS BEEN INSTALLED. SEE MECHANICAL.


GENERAL NOTES:

- CONTRACTOR IS RESPONSIBLE FOR MAINTAINING SAFE & SECURE ACCESS TO TENANTS IN CONSTRUCTION AREAS AT ALL TIMES.
- ASBESTOS-CONTAINING MATERIALS (ACM) HAVE BEEN IDENTIFIED IN STUCCO CLADDING. COORDINATE WITH OWNER FOR COPY OF HAZ-MAT REPORT AND PLAN FOR HAZARDOUS MATERIALS ABATEMENT.
- 3. REMOVE ALL EXISTING STUCCO SIDING, AIR / WEATHER BARRIER, TRIM, AND EXTERIOR SHEATHING. PRIOR TO INSTALLING NEW SHEATHING, INSULATE WALLS TO A FULL DEPTH WITH INSULATION HAVING A MINIMUM NOMINAL VALUE OF R-3.0 PER INCH.
- 4. REMOVE ALL EXISTING DOORS & WINDOWS TO MAKE WAY FOR NEW. COORDINATE WITH OWNER ON SEQUENCING OF REPLACEMENT.
- 5. REMOVE EXISTING ROOFING, INSULATION, FLASHING, AND CONCRETE TOPPING DOWN TO EXISTING CONCRETE ROOF DECK SURFACE.
- 6. REMOVE, SALVAGE, & SAFELY STORE ALL EXISTING FIXTURES & EQUIPMENT DESIGNATED TO BE RE-USED IN THE AREA OF WORK.
- 7. CONTRACTOR TO COORDINATE REQUIRED SHUTDOWNS WITH OWNER.
- 8. NOTIFY OWNER IMMEDIATELY IF WATER DAMAGE IS OBSERVED IN THE COURSE OF THE PROJECT.
- 9. CONTRACTOR TO FIELD VERIFY ALL DIMENSIONS.
- 10. SEE MECHANICAL AND ELECTRICAL FOR ADDITIONAL DEMO WORK NOT SHOWN HERE, INCLUDING BUT NOT LIMITED TO: HVAC, PLUMBING, GAS, ELECTRIC, & CABLE UTILITIES.



LAWHEAD

SIGNATURE...

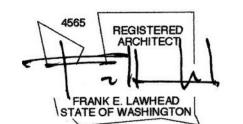

OWNER...



(6) **(c)** 5.6 1 A4-2 **F** FRESH AIR INTAKE 14'-1 1/2" **EF-9**(5.8) 5.8 (5.5) 5.2 (5.12) (5.8) (O) (5.5) (5.7) 1 A4-1 5.5 5.8 EF-8 (5.5) (5.8) (5.8) (5.8) 5.5 (5.6) 5.6 5.6 NO 5.1 TYP. 5.3

1/8" = 1'-0"

JOB NO...


PHASE...

23-10


DATE...
8/13/24

SHEET TITLE...


BUILDING PHOTO (STAIRWELL @ ROOFTOP)

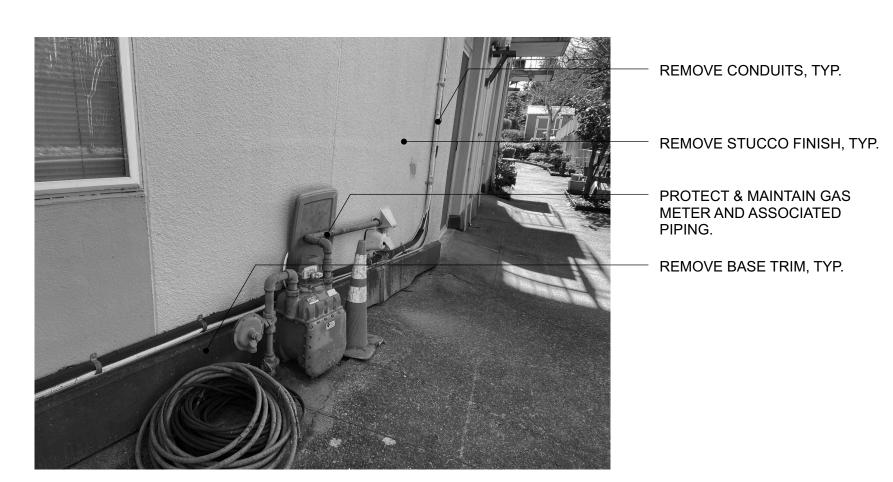


4 BUILDING PHOTO

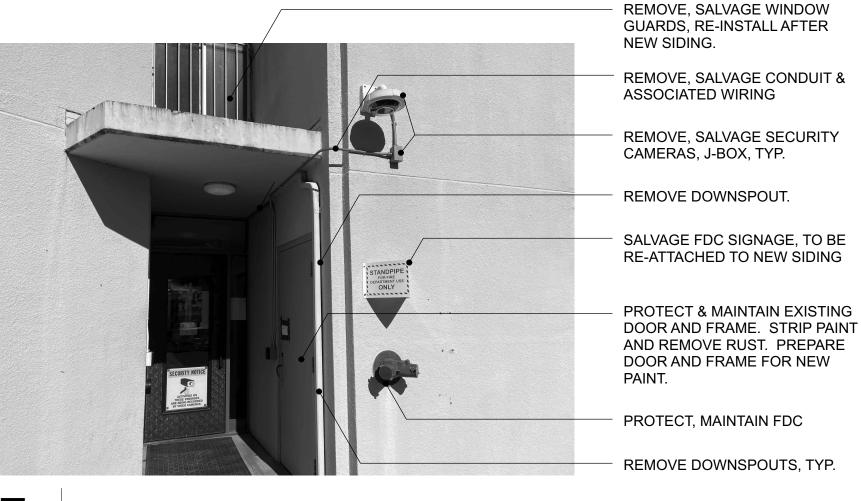


BUILDING PHOTO (SOUTH BUILDING ENTRANCE)

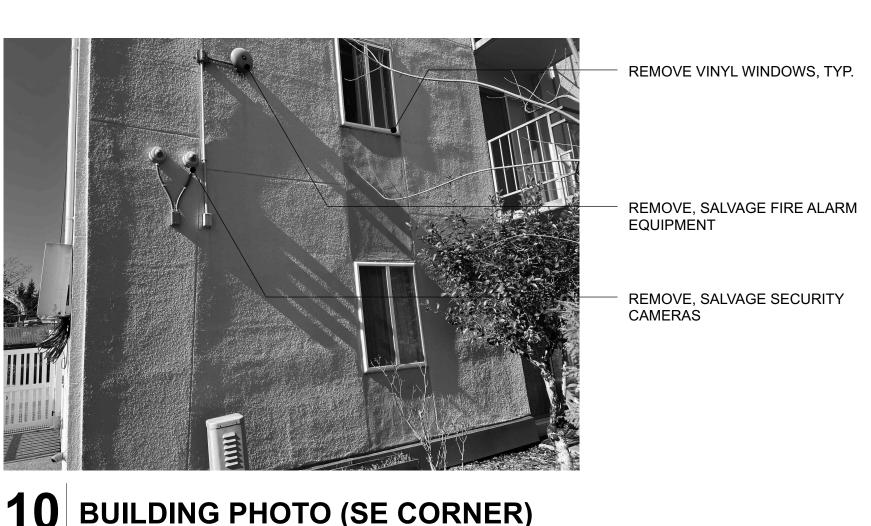

10 BUILDING PHOTO (SE CORNER)

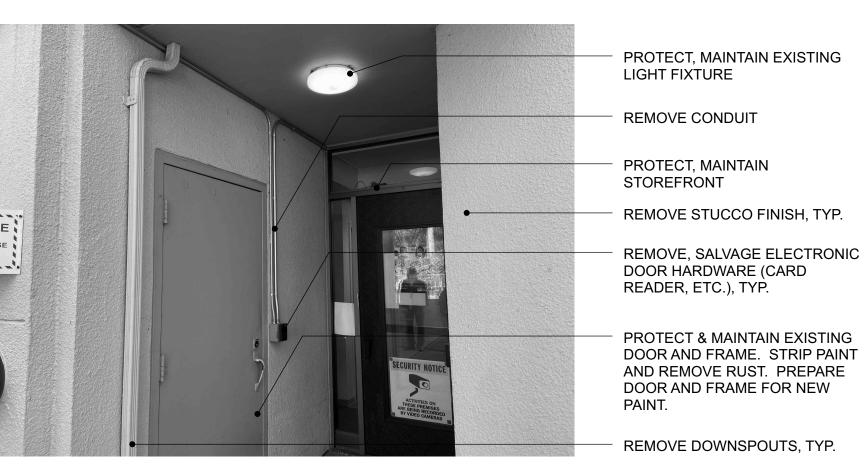

BUILDING PHOTO (NORTH ENTRANCE)

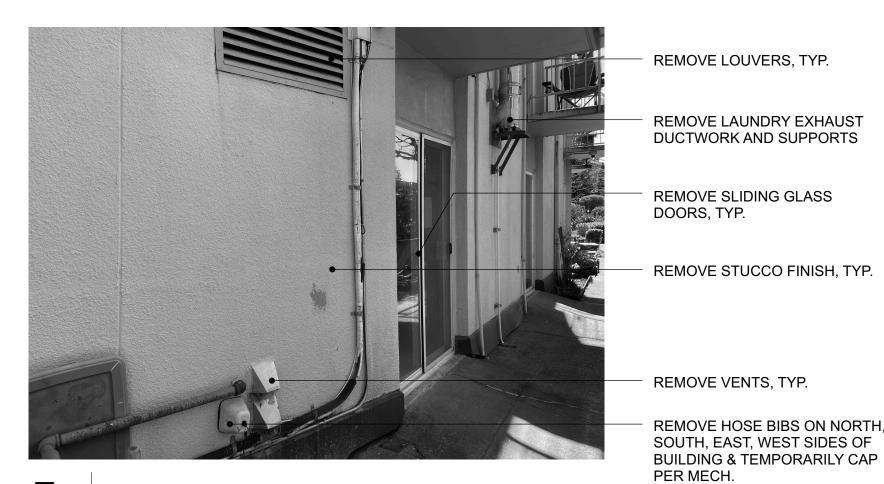

REMOVE TELECOMMUNICATION

BOXES AND ASSOCIATED

WIRING AND CABLING, TYP.
SALVAGE BOXES FOR
REINSTALLATION.

PROTECT AND MAINTAIN

ESCUTCHEON AND PIPE

REMOVE HOSE BIB &

TEMPORARILY CAP PER MECH.


REMOVE STUCCO FINISH, TYP.

PROTECT & MAINTAIN EXISTING DOOR AND FRAME. STRIP PAINT

AND REMOVE RUST. BONDO DENTS. PREPARE DOOR AND

FRAME FOR NEW PAINT.

BUILDING PHOTO

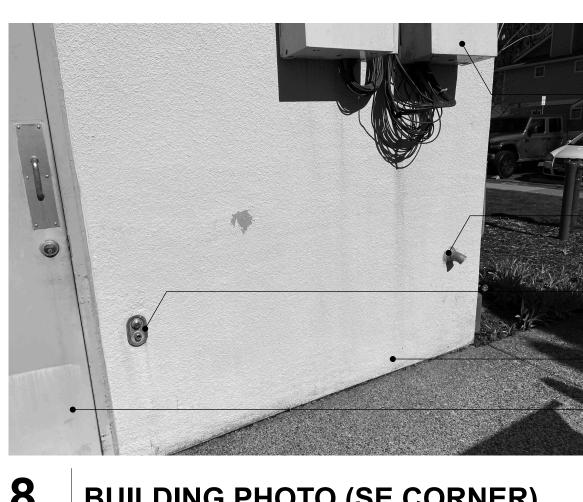


BUILDING PHOTO (SE CORNER)



11 BUILDING PHOTO



BUILDING PHOTO (NORTH ENTRANCE)

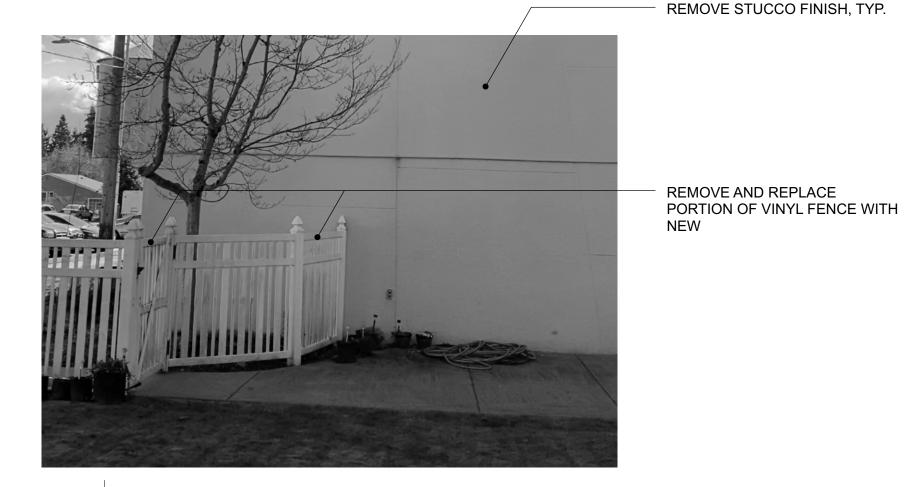

BUILDING PHOTO (NORTH FENCE)



REMOVE STUCCO FINISH, TYP.

REMOVE AND REPLACE PORTION OF VINYL FENCE WITH

BUILDING PHOTO (SOUTH FENCE)



REMOVE SLIDING GLASS DOORS, TYP.

DECK WALLS, TYP. REMOVE ANGLED WINDOW

ADJACENT TO UNIT SLIDING GLASS DOOR


REMOVE VINYL WINDOWS, TYP.

REMOVE HOSE BIBS ON NORTH, SOUTH, EAST, WEST SIDES OF BUILDING & TEMPORARILY CAP

12 BUILDING PHOTO (MAIN EAST ENTRANCE)

LAWHEAD ARCHITECTS

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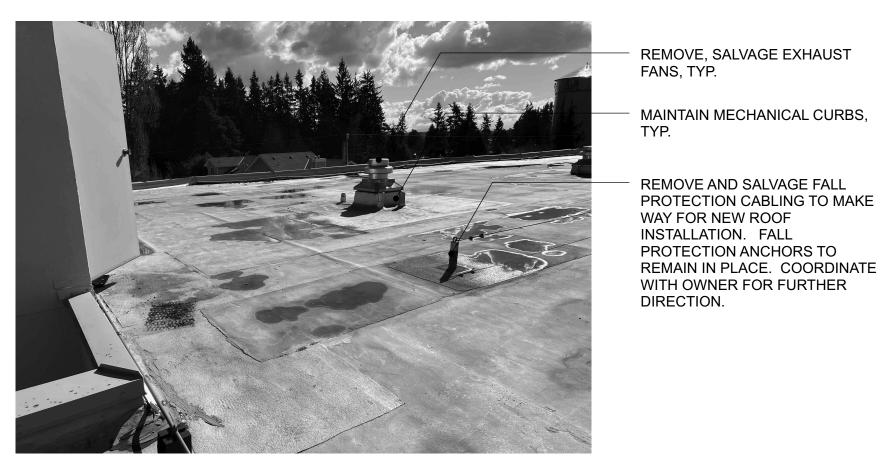


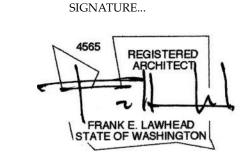JOB NO... 23-10 DATE... 8/13/24

SHEET TITLE... **Elevation Demo Photos**

SHEET NO...

ROOF PHOTO (SE CORNER)



4 ROOF PHOTO



ROOF PHOTO



10 ROOF PHOTO



ROOF PHOTO



ROOF PHOTO

REMOVE ROOFING, COVER BOARD, INSULATION, & CONCRETE TOPPING, TYP.

REMOVE, SALVAGE MECHANICAL VENTS, TYP.

MAINTAIN MECHANICAL CURBS, TYP.



ROOF PHOTO



11 ROOF PHOTO



ROOF PHOTO

REMOVE CONDUITS AND CABLING, TYP.

REMOVE FLASHING & WOOD PLATE, TYP.

FIRE SPRINKLER RISER TO REMAIN, PROTECT & AVOID DAMAGING DURING DEMOLITION.

REMOVE CONDUIT AND WIRING, TYP.



ROOF PHOTO




ROOF PHOTO



12 ROOF PHOTO





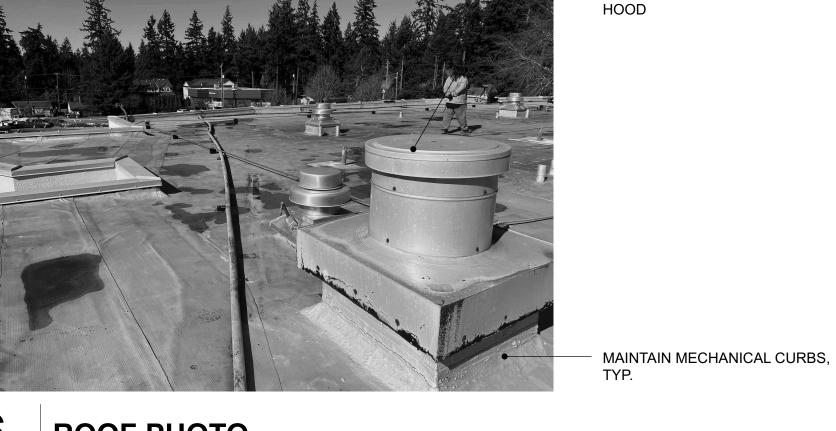

REMOVE ONE-WAY PRESSURE RELIEF ROOF VENTS, TYP.




REMOVE, SALVAGE EXTERIOR LIGHTING FIXTURES

REMOVE CONDUIT AND CABLING, TYP.

LAWHEAD ARCHITECTS 1239 120TH AVE. N.E., STE. D BELLEVUE, WA 98005

SIGNATURE...

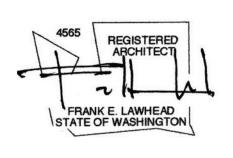

OWNER...



JOB NO...

23-10

DATE...

8/13/24

SHEET TITLE...

Roof Demo Photos

AD-7

TYPE 1 – FIBER CEMENT PANEL OVER 8" CMU EXISTING:

> - ±3/4" STUCCO (DEMO.); - 8" STRUCTURAL CMU BLOCK; - 5/8" GYPSUM WALLBOARD, IN UNITS;

PROPOSED:

- 5/16" FIBER CEMENT PANEL & ALUM. REVEAL TRIM SYSTEM, PAINT: - 1 1/2" DEEP 16 GA. GALV. Z-GIRT FURRING STRIPS @ 16" O.C., PER STRUCT.; - 1" MINERAL WOOL INSUL.;

- SELF-ADHERED AIR / WEATHER BARRIER; - 8" STRUCTURAL CMU BLOCK;

- 5/8" GYPSUM WALLBOARD, IN UNITS;

TYPE 2 – FIBER CEMENT PANEL OVER 3 5/8" MTL. FRAMING (NO EXIST. SHEATHING) **EXISTING:**

- ±3/4" STUCCO (DEMO.); - 3 5/8" 18 GA. LIGHT GA. MTL. FRAMING @19.2" O.C.; - 5/8" GYPSUM WALLBOARD;

PROPOSED:

- 5/16" FIBER CEMENT PANEL & ALUM. REVEAL TRIM SYSTEM, PAINT; - 1 1/2" DEEP 16 GA. GALV. Z-GIRT FURRING STRIPS @ 16" O.C., PER STRUCT.; - 1" MINERAL WOOL INSUL.; - SELF-ADHERED AIR / WEATHER BARRIER; - 1/2" FIBERGLASS REINFORCED GYPSUM SHEATHING: - 3 5/8" 18 GA. LIGHT GA. MTL. BLOCKING @12" O.C. PER STRUCT.; FIBERGLASS BATT INSULATION, FULL CAVITY DEPTH = R-15;

- 3 5/8" 18 GA. LIGHT GA. MTL. FRAMING @19.2" O.C.; - 5/8" GYPSUM WALLBOARD;

TYPE 3 – FIBER CEMENT PANEL OVER 2x4 FRAMING **EXISTING:**

- ±3/4" STUCCO (DEMO.); - METAL LATH W/ PAPER BACKING (DEMO.); - 1/2" GYPSUM SHEATHING (DEMO.); - 2x4 WOOD STUDS @ 16" O.C.; - 5/8" GYPSUM WALLBOARD;

PROPOSED:

- 5/16" FIBER CEMENT PANEL & ALUM. REVEAL TRIM SYSTEM, PAINT; - 1 1/2" DEEP 16 GA. GALV. Z-GIRT FURRING STRIPS @ 16" O.C., PER STRUCT.; - 1" MINERAL WOOL INSUL: - SELF-ADHERED AIR / WEATHER BARRIER; - 1/2" FIBERGLASS REINFORCED GYPSUM SHEATHING; - 2x4 WOOD BLOCKING SUPPORTS

TURNED FLAT @16" O.C. VERTICAL; - FIBERGLASS BATT INSULATION, FULL CAVITY DEPTH = R-15:

- 2x4 WOOD STUDS @ 16" O.C.; - 5/8" GYPSUM WALLBOARD;

TYPE 4 - FIBER CEMENT PANEL AT PATCHED STOREFRONT WINDOW

EXISTING:

- ALUM. STOREFRONT WINDOW (DEMO.);

- 5/16" FIBER CEMENT PANEL & ALUM. REVEAL TRIM SYSTEM, PAINT; - 1 1/2" DEEP 16 GA. GALV. Z-GIRT FURRING STRIPS @ 16" O.C., PER STRUCT.; - 1" MINERAL WOOL INSUL. - SELF-ADHERED AIR / WEATHER BARRIER: - 1/2" FIBERGLASS REINFORCED GYPSUM SHEATHING; - 2x4 WOOD STUDS @ 16" O.C.; - FIBERGLASS BATT INSULATION, FULL CAVITY DEPTH = R-15; - INTERIOR VAPOR BARRIER; - 5/8" GYPSUM WALLBOARD, PAINT;

TYPE 5 – FIBER CEMENT LAP SIDING OVER 8" CMU **EXISTING:**

- ±3/4" STUCCO (DEMO. WHERE PRESENT); - 8" STRUCTURAL CMU BLOCK; - 5/8" GYPSUM WALLBOARD, IN UNITS;

- 1/2" GYPSUM SHEATHING (DEMO.); - 2x4 WOOD STUDS @ 16" O.C.; - 5/8" GYPSUM WALLBOARD; - 5/16" FIBER CEMENT LAP SIDING, PAINT; - 3/4" DEEP 16 GA. GALV. STEEL Z-GIRT PROPOSED: VERTICAL FURRING STRIPS @ 16" O.C.; - 1" MINERAL WOOL INSUL. COMPRESSED - 5/16" FIBER CEMENT LAP SIDING, PAINT; WITHIN CAVITY; - 1x4 NATURALLY DECAY-RESISTANT

- 8" STRUCTURAL CMU BLOCK; - 5/8" GYPSUM WALLBOARD, IN UNITS;

- SELF-ADHERED AIR / WEATHER BARRIER;

TYPE 6 – FIBER CEMENT LAP SIDING OVER 3 5/8" MTL. FRAMING (NO EXIST. SHEATHING) **EXISTING:**

- ±3/4" STUCCO (DEMO.); - 3 5/8" 18 GA. LIGHT GA. MTL. FRAMING - 5/8" GYPSUM WALLBOARD;

PROPOSED:

- 5/16" FIBER CEMENT LAP SIDING, PAINT; - 3/4" DEEP 16 GA. GALV. STEEL Z-GIRT VERTICAL FURRING STRIPS @ EA. STUD; - 1" MINERAL WOOL INSUL. COMPRESSED WITHIN CAVITY; - SELF-ADHERED AIR / WEATHER BARRIER; - 1/2" FIBERGLASS REINFORCED GYPSUM SHEATHING: - FIBERGLASS BATT INSULATION, FULL CAVITY DEPTH = R-15;

- 3 5/8" 18 GA. LIGHT GA. MTL. FRAMING - 5/8" GYPSUM WALLBOARD;

TYPE 7 – FIBER CEMENT LAP SIDING OVER EXISTING:

WOOD W/ SPECIFIC GRAVITY ≥0.42

- 1/2" CDX PLYWOOD SHEATHING;

- FIBERGLASS BATT INSULATION,

FULL CAVITY DEPTH = R-15;

- 2x4 WOOD STUDS @ 16" O.C.;

- 5/8" GYPSUM WALLBOARD;

TYPE 8 – FIBER CEMENT LAP SIDING OVER

- ±3/4" STUCCO (DEMO.);

- 2x4 WOOD STUDS @ 16" O.C.;

- 5/8" GYPSUM WALLBOARD;

2x4 FRAMING (NO EXIST. SHEATHING)

WITHIN CAVITY;

EXISTING:

PROPOSED:

WITHIN CAVITY:

VERTICAL FURRING STRIPS @ EA. STUD;

- SELF-ADHERED AIR / WEATHER BARRIER;

- METAL LATH W/ PAPER BACKING (DEMO.);

- 5/16" FIBER CEMENT LAP SIDING, PAINT;

VERTICAL FURRING STRIPS @ EA. STUD;

- 1" MINERAL WOOL INSUL. COMPRESSED

- SELF-ADHERED AIR / WEATHER BARRIER;

- 1x4 NATURALLY DECAY-RESISTANT

- 1/2" CDX PLYWOOD SHEATHING;

- FIBERGLASS BATT INSULATION,

FULL CAVITY DEPTH = R-15;

- 2x4 WOOD STUDS @ 16" O.C.; - 5/8" GYPSUM WALLBOARD;

WOOD W/ SPECIFIC GRAVITY ≥0.42

- 1" MINERAL WOOL INSUL. COMPRESSED

LENGTH OF A WALL WHETHER EXPLICITLY TAGGED OR NOT, REGARDLESS OF INTERSECTIONS WITH INTERMEDIATE WALLS, CHANGE OF FINISH OR - ±3/4" STUCCO (DEMO.); - METAL LATH W/ PAPER BACKING (DEMO.); CLADDING, OR CHANGE IN HEIGHT.

WHERE A WALL TYPE CHANGES WITHIN THE LENGTH OF A WALL, EITHER BY TYPE OR MODIFIER, THE TAG STARTS AT THE NEAREST INTERMEDIATE CORNER, AND CONTINUES FOR THE REMAINING LENGTH OF WALL, UNLESS SUBSEQUENTLY MODIFIED BY ANOTHER WALL

WALL TYPES GENERAL NOTES

1) WALL TYPE TAGS APPLY TO THE FULL CONTINUOUS

2) WALL TYPES DEFINED HERE DO NOT SUPERSEDE **OTHER REQUIREMENTS STATED ELSEWHERE IN THE** DOCUMENTS. REFER TO ALL DRAWINGS & SPECIFICATIONS OF ALL DISCIPLINES FOR MINIMUM WALL CRITERIA.

3) REFER TO OWNER'S HAZARDOUS MATERIALS REPORT AND ABATEMENT PLANS FOR REMOVAL OF ASBESTOS

4) FIELD VERIFY ALL EXISTING SUBSTRATE MATERIALS. IMMEDIATELY NOTIFY THE ARCHITECT OR OWNER'S REPRESENTATIVE OF ANY DISCREPANCIES FOUND.


CONTAINING MATERIALS.

5) DO NOT USE POWDER-ACTUATED FASTENERS (PAFS) TO SECURE CLADDING TO CMU SUBSTRATE. REFER TO STRUCTURAL FOR ADDITIONAL INFORMATION ON RAINSCREEN FURRING ATTACHMENT.


6) AT ALL WALLS WHERE WALL TYPE CHANGES WITHIN A CONTIGUOUS PLANE, ADD ADDITIONAL LAYERS OF SHEATHING TO CREATE FLUSH SURFACE FOR CLADDING;

GENERAL NOTES:

1. ALL DIMENSIONS ARE TO FACE OF FRAMING OR FACE OF BLOCK U.N.O. FIELD VERIFY ALL EXISTING DIMENSIONS.

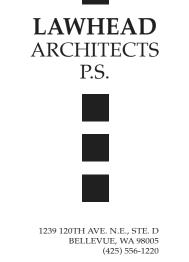


SIGNATURE...

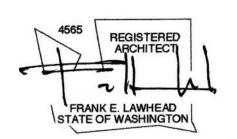

OWNER...



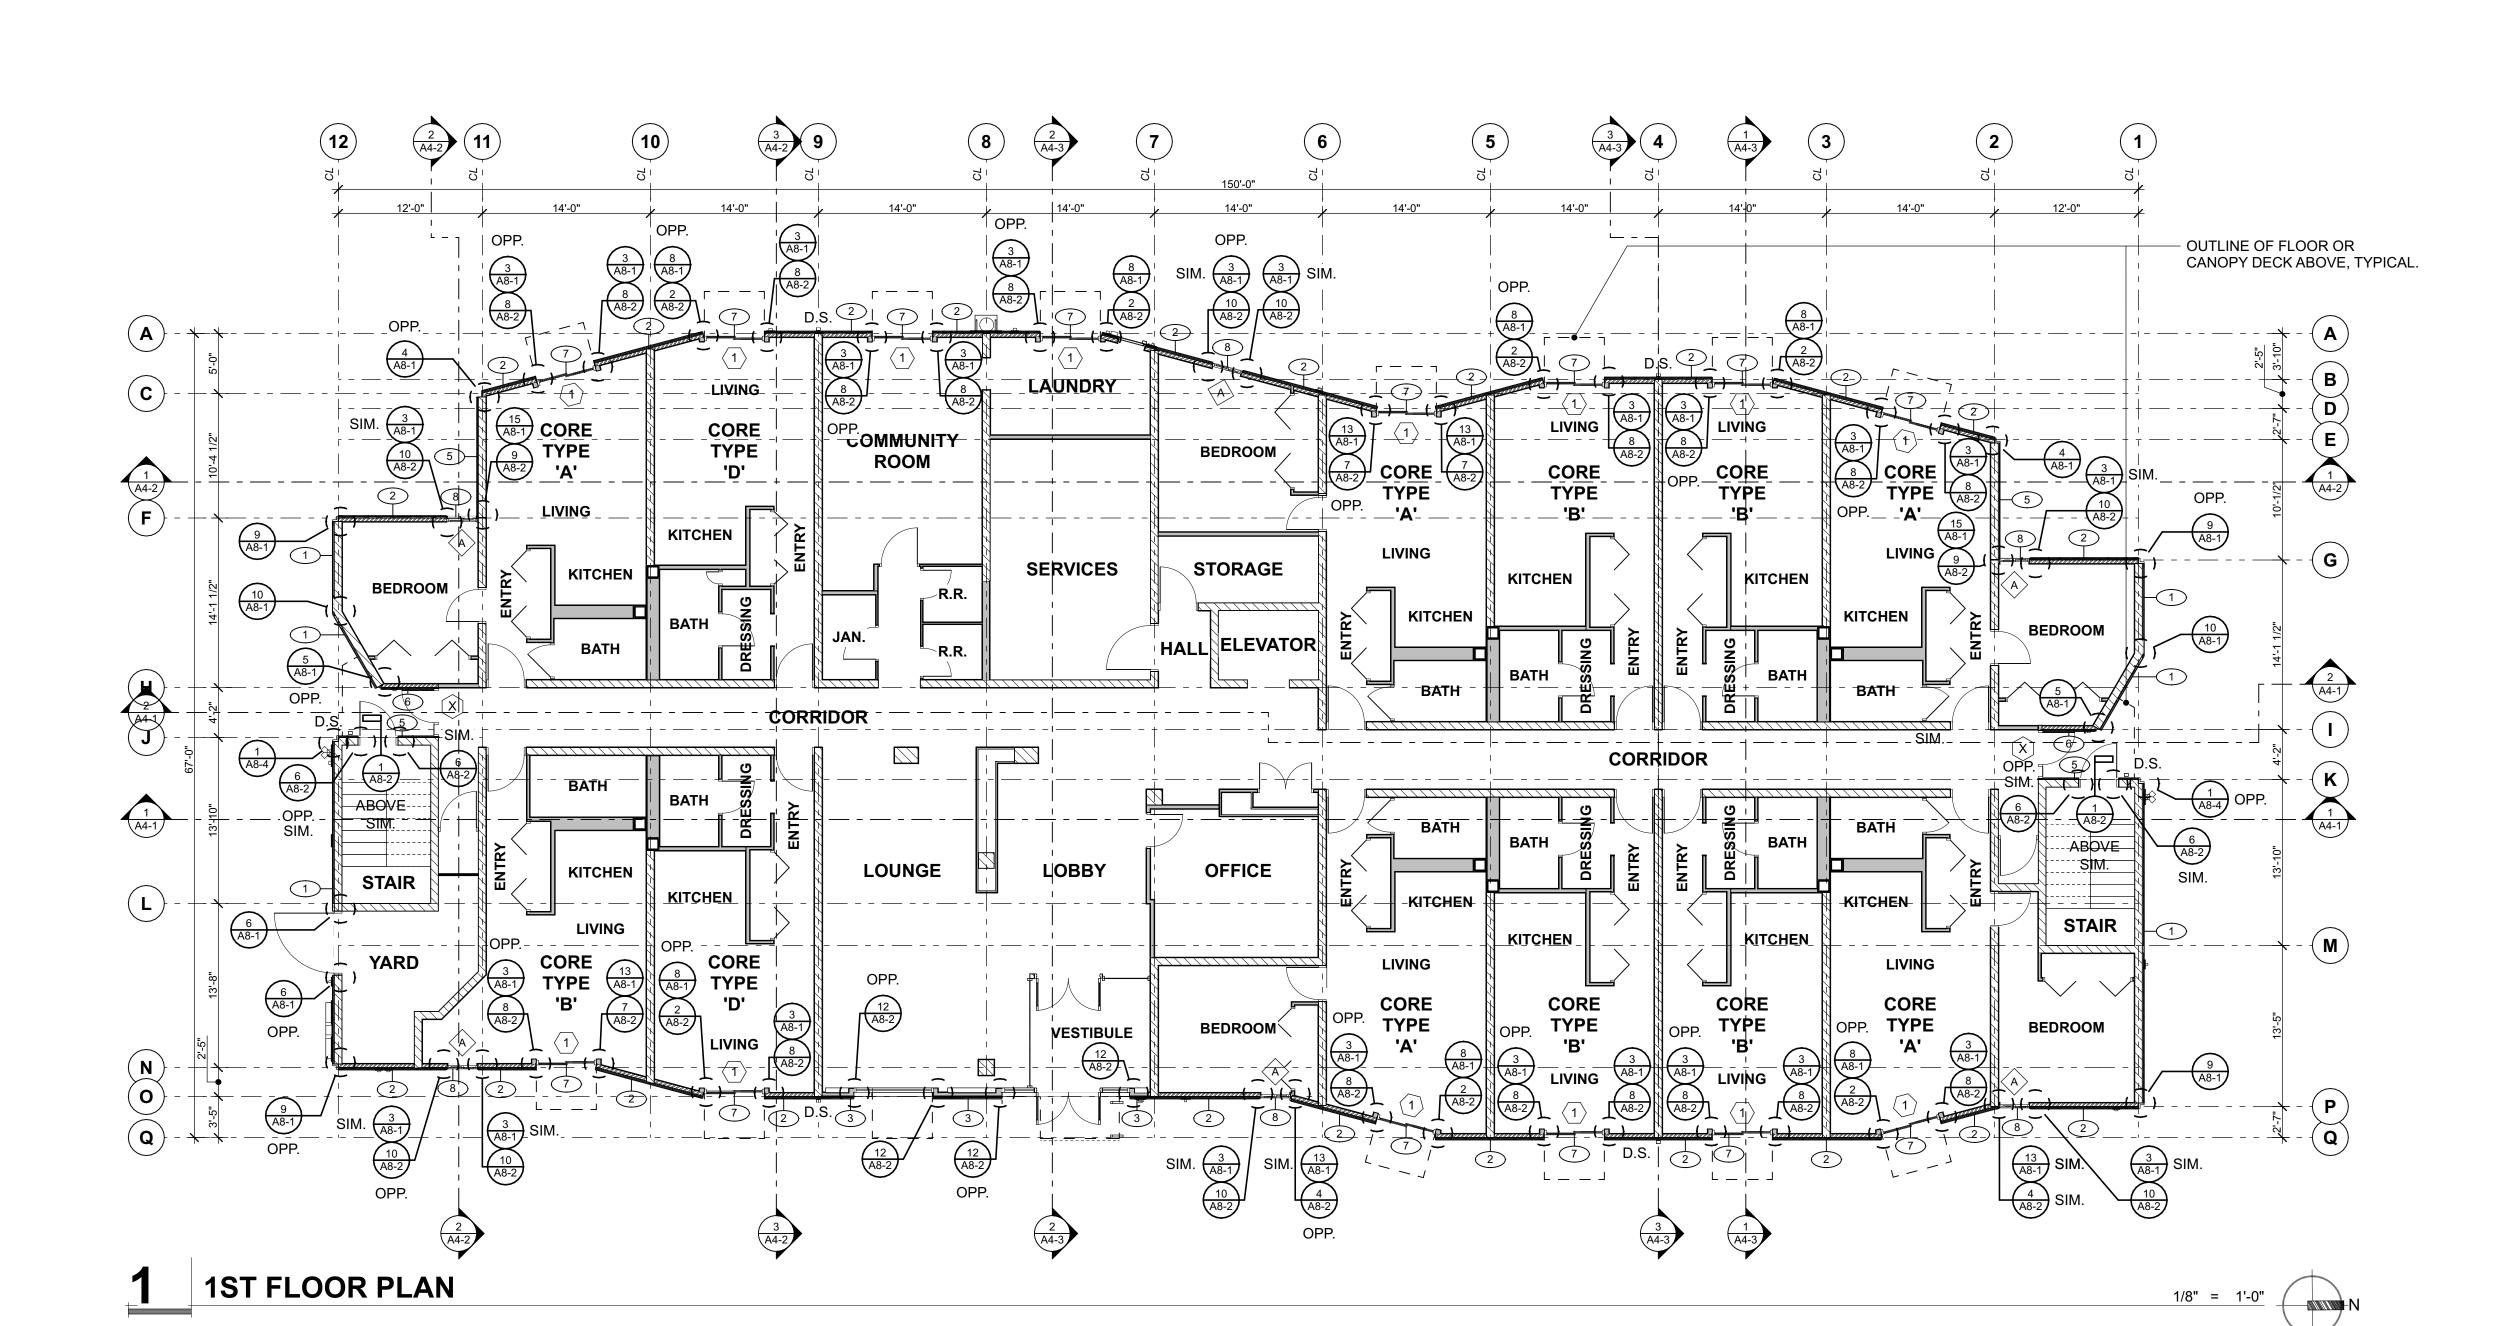


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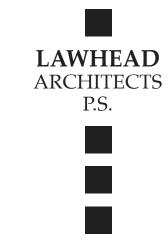
8/13/24

SHEET TITLE...


1st Floor Plan



- ALL DIMENSIONS ARE TO FACE OF FRAMING OR FACE OF BLOCK U.N.O. FIELD VERIFY ALL EXISTING DIMENSIONS.
- 2. SEE SHEET A2-1 FOR WALL TYPES LEGEND.

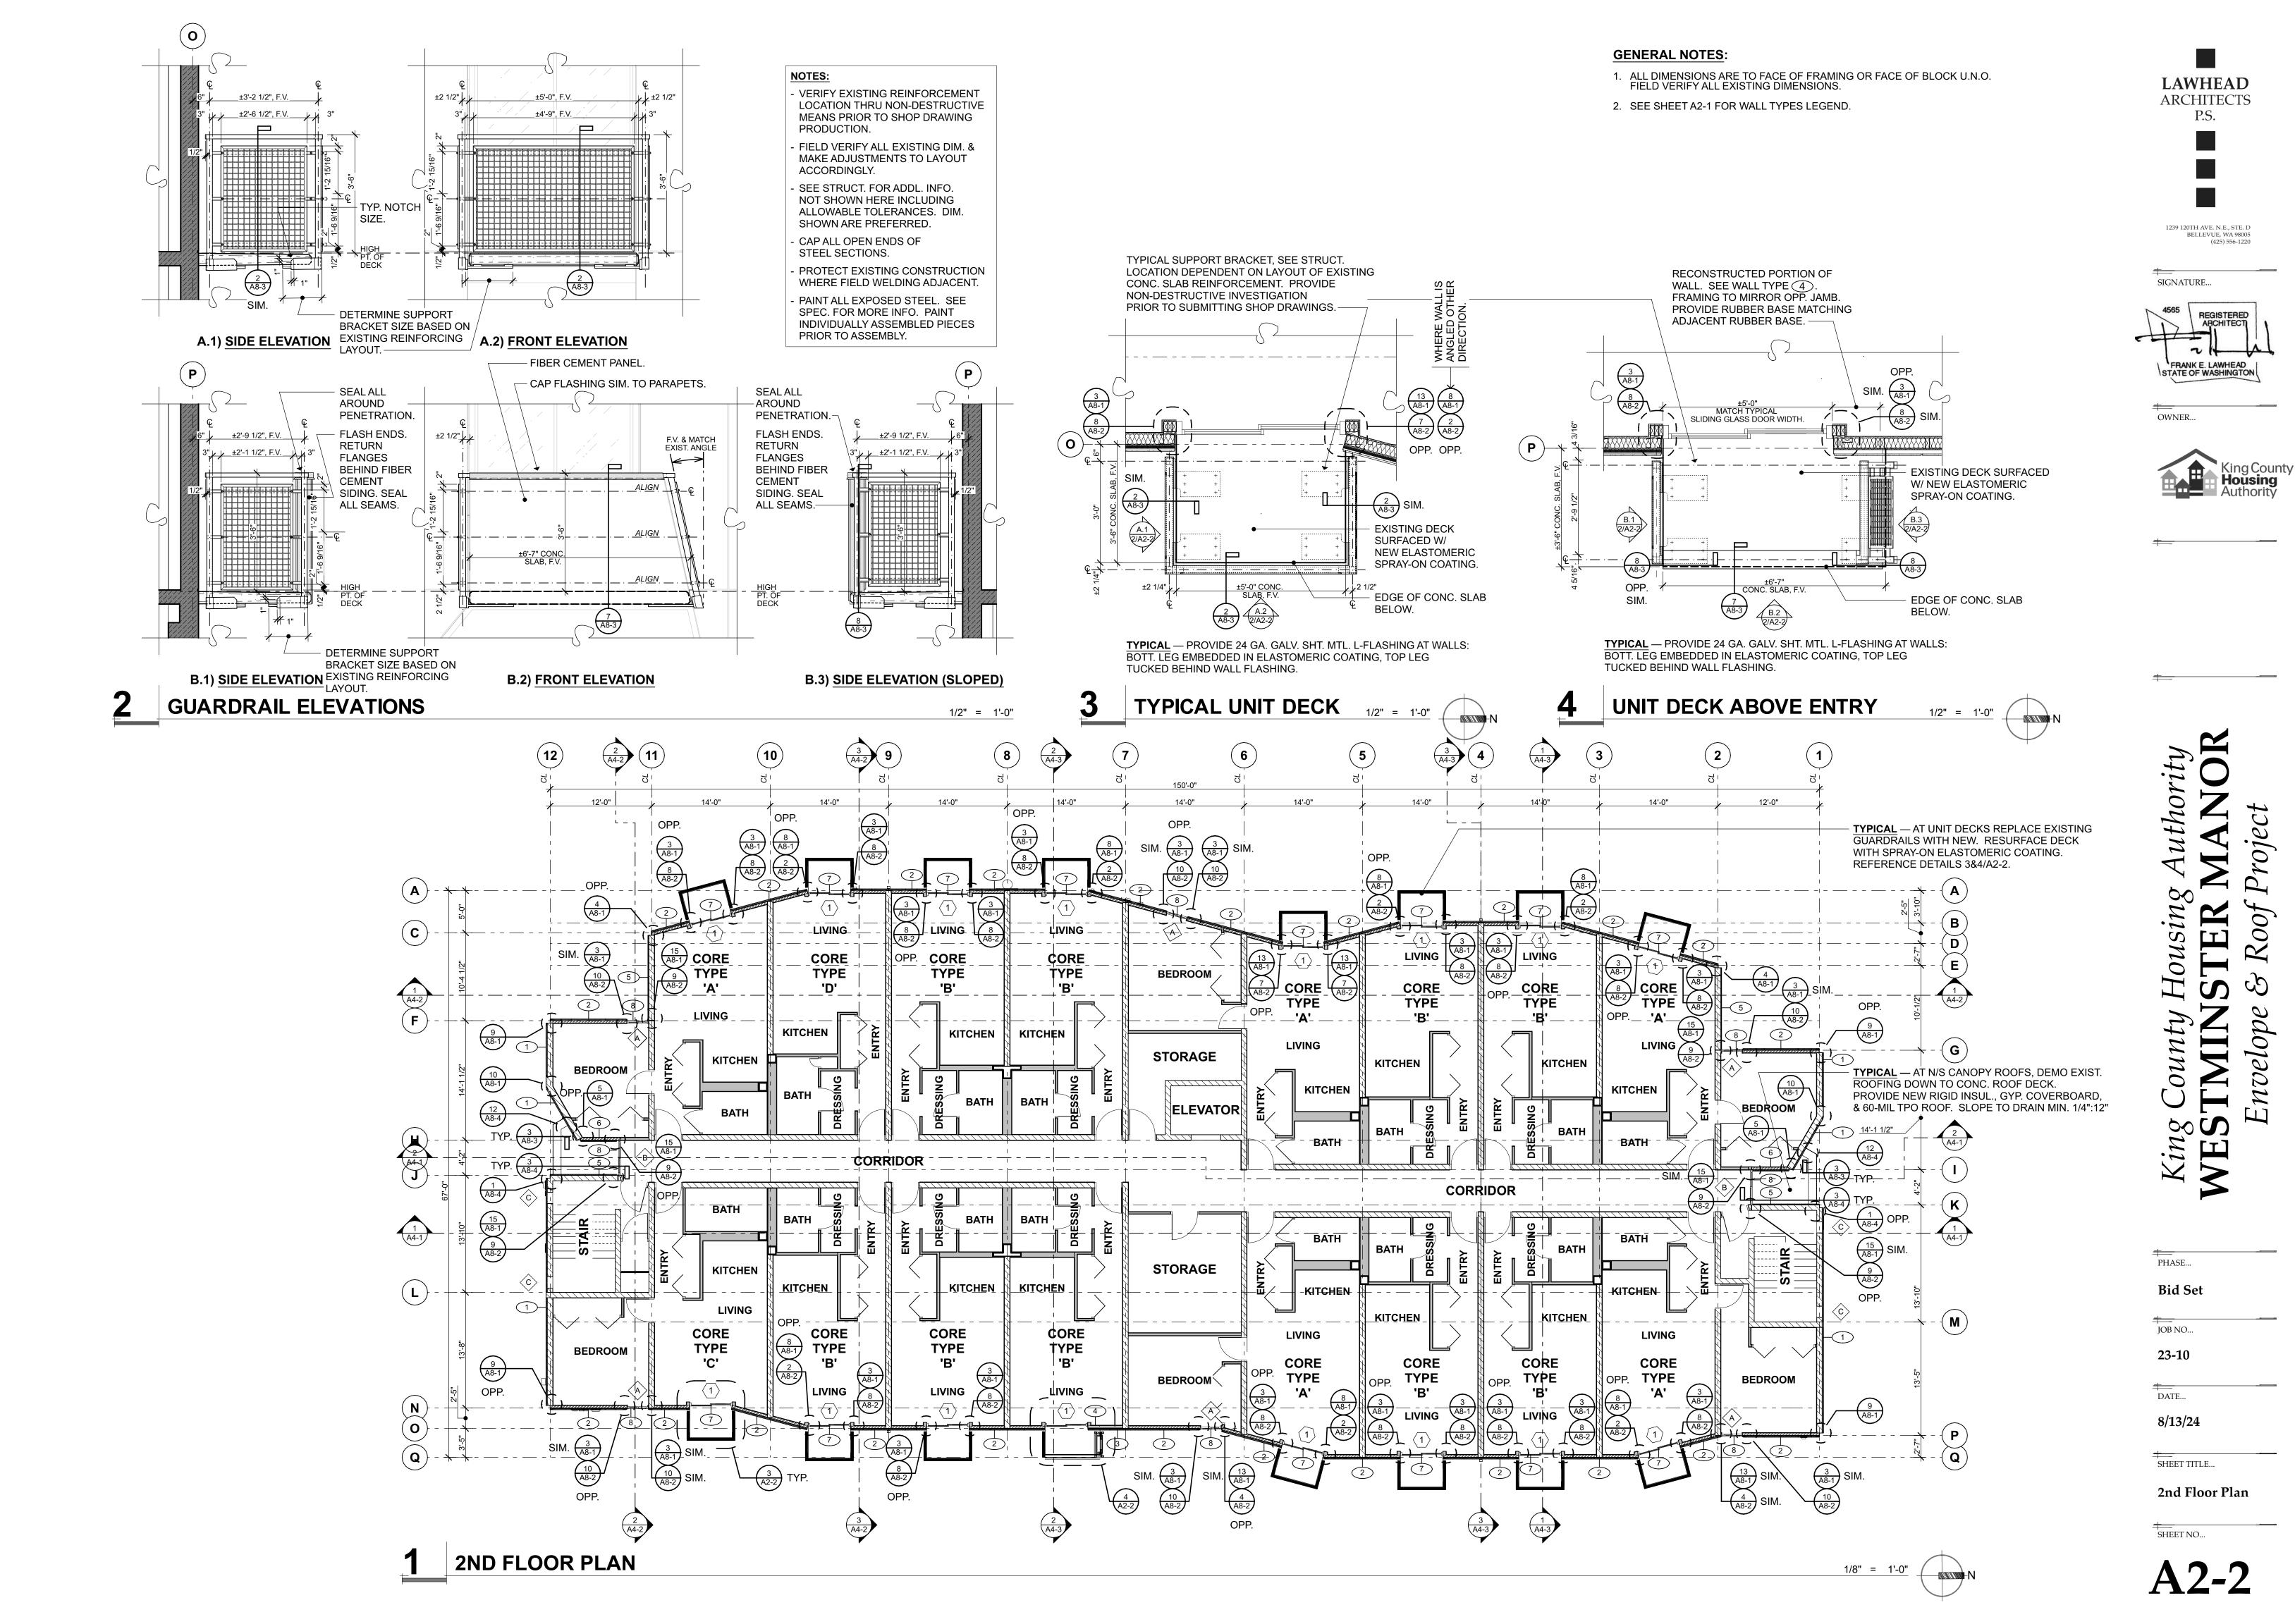


1239 120TH AVE. N.E., STE. D BELLEVUE, WA 98005 (425) 556-1220

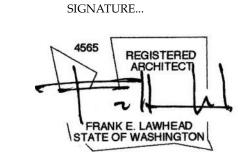

OWNER...



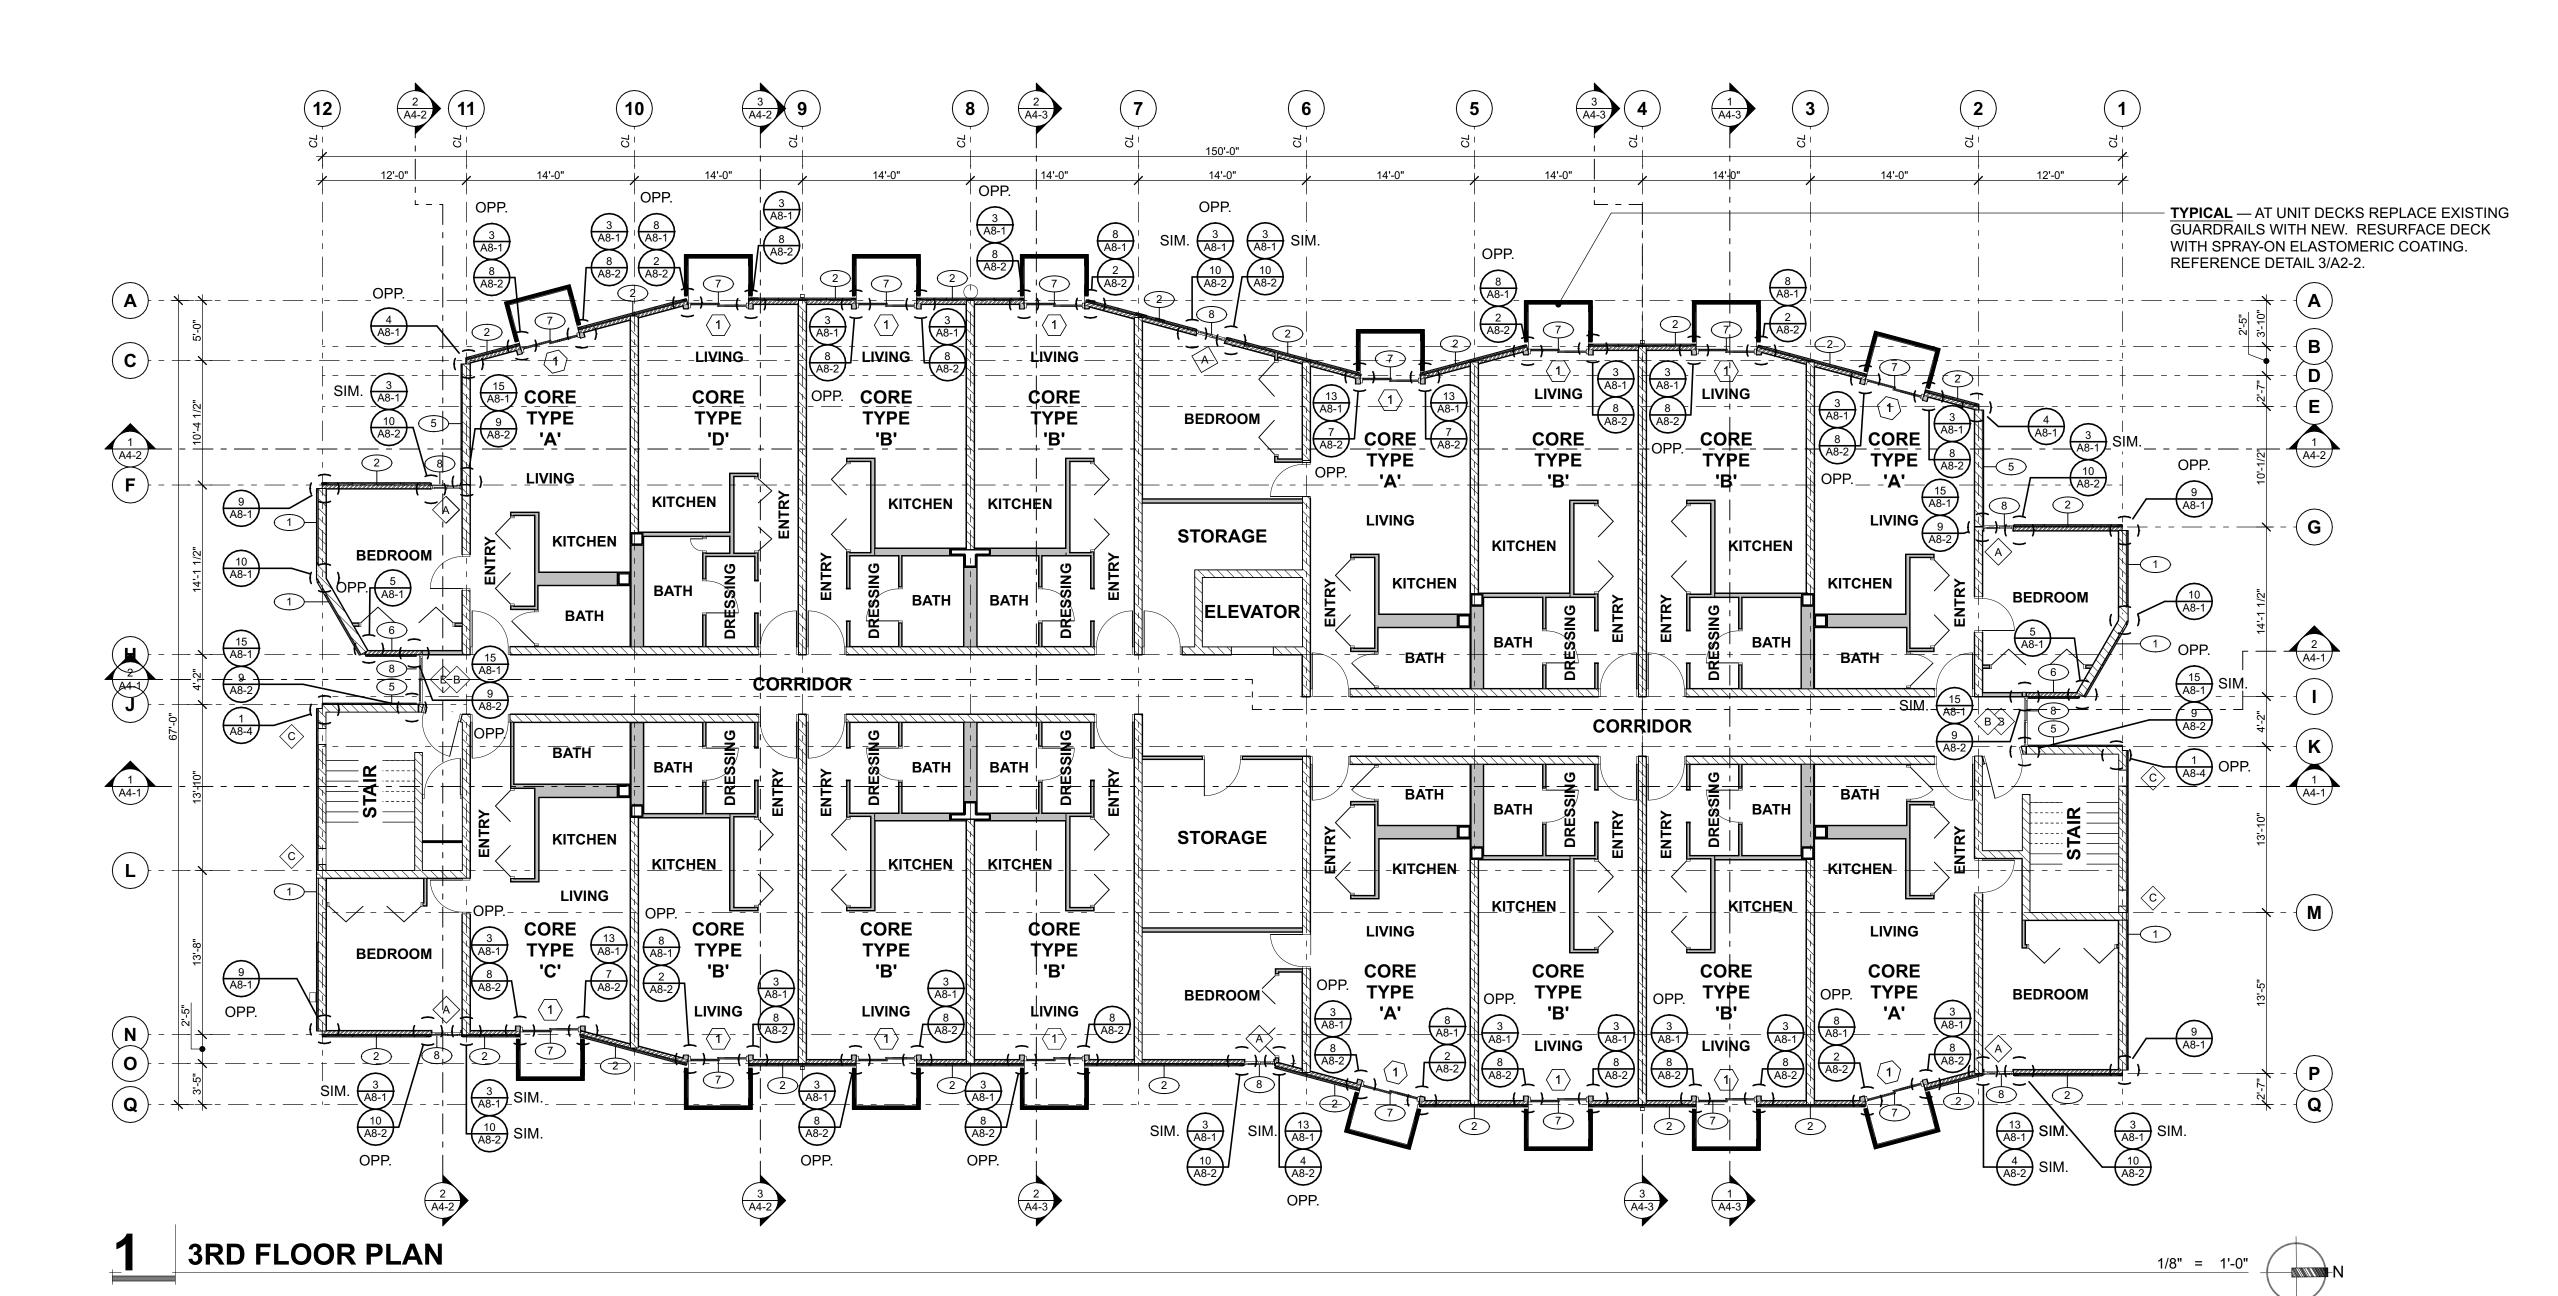

King County Housing Authority WESTMINSTER MANO

†— PHASE...

Bid Set

JOB NO...
23-10

DATE...
8/13/24


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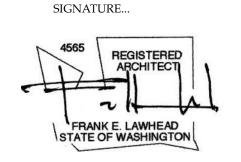
3rd Floor Plan

SHEET NO...

A2-3

- ALL DIMENSIONS ARE TO FACE OF FRAMING OR FACE OF BLOCK U.N.O. FIELD VERIFY ALL EXISTING DIMENSIONS.
- 2. SEE SHEET A2-1 FOR WALL TYPES LEGEND.



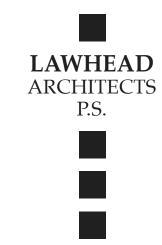


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(425) 556-1220

OWNER...



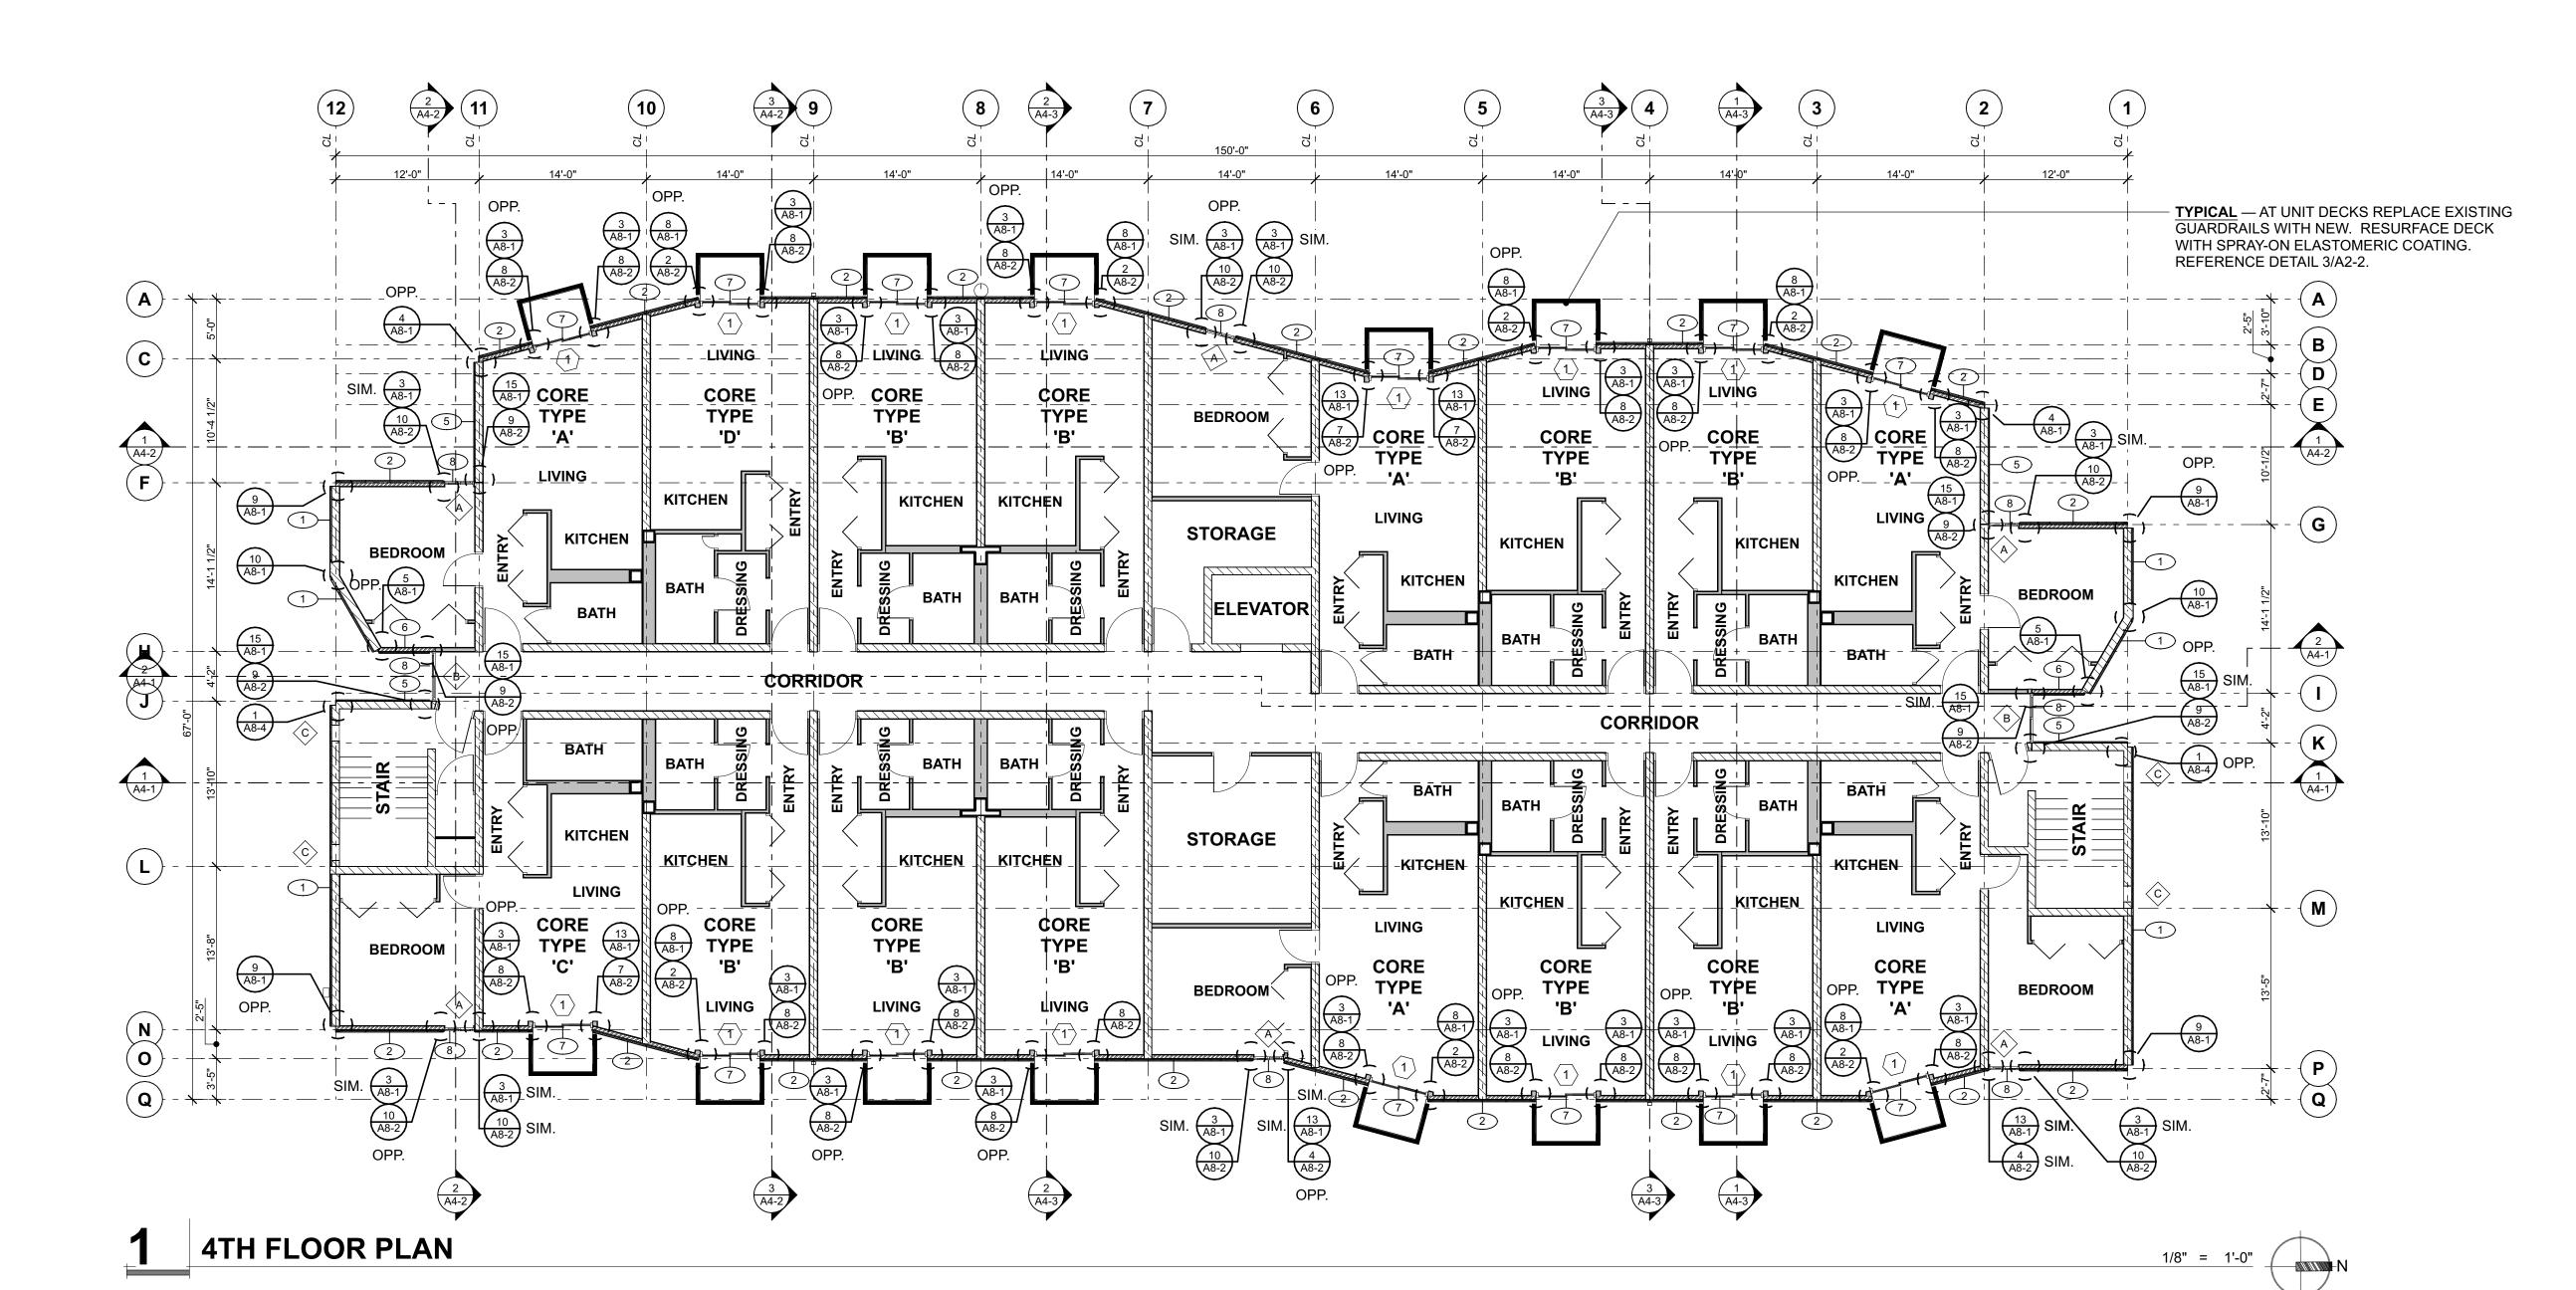

King County Housing Authority WESTMINSTER MANO

PHASE...

Bid Set

JOB NO...


8/13/24


SHEET TITLE...

4th Floor Plan

SHEET NO...

A2-4

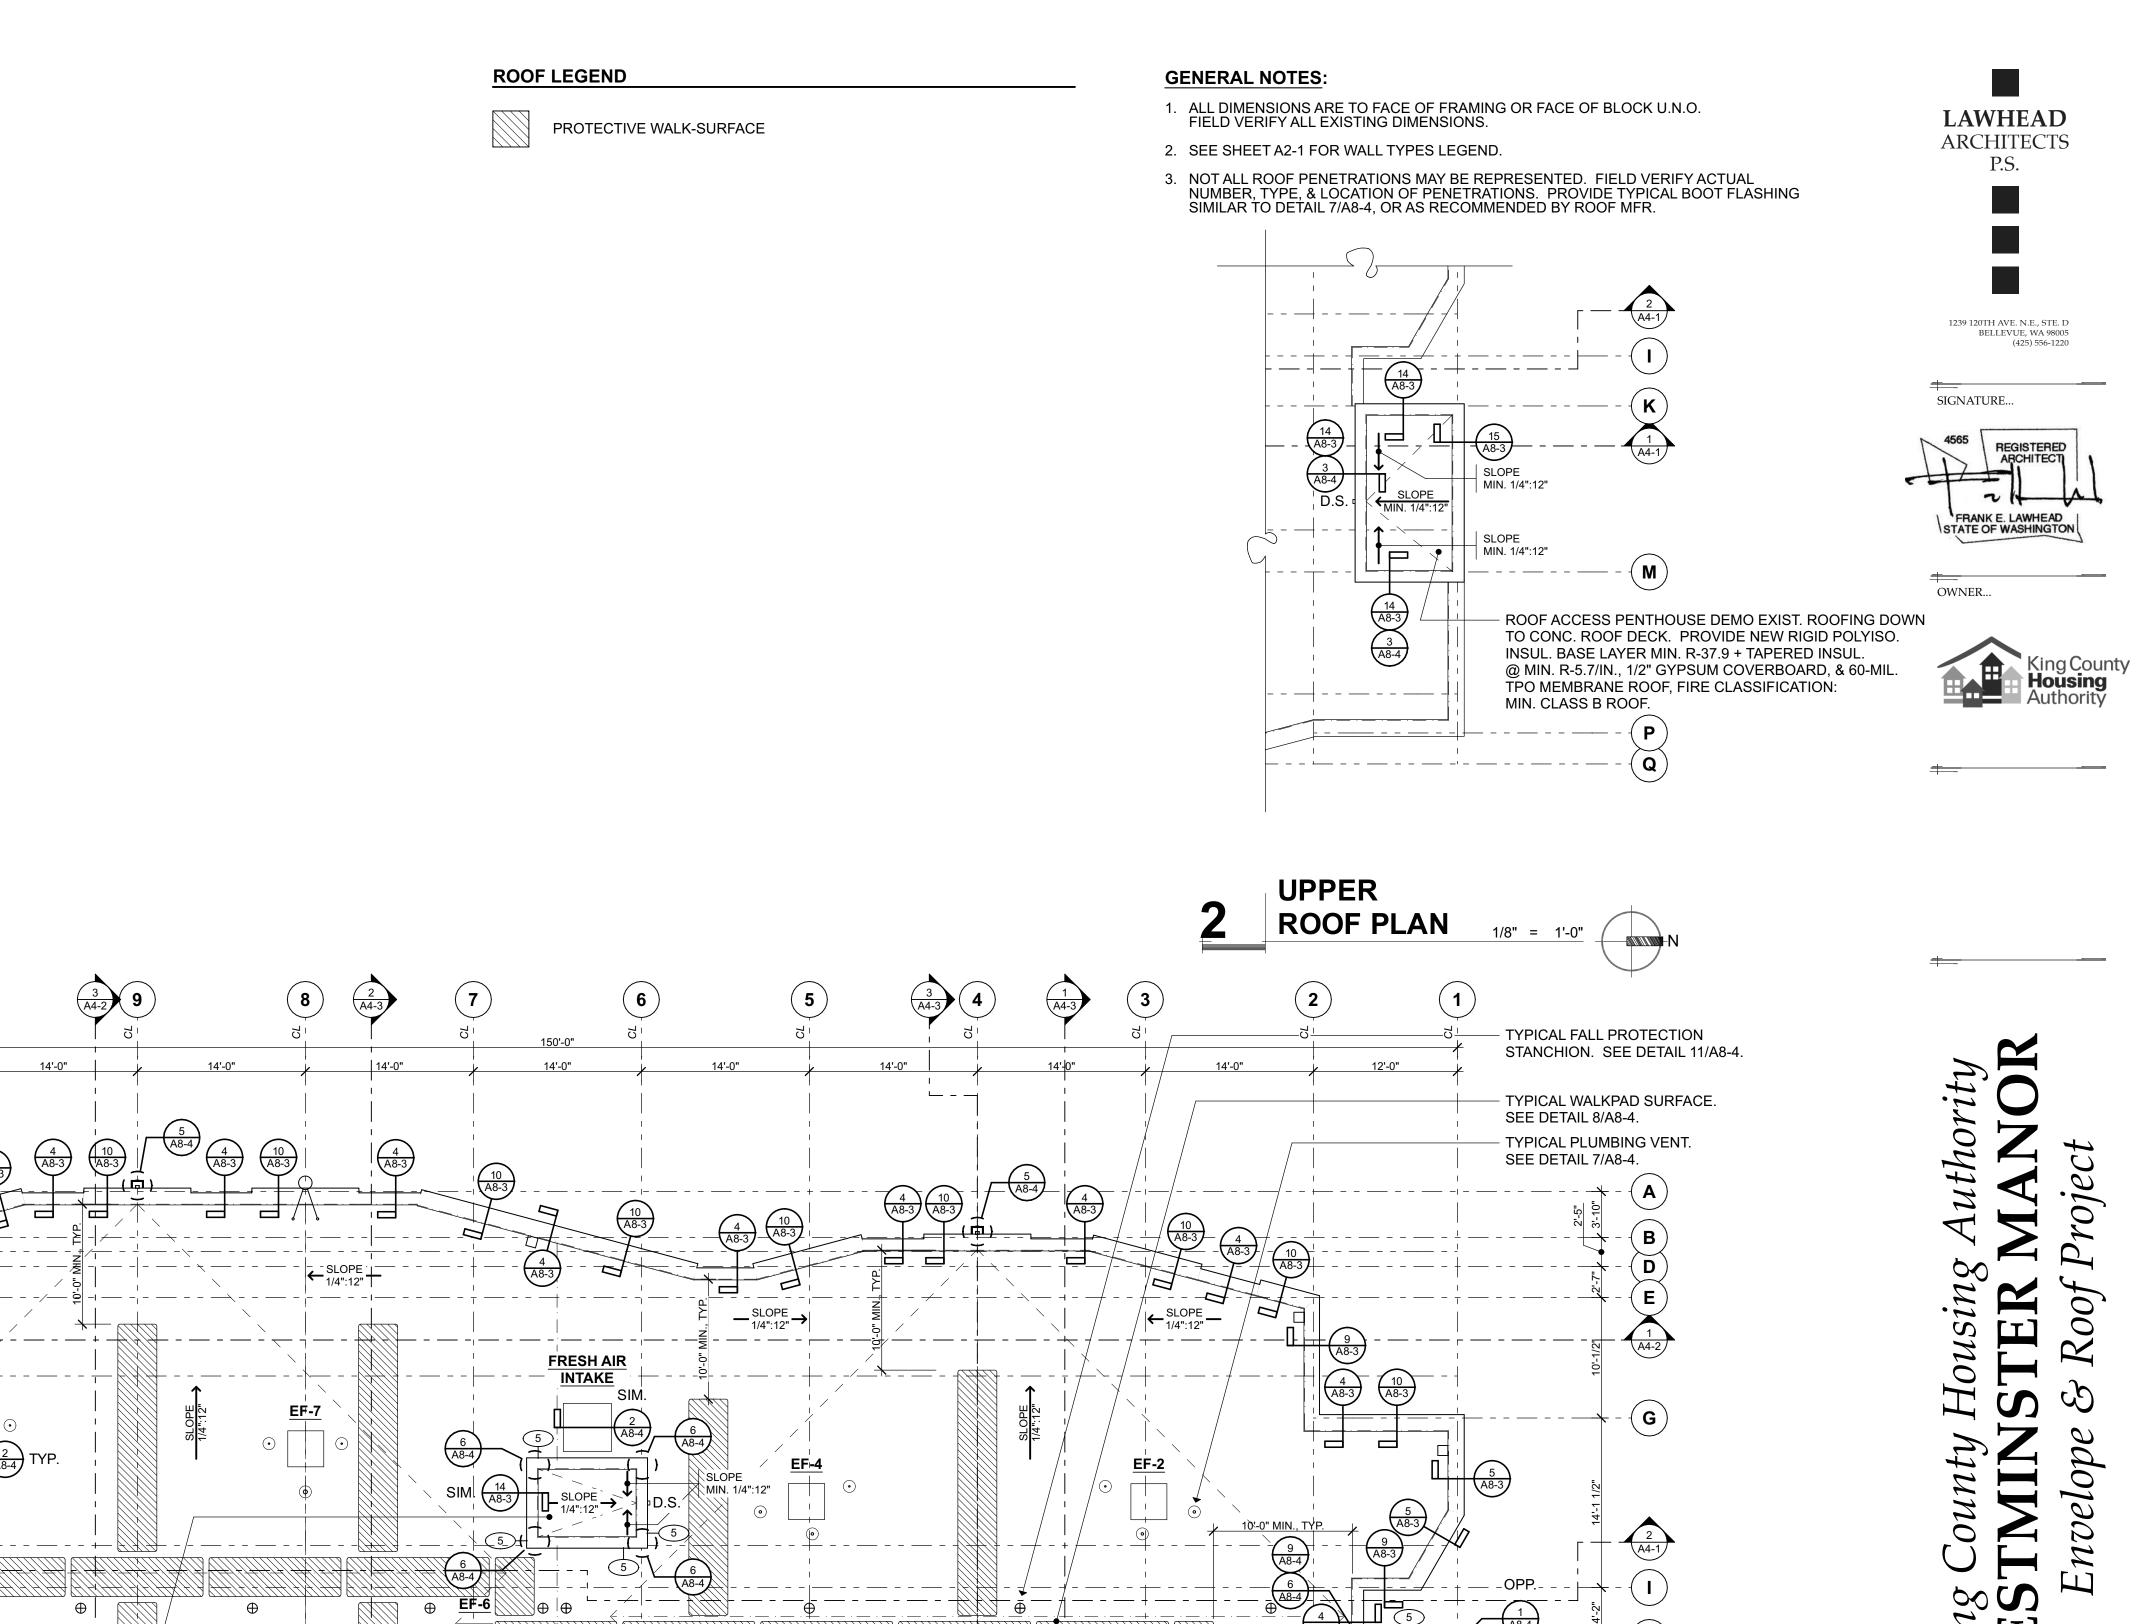

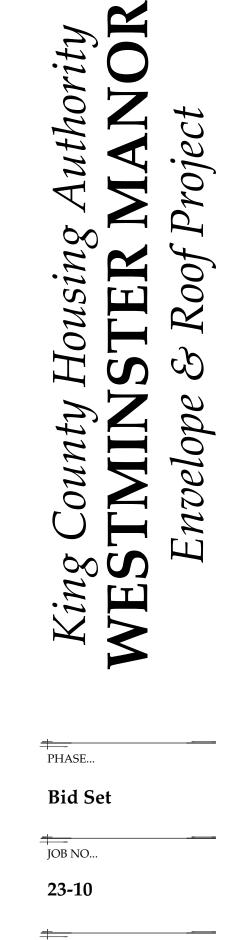

DATE... 8/13/24

PROVIDE CONC. SPLASH BLOCK ON

TYPICAL EXISTING LIGHT. SEE ELEC. & 5/A8-5.

MIN. CLASS B ROOF.

1/8" = 1'-0"

SACRIFICIAL STRIP OF ROOF MEMBRANE WHERE D.S. LANDS ON ROOF. TYP. (2) LOC.

TYPICAL (U.N.O.) — DEMO EXIST. ROOFING DOWN TO

BASE LAYER MIN. R-26 + TAPERED INSUL. @ MIN.

R-5.7/IN., 1/2" GYPSUM COVERBOARD, & 60-MIL. TPO MEMBRANE ROOF, FIRE CLASSIFICATION:

EXISTING FIRE SPRINKLER STAND PIPE

CONC. ROOF DECK. PROVIDE NEW RIGID POLYISO. INSUL.

SHEET TITLE...

Roof Plan

SHEET NO...

ELEVATOR PENTHOUSE ROOF SAME AS TYPICAL ROOF ASSEMBLY EXCEPT BASE LAYER MIN. R-37.9 —

 $\left(\begin{array}{c} \bullet \end{array} \right) - \begin{array}{c} \bullet \\ \bullet \end{array} - \begin{array}{c} \bullet \end{array} - \begin{array}{c} \bullet \\ \bullet \end{array} - \begin{array}{c} \bullet$

TYP. — PROVIDE CRICKET
AT PENETRATIONS NEAR []
VALLEYS PER DETAIL

15/A8-5.

 (\mathbf{o})

(10)

DOOR SCHEDULE

		DOOR		FRAME		DETAILS			
NO.	WIDTH x HT.	TYPE	MAT. / FIN.	MAT. / FIN.	HEAD	JAMB	THRESH.	HARDWARE ⁽¹⁾	REMARKS
1 ⁽³⁾	5'-0" x 6'-8"	1	GLAZING	VINYL	3/A8-2	2/A8-2; 8/A8-2; 7/A8-2	13/A8-2; 14/A8-2	-	SLIDING GLASS DOOR. F.V. DIM. & JAMB / THRESHOLD CONDITIONS FOR EACH DOOR.
2	3'-0" x ±5'-7"	2	H.M. / PT	H.M. / PT	1/A8-2	6/A8-2	11/A8-2	HW-1	ROOF ACCESS DOOR. F.V. DIM.
Х	_	_	ALUM; GLASS	ALUM	_	_	_	HW-2	EXIST. DOOR W/ REPLACED OPERATOR

NOTES:

- (1) ALL DOOR HARDWARE MUST MEET THE ICC / ANSI A117.1-2009 STANDARD.
- (2) SLIDING GLASS DOORS SHALL BE NFRC CERTIFIED AND LABELED. REQUIRED SYSTEM PERFORMANCE: MAXIMUM HEAT LOSS U-VALUE = 0.29, MAXIMUM SHGC = 0.29, MINIMUM VT = 0.54;
- HOLLOW METAL DOORS & FRAMES MAXIMUM OVERALL SYSTEM HEAT LOSS U-VALUE = 0.37;
- (3) REFER TO SPECIFICATION 12 21 16 FOR VERTICAL LOUVER BLINDS TO BE INSTALLED AT THESE DOORS.

WINDOW / LOUVER SCHEDULE

_								
	NO.	WIDTH x HT.	OPERATION	MAT. / FIN.	HEAD	DETAILS JAMB	SILL	REMARKS
	A ⁽³⁾	2'-6" x 4'-2"	SLIDING	VINYL	5/A8-2	4/A8-2; 9/A8-2; 10/A8-2	15/A8-2	F.V. DIM. & JAMB CONDITIONS FOR EACH WINDOW.
	В	4'-2" x 4'-2"	SLIDING	VINYL	5/A8-2	9/A8-2;	15/A8-2	F.V. DIM. & JAMB CONDITIONS FOR EACH WINDOW.
	С	1'-4" x 8"	FIXED	ALUM / PT	1/A8-3	6/A8-3	11/A8-3	F.V. DIM. SEE SPEC. 08 91 00 FOR MORE INFO.


NOTES:


- (1) WINDOWS SHALL BE NFRC CERTIFIED AND LABELED. REQUIRED SYSTEM PERFORMANCE:
- MAXIMUM HEAT LOSS U-VALUE = 0.29, MAXIMUM SHGC = 0.28, MINIMUM VT = 0.53.
- (2) ALL REPLACEMENT WINDOWS ABOVE THE FIRST FLOOR SHALL BE PROVIDED WITH WINDOW FALL PREVENTION DEVICES THAT COMPLY WITH ASTM F2090. (3) REFER TO SPECIFICATION 12 21 13 FOR HORIZONTAL LOUVER BLINDS TO BE INSTALLED AT THESE WINDOWS.

LEGEND:


ACT ALUM CT CONC CPT EXP FF FRP	ACOUSTIC CEILING TILE ALUMINUM CERAMIC TILE CONCRETE CARPET EXPOSED FACTORY FINISHED FIBER REINFORCED PLASTIC	GWB GWBX HM MTL PEMB PLWD P-LAM PT	GYPSUM WALL BOARD FIRE RATED GYPSUM WALL BOARD HOLLOW METAL METAL PRE-ENGINEERED METAL BUILDING PLYWOOD PLASTIC LAMINATE PAINT	SL STN SV VB VCT WD WGWB	SEAL STAIN SHEET VINYL VAPOR BARRIER VINYL COMPOSITE TILE WOOD WATER RESISTANT GYPSUM WALL BOARD
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NOTE: VERIFY AND MATCH EXISTING ORIENTATION FOR ALL DOORS & WINDOWS



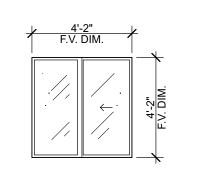
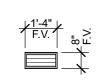
<u>C</u>

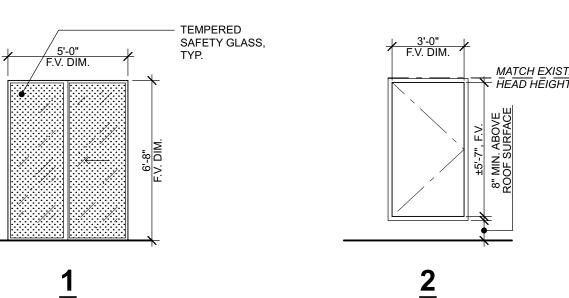

DOOR / WINDOW TYPES

1/4" = 1'-0"

— TEMPERED SAFETY GLASS

23-10

PHASE...

Bid Set

JOB NO...

DATE...

8/13/24

SHEET TITLE...

Schedules


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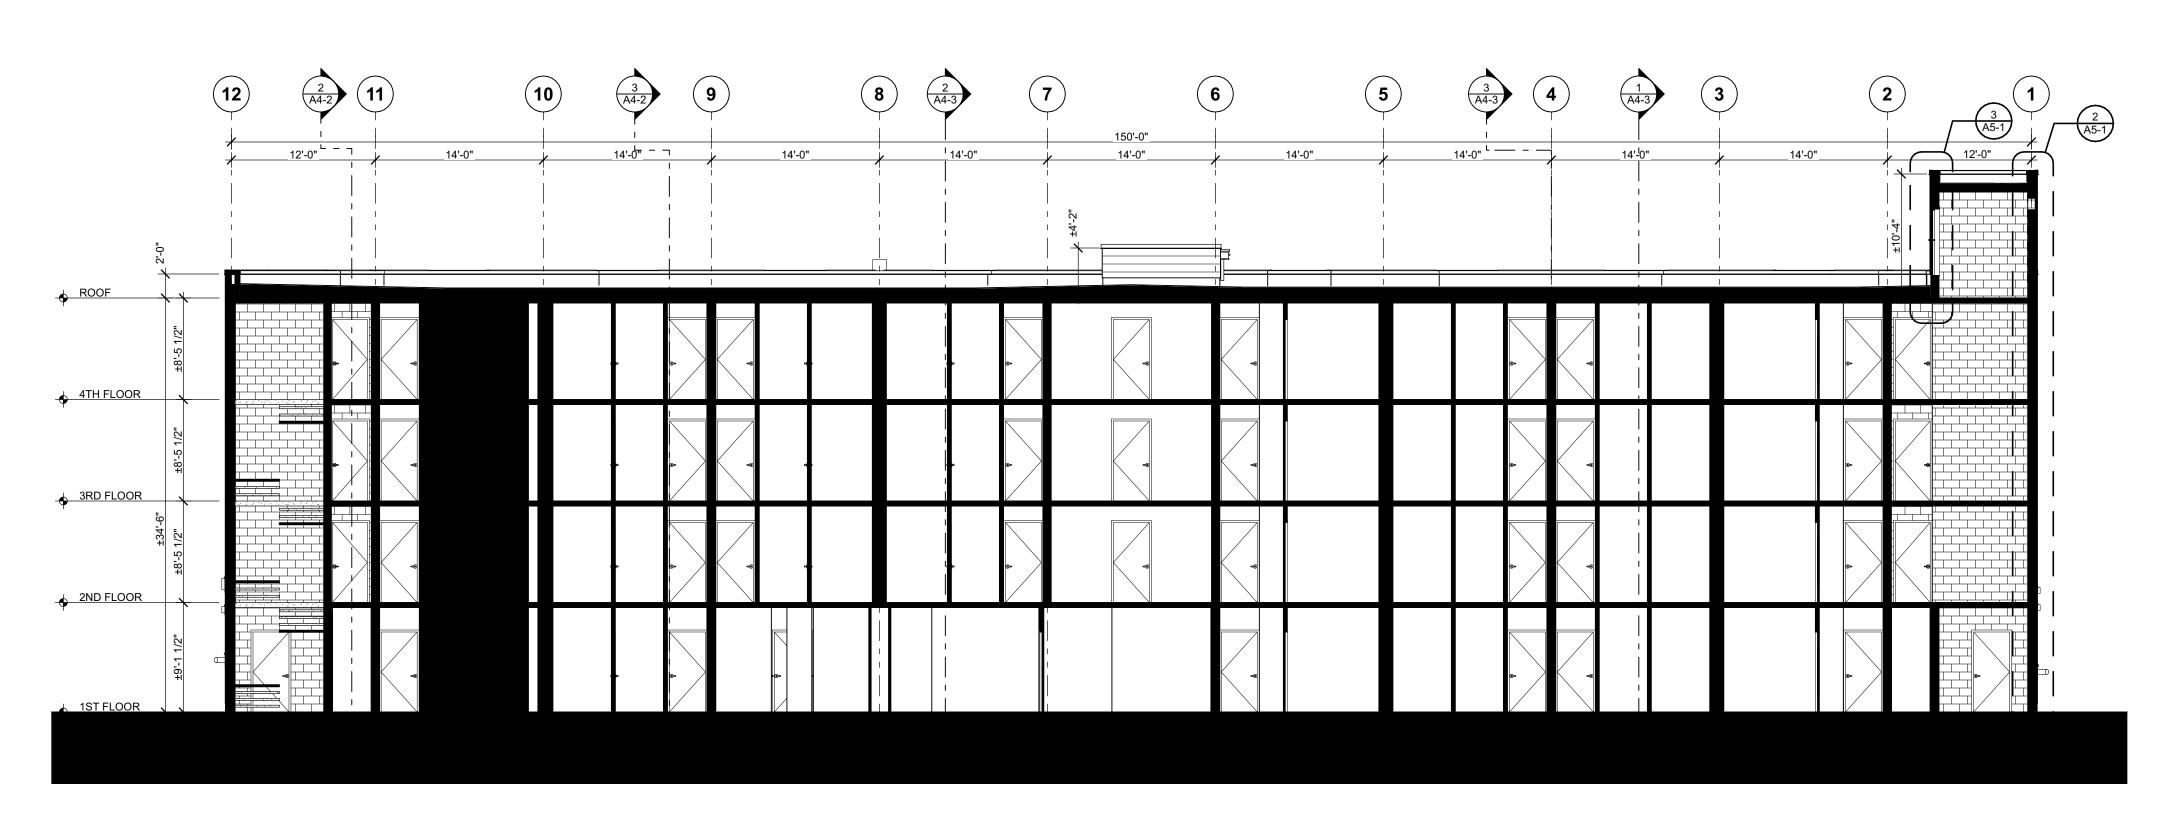
LAWHEAD **ARCHITECTS**


1239 120TH AVE. N.E., STE. D BELLEVUE, WA 98005

SIGNATURE...

(425) 556-1220



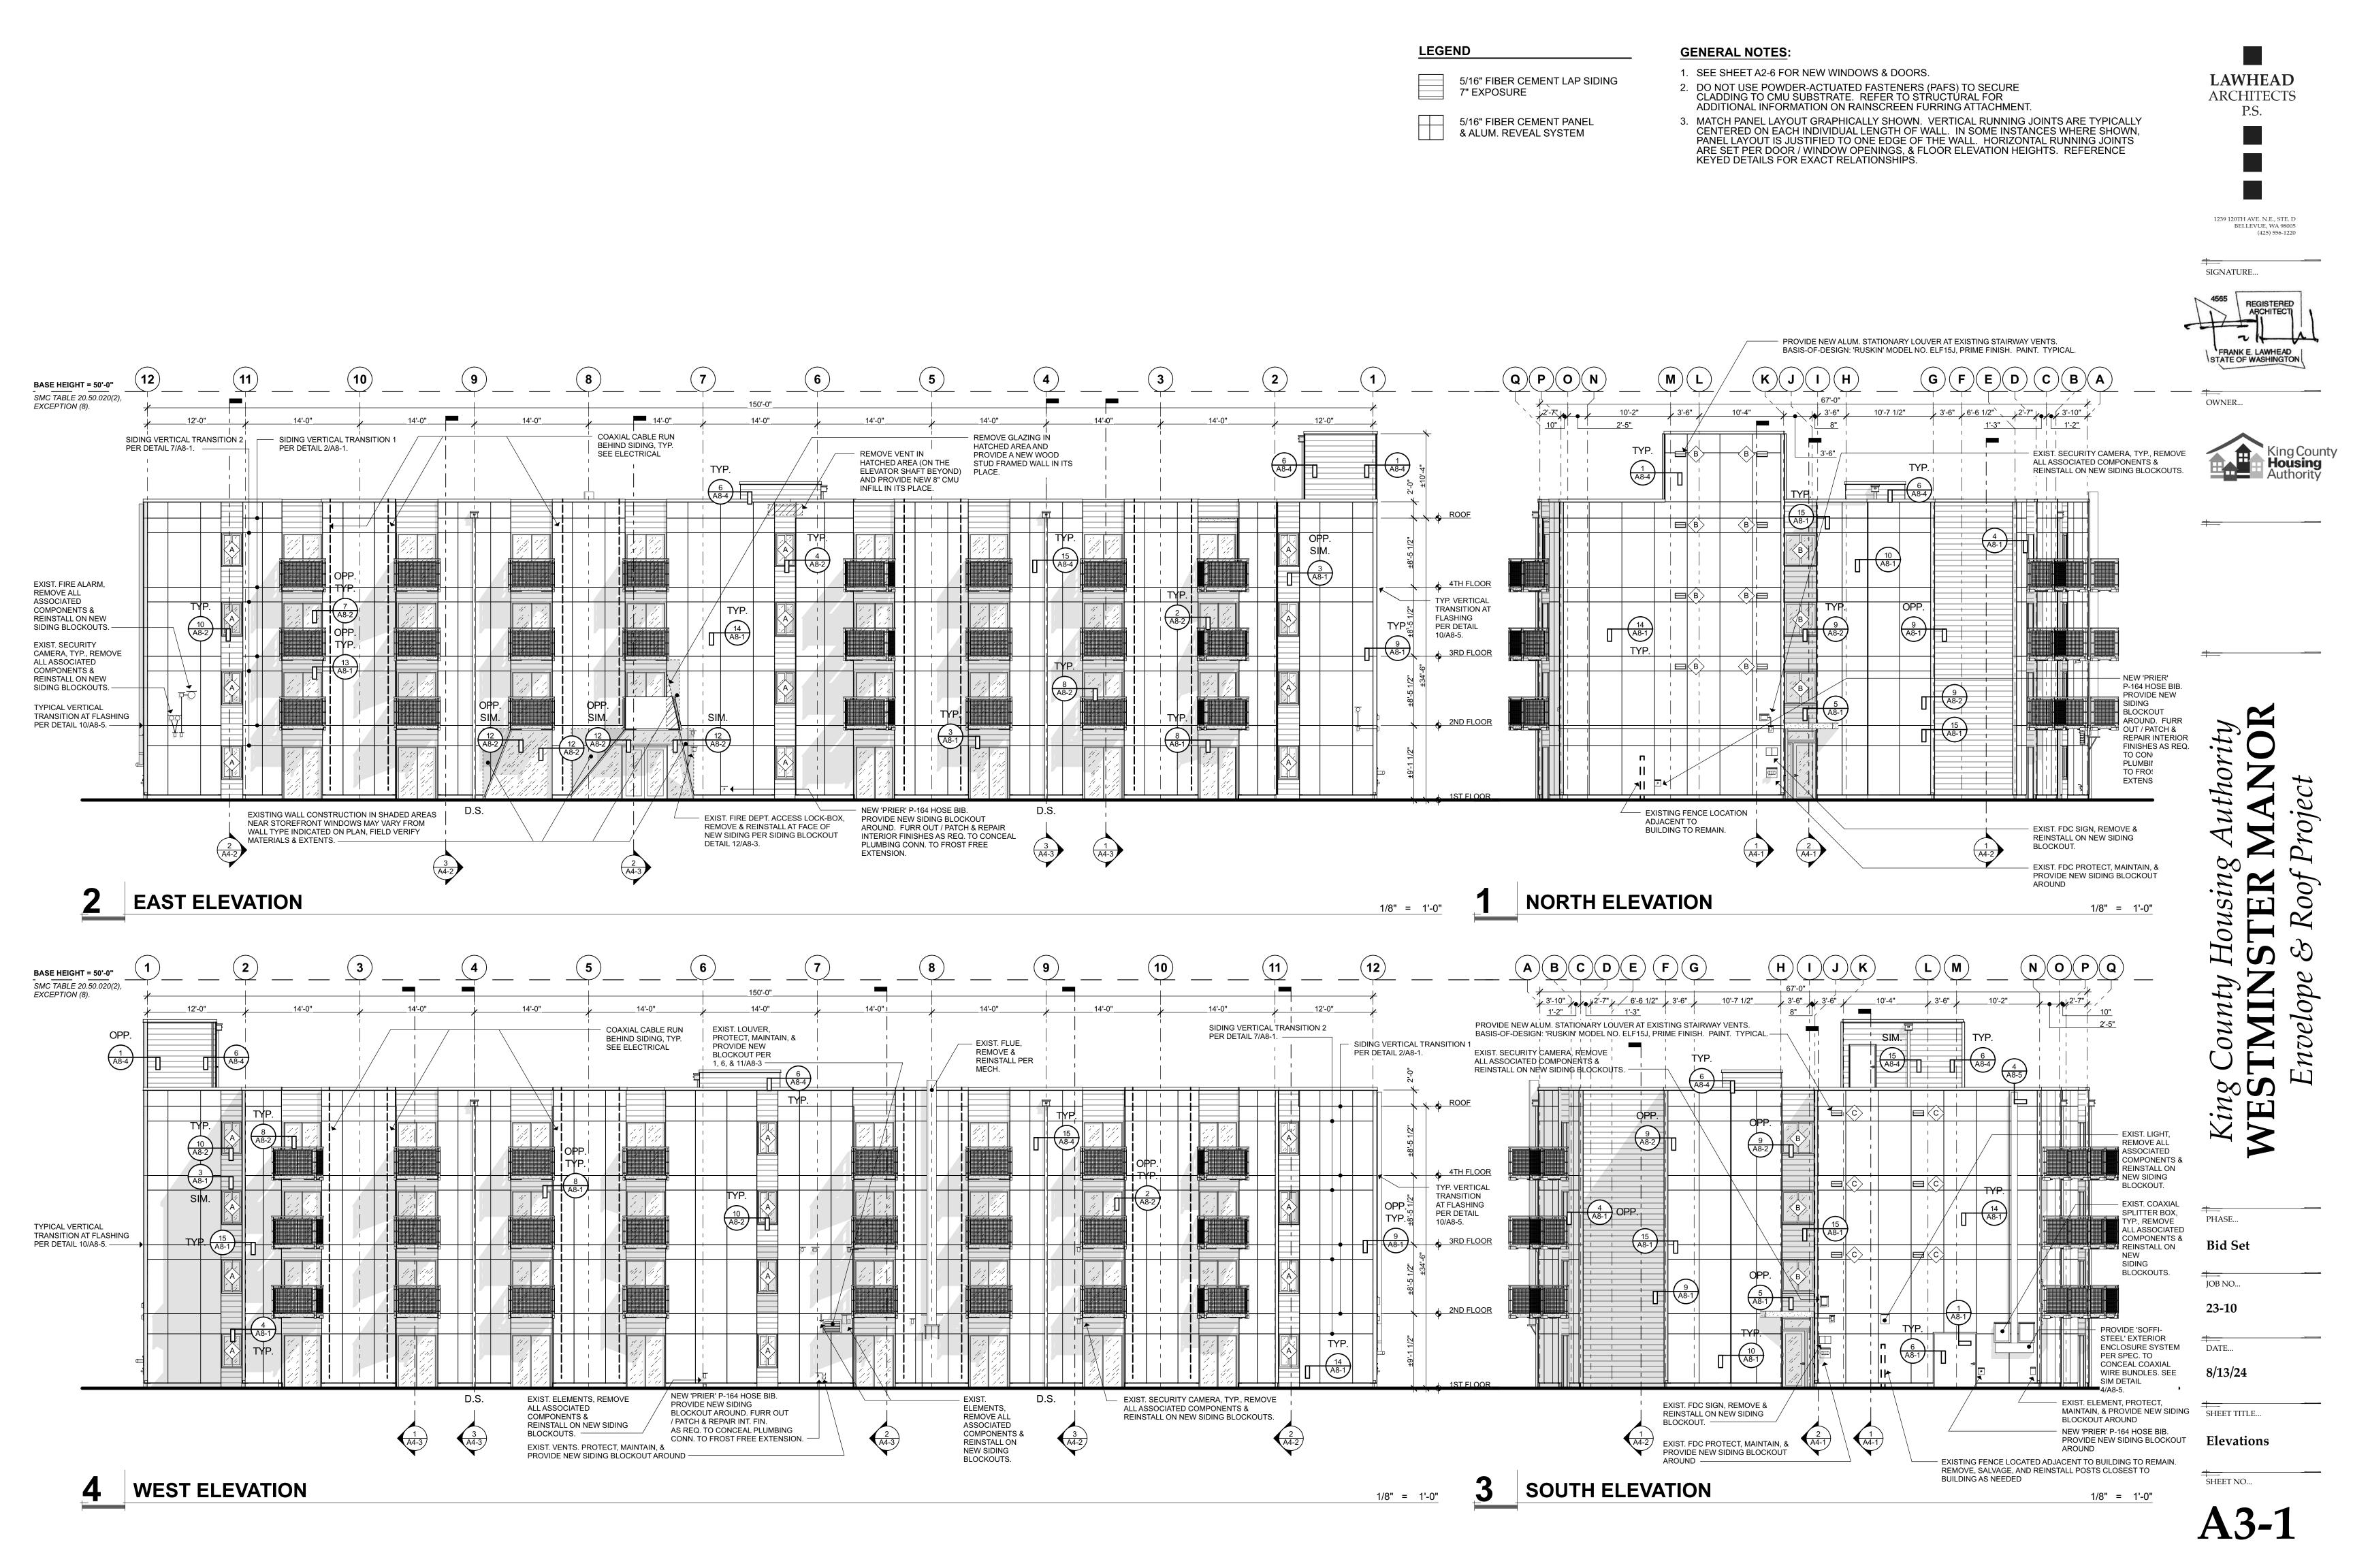

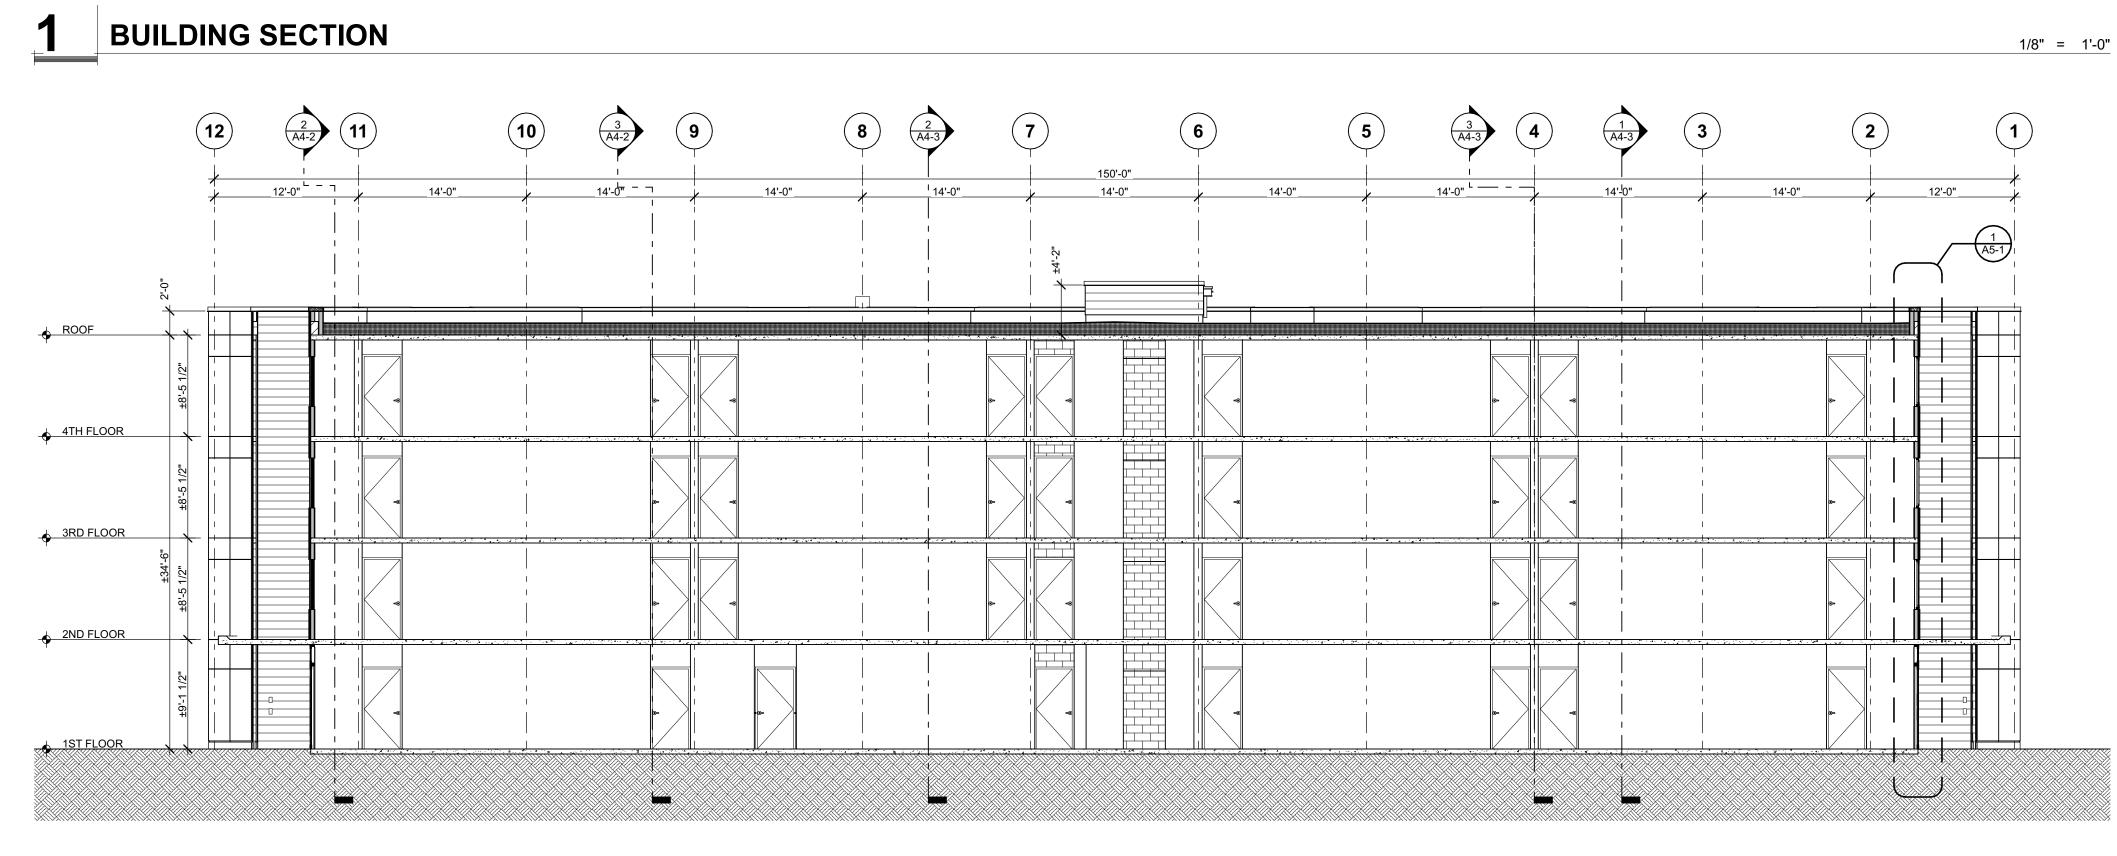

2 BUILDING SECTION

King County Housing Authority
WESTMINSTER MANOR
Envelope & Roof Project

LAWHEADARCHITECTS

1239 120TH AVE. N.E., STE. D BELLEVUE, WA 98005 (425) 556-1220

SIGNATURE...

OWNER...

PHASE...

Bid Set

JOB NO...

23-10

DATE...
8/13/24

SHEET TITLE...

Building Sections


SHEET NO...

1/8" = 1'-0"


A4-1

2 BUILDING SECTION



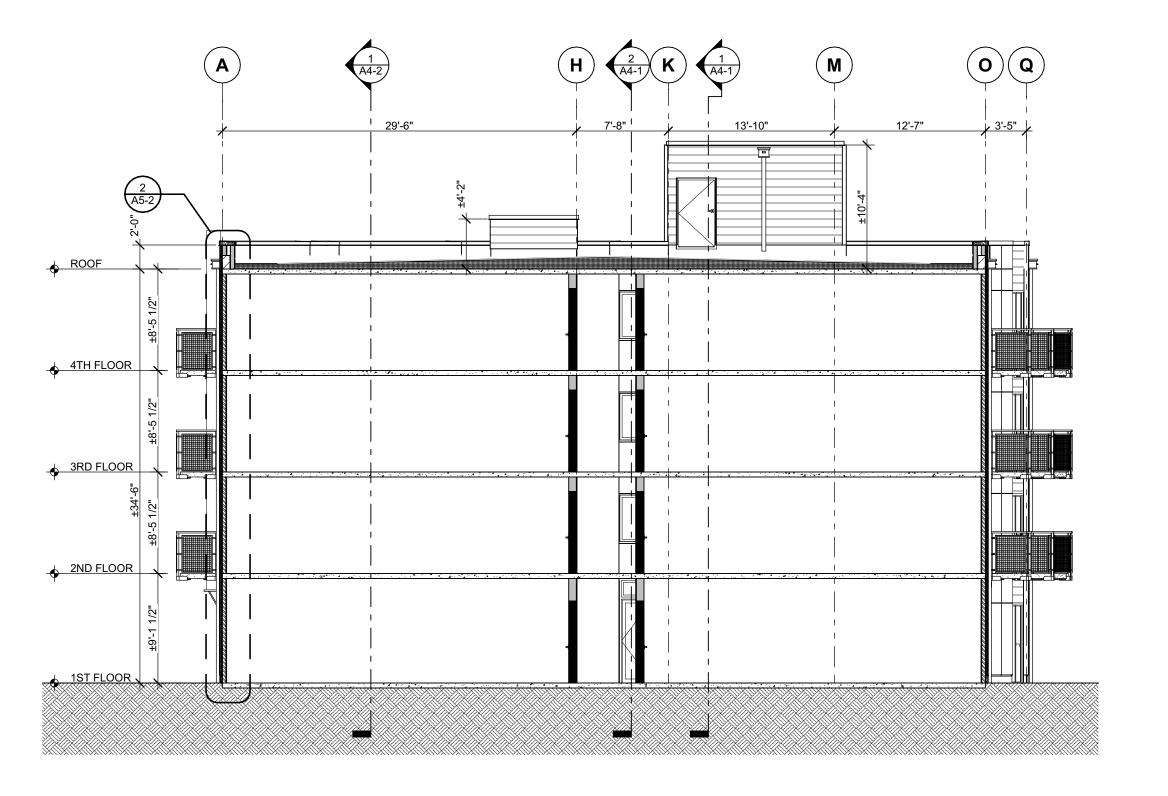

3 BUILDING SECTION 1/8" = 1'-0"

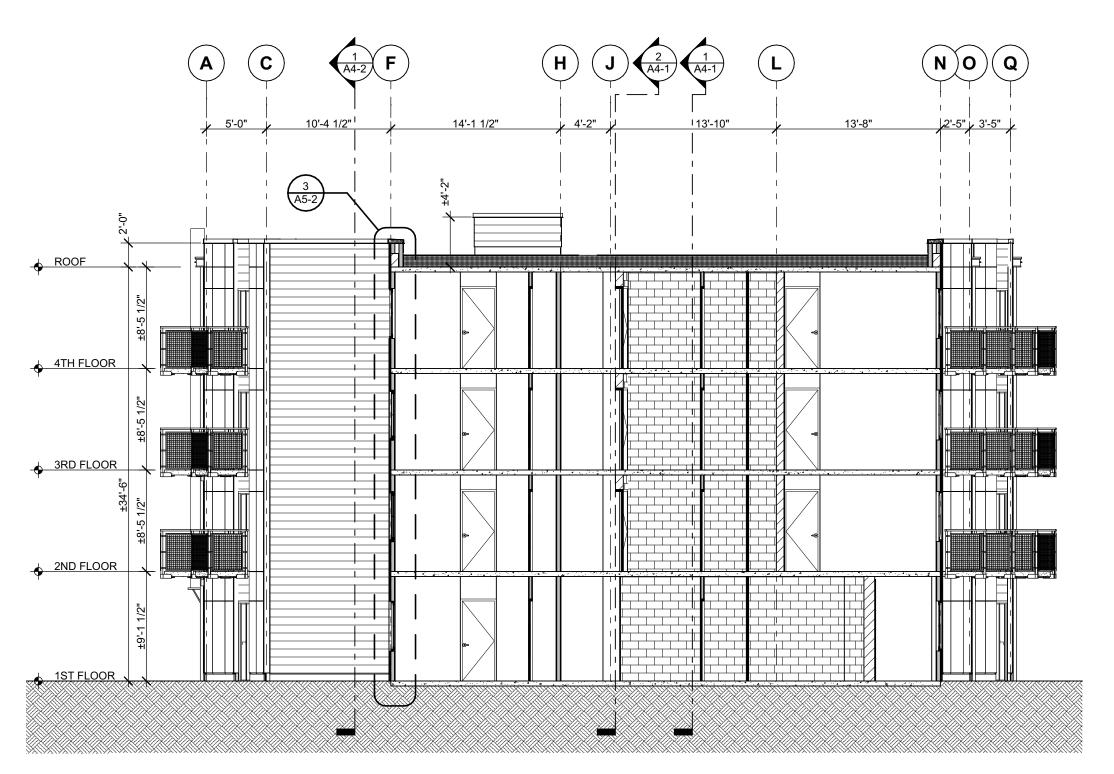

1/8" = 1'-0"

1/8" = 1'-0"

LAWHEAD ARCHITECTS

1239 120TH AVE. N.E., STE. D BELLEVUE, WA 98005 (425) 556-1220

SIGNATURE...

OWNER...

PHASE... **Bid Set**


JOB NO... 23-10

DATE... 8/13/24

SHEET TITLE...


Building Sections

SHEET NO...

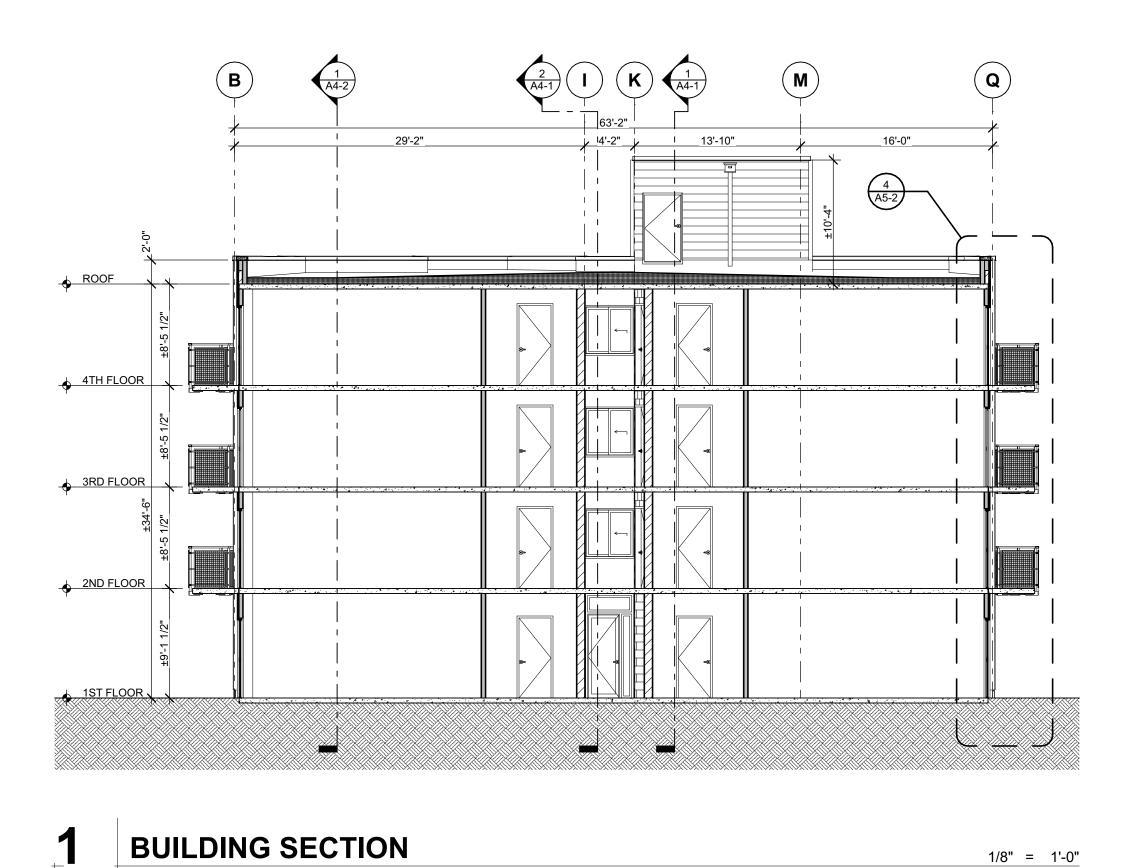

1/8" = 1'-0"

ROOF 4TH FLOOR 2ND FLOOR

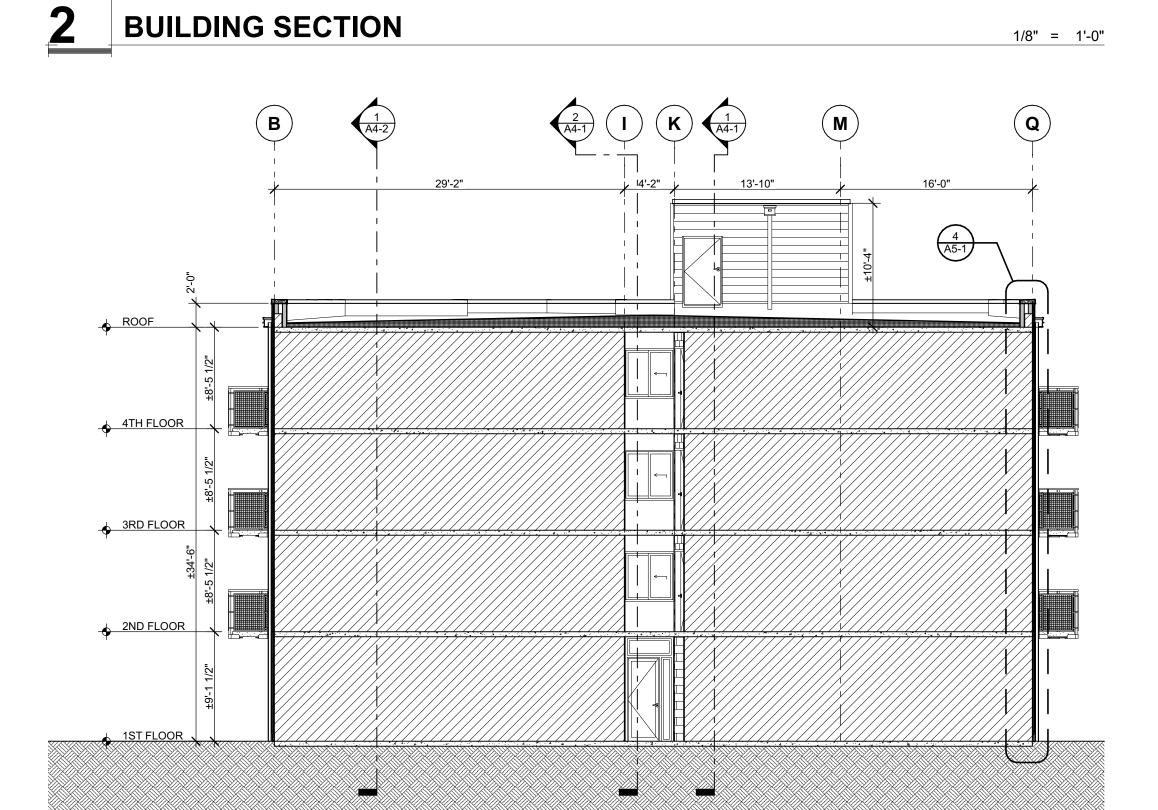

3 BUILDING SECTION 1/8" = 1'-0" Envelope

 →

 PHASE...

Bid Set

JOB NO...

23-10

DATE...

8/13/24

SHEET TITLE...

SHEET NO...

LAWHEAD ARCHITECTS

1239 120TH AVE. N.E., STE. D BELLEVUE, WA 98005 (425) 556-1220


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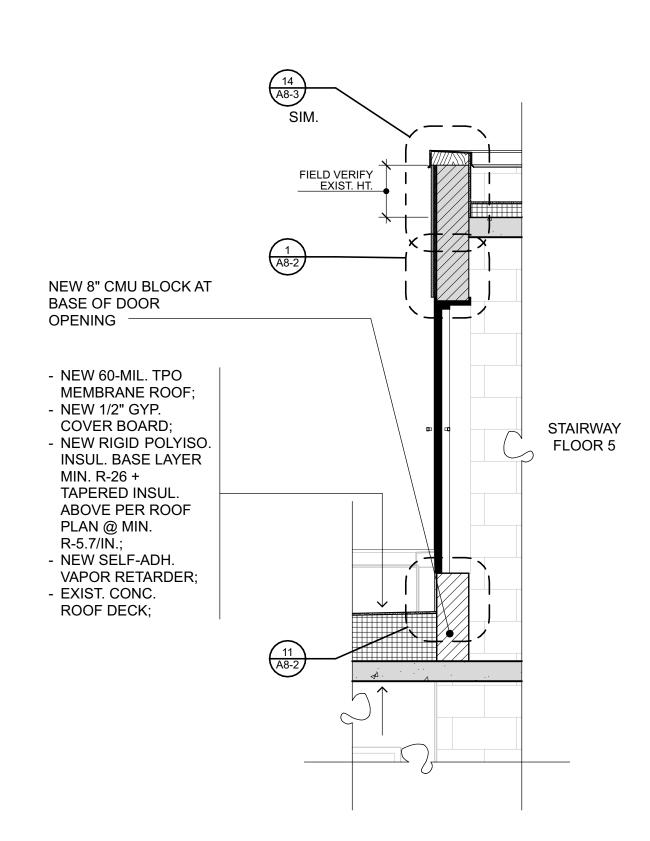
OWNER...

Building Sections





- 1. FIELD VERIFY ALL EXISTING MATERIALS, FINISHES, & DIMENSIONS. REPORT ANY DISCREPANCIES TO OWNER'S REPRESENTATIVE. WHERE PATCHING & REPAIRING MATERIALS WITHIN EXISTING ASSEMBLIES TO REMAIN, PROVIDE EQUIVALENT MATERIALS TO ORIGINAL
- 2. DO NOT USE POWDER-ACTUATED FASTENERS (PAFS) TO SECURE CLADDING TO CMU SUBSTRATE. REFER TO STRUCTURAL FOR ADDL. INFO. ON RAINSCREEN FURRING ATTACHMENT.
- 3. AT ALL WALLS WHERE WALL TYPE CHANGES WITHIN A CONTIGUOUS PLANE, ADD ADDITIONAL LAYERS OF SHEATHING TO CREATE FLUSH SURFACE FOR CLADDING;
- SHADED FILL INDICATES **EXISTING CONSTRUCTION** TO REMAIN.



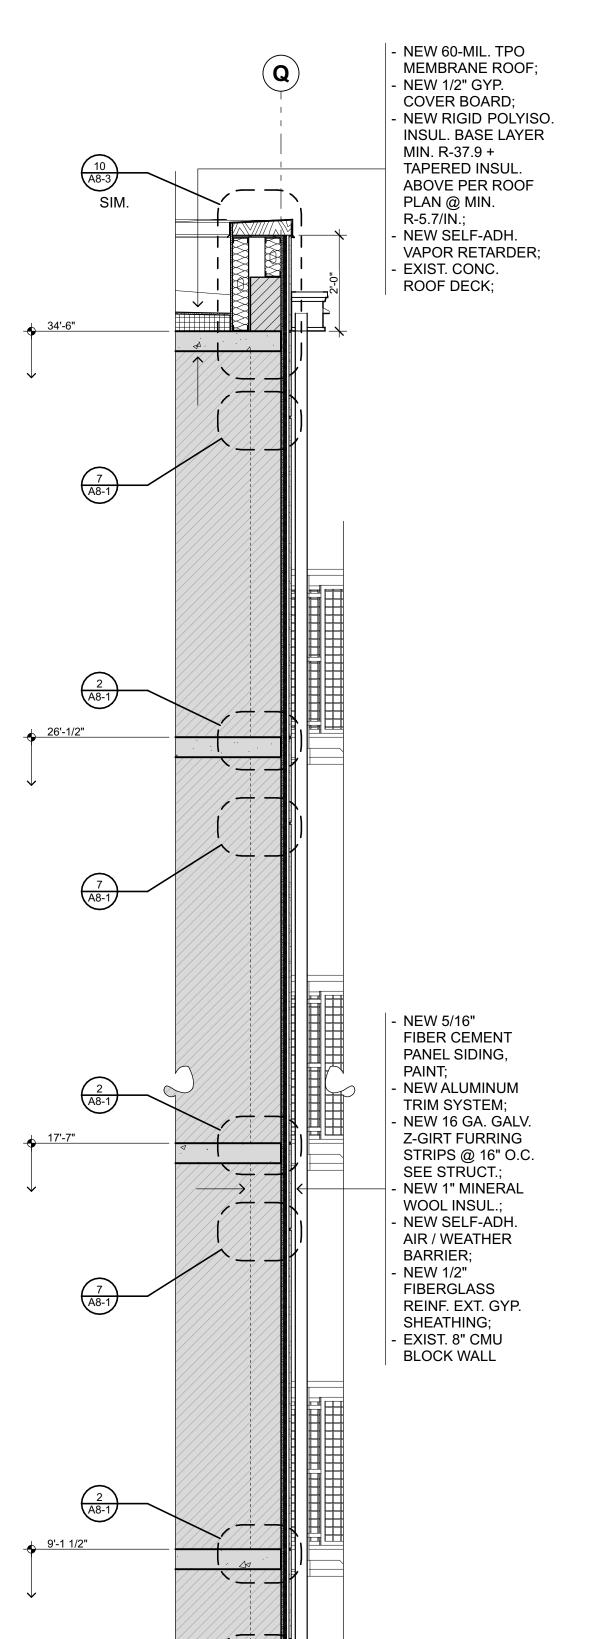


WALL SECTION 1/2" = 1'-0"

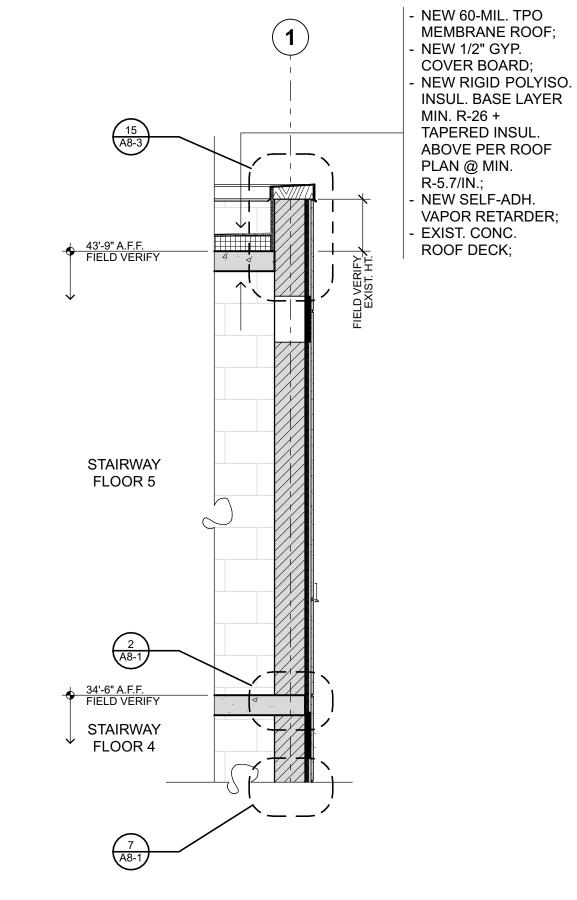

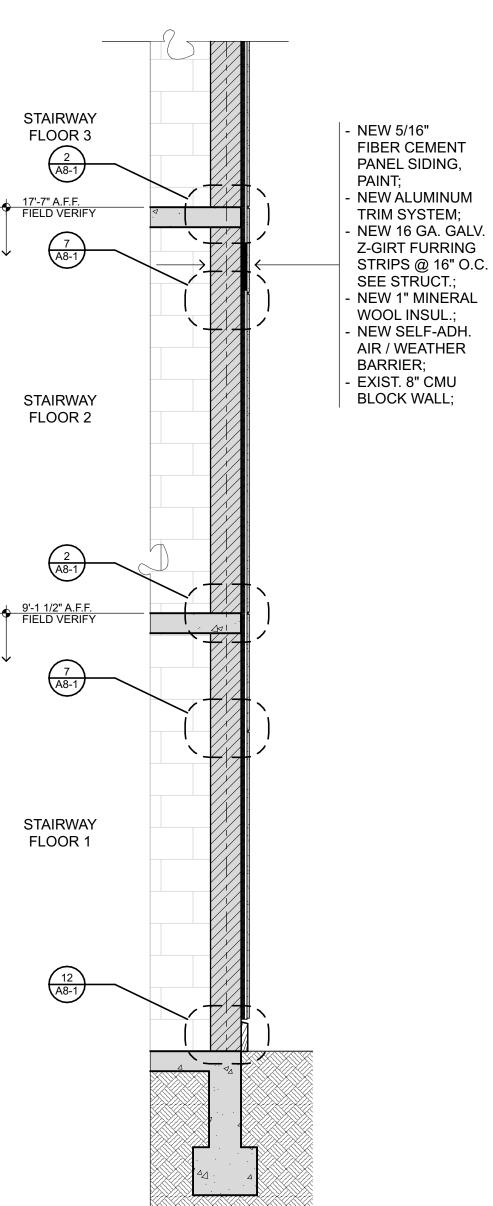



2 WALL SECTION

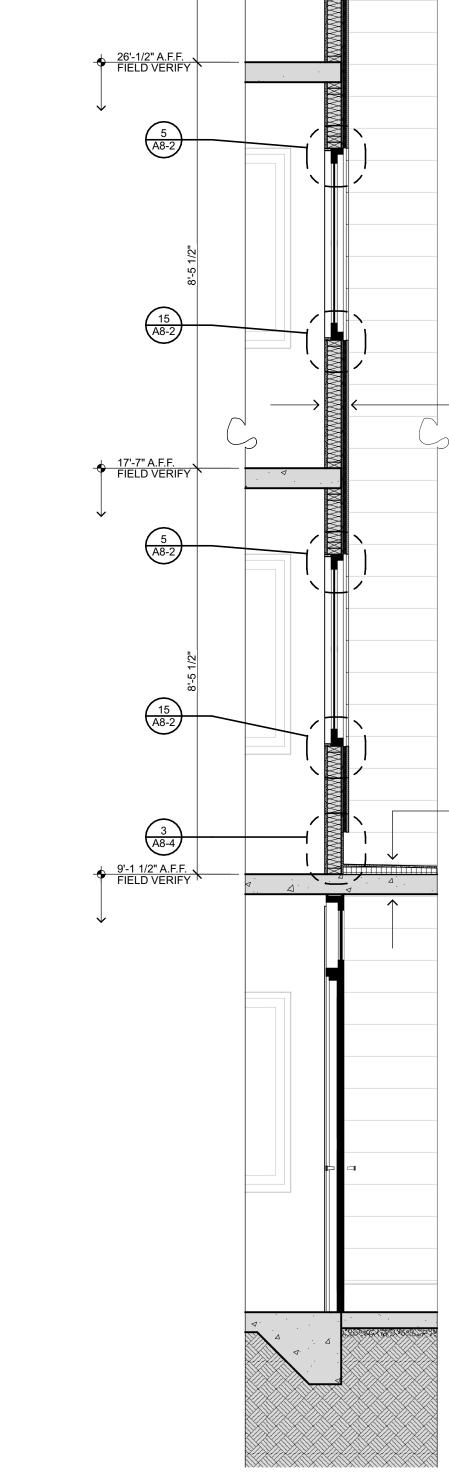

WALL SECTION

1/2" = 1'-0"

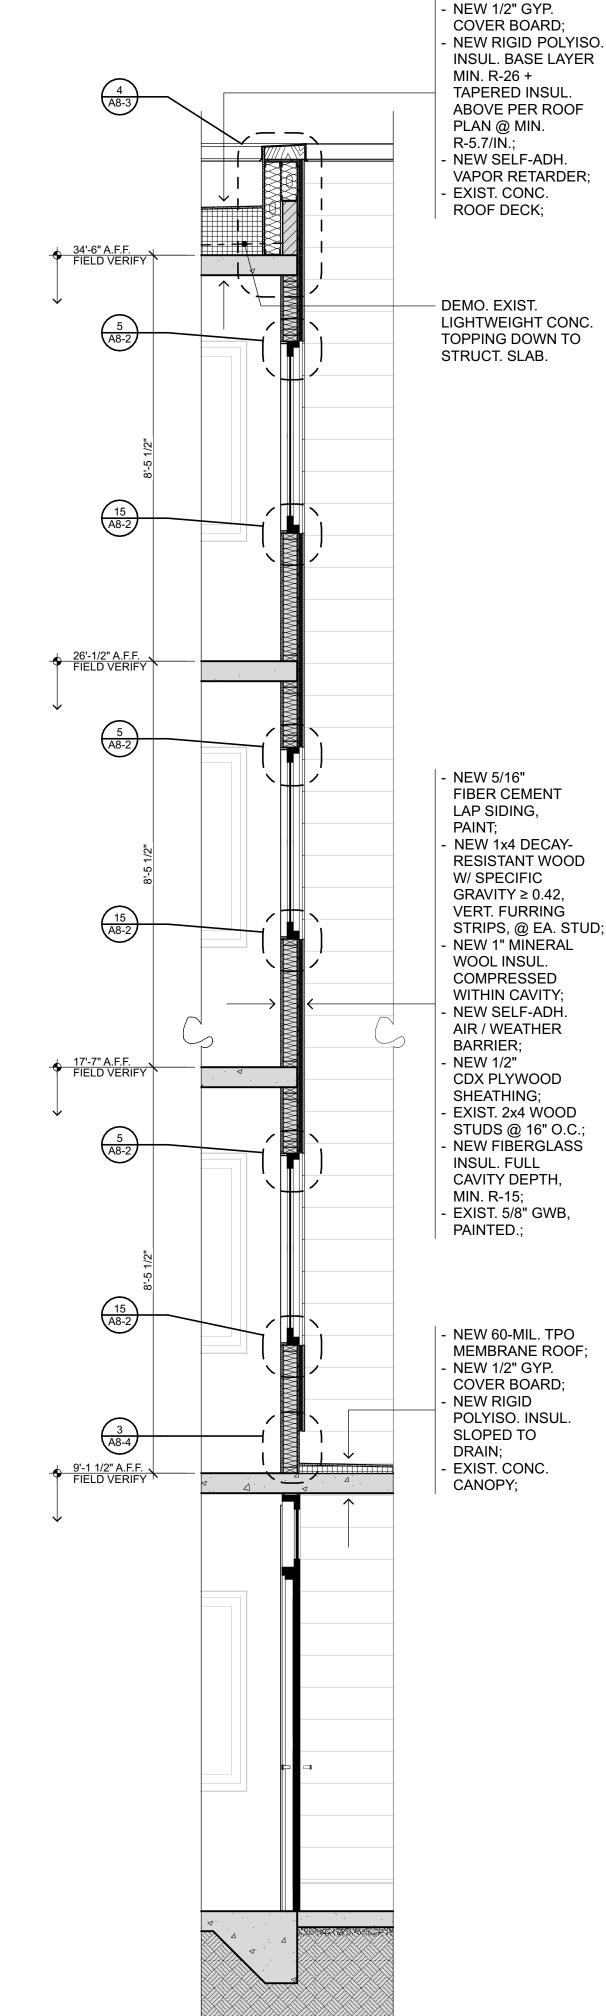

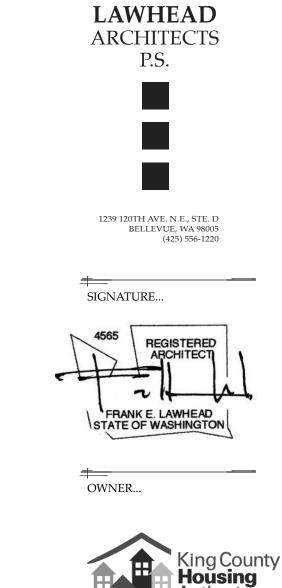

NEW 60-MIL. TPO

MEMBRANE ROOF;

Housing

PHASE... JOB NO... 23-10 DATE... 8/13/24 SHEET TITLE... **Wall Sections**


A5-1


SHEET NO...

1/2" = 1'-0"

WALL SECTION

1/2" = 1'-0"

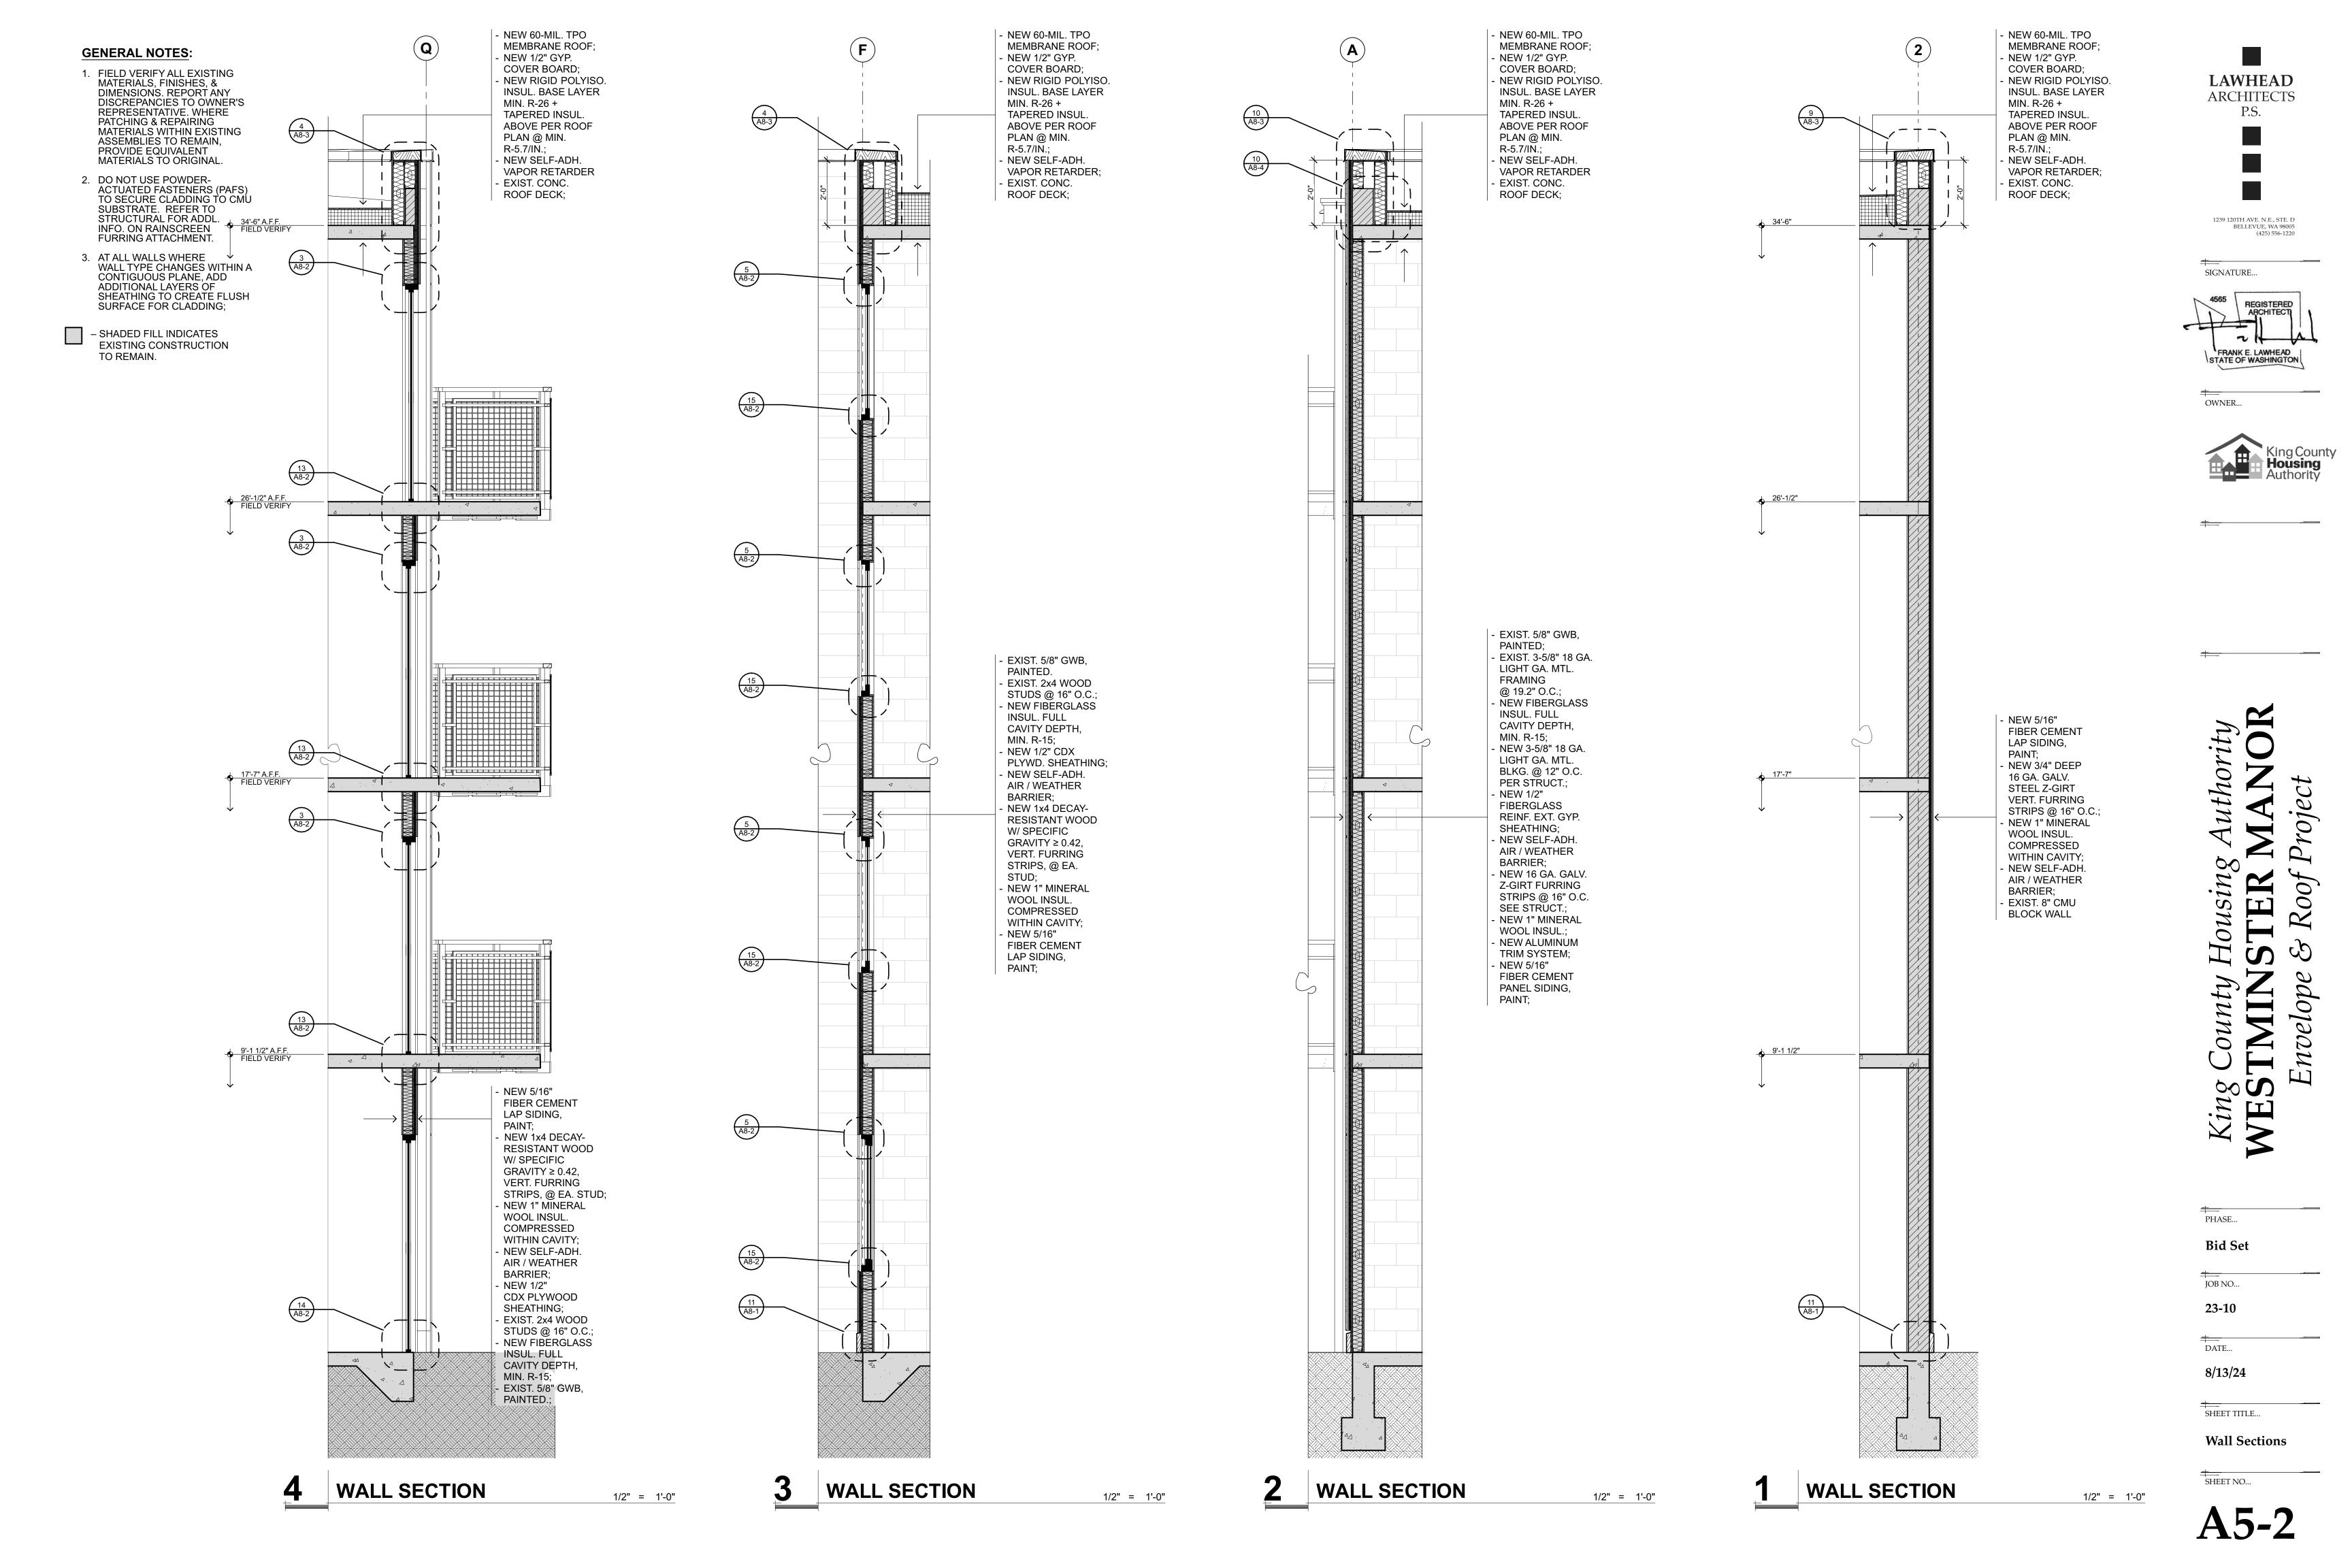

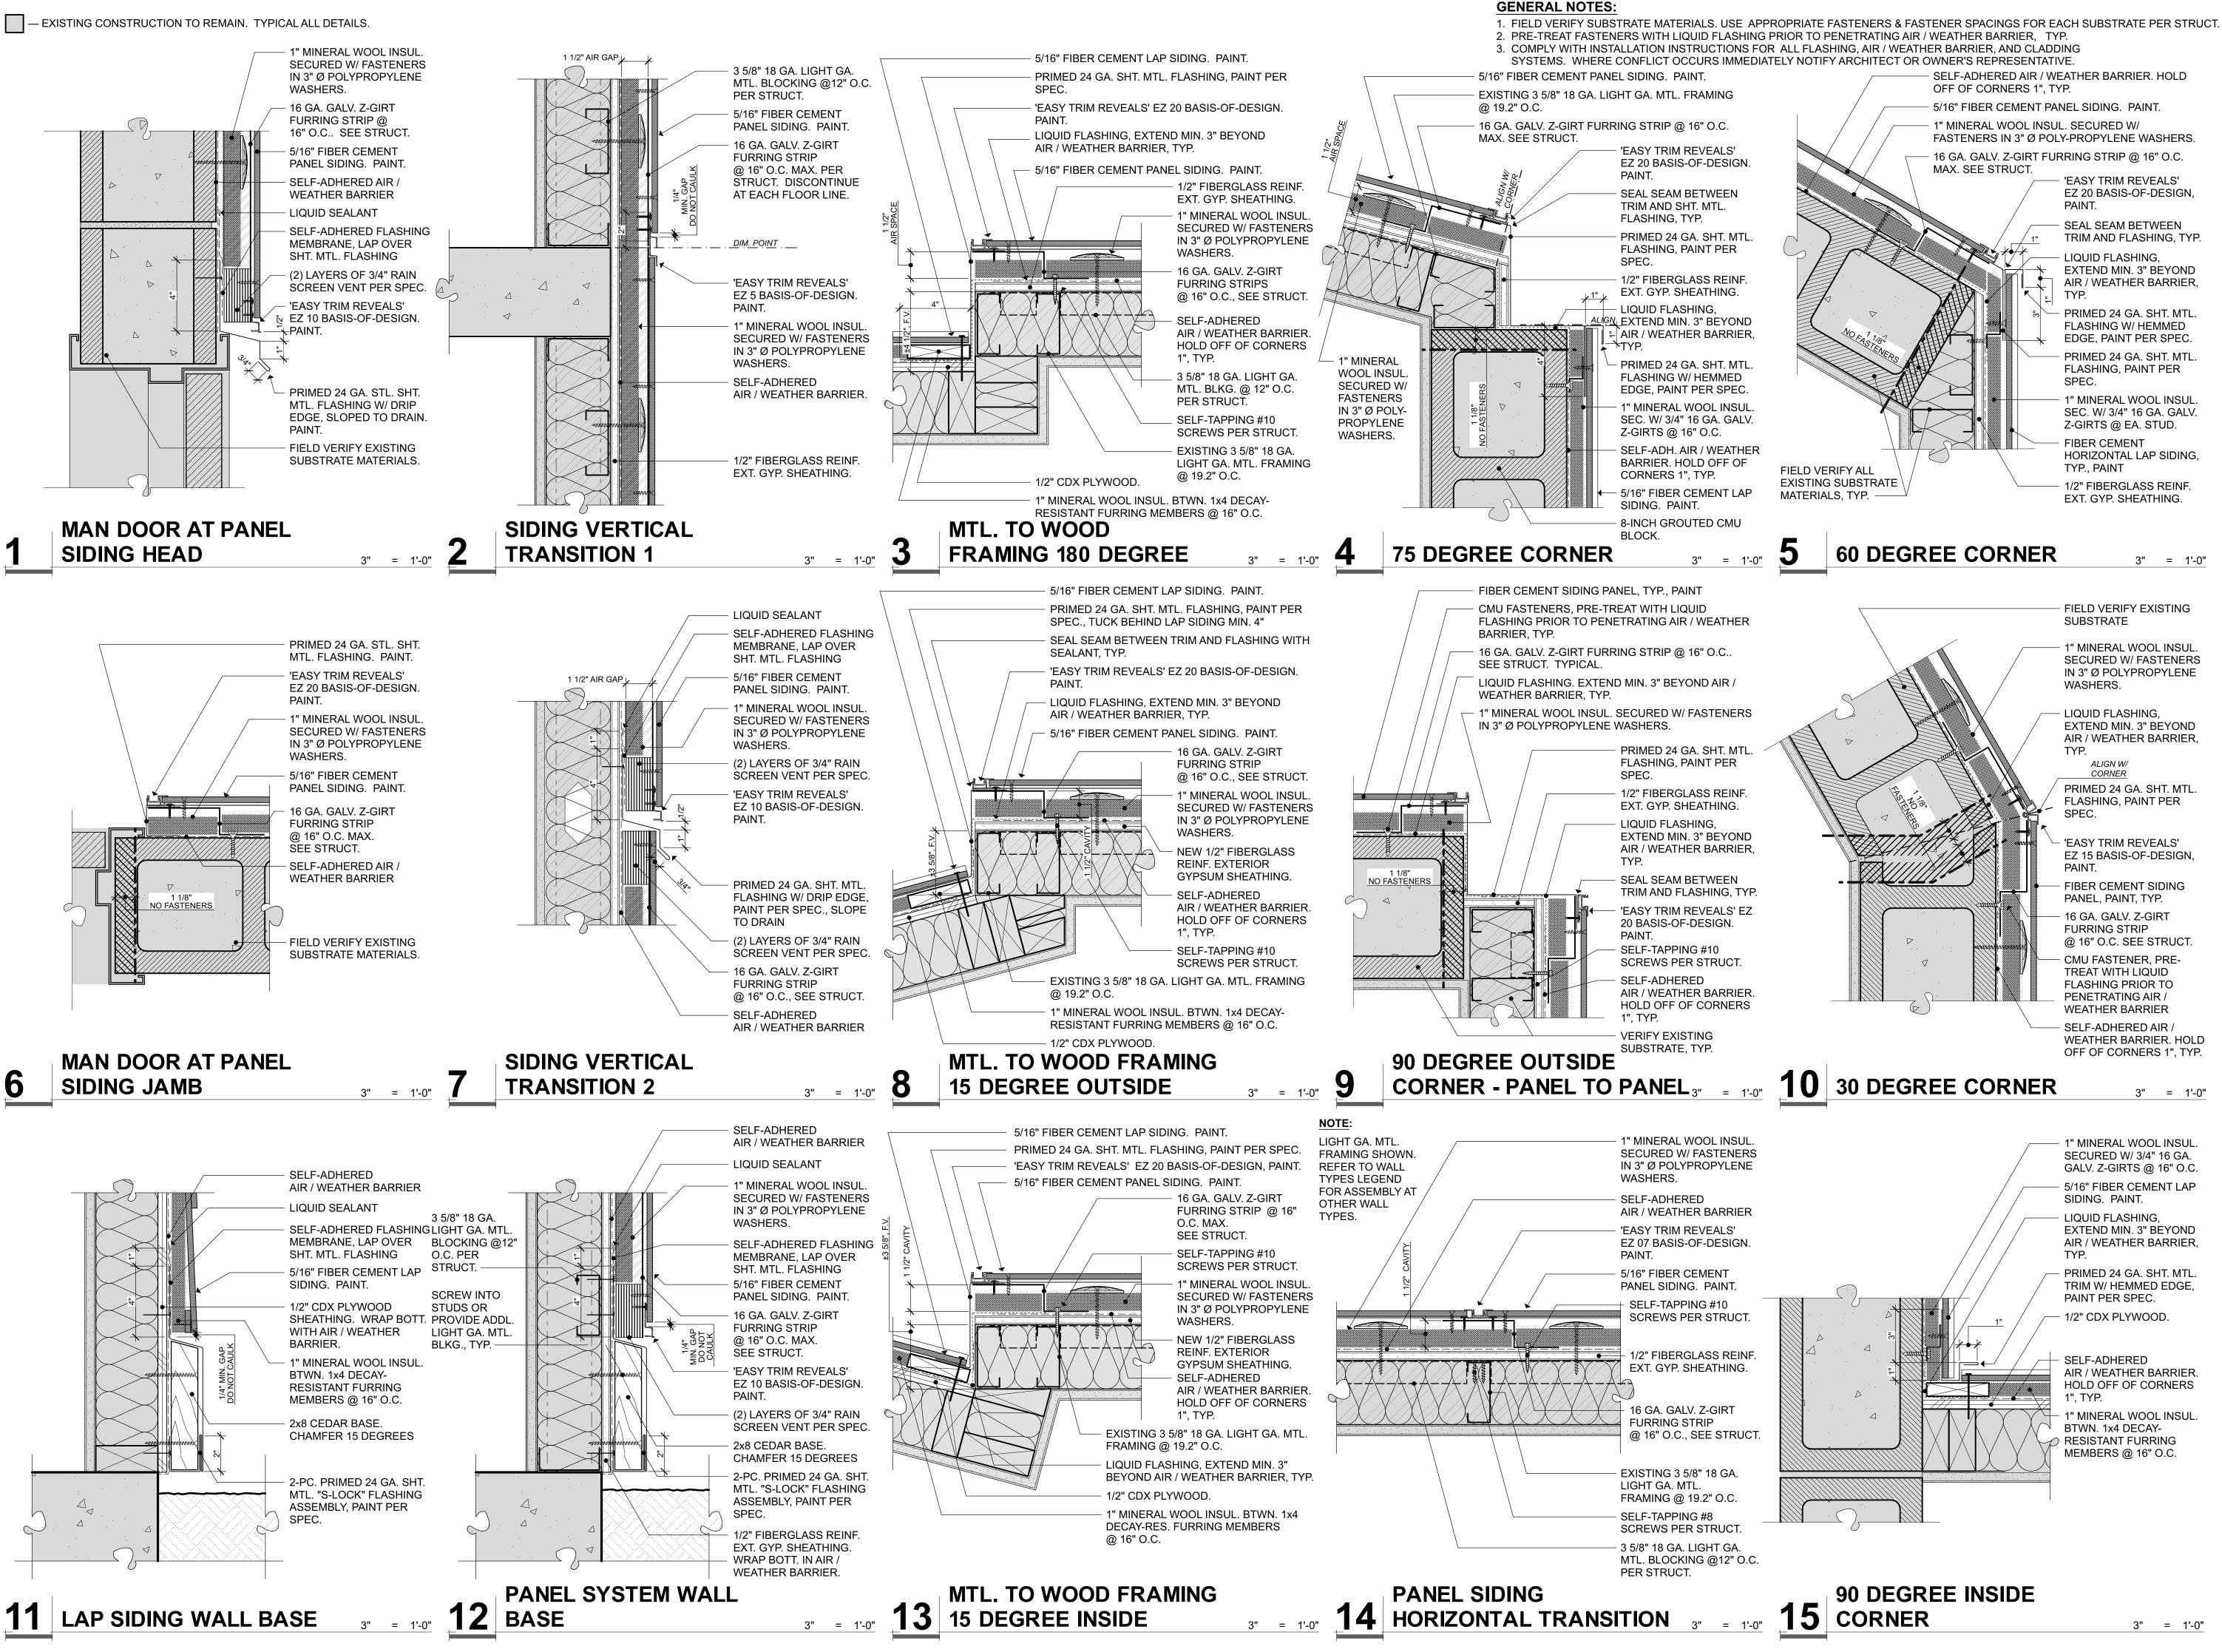

LAWHEAD
ARCHITECTS
P.S.

1239 120TH AVE. N.E., STE. D
BELLEVUE, WA 98005
(425) 556-1220

SIGNATURE...

4565
REGISTERED
ARCHITECT

FRANK E. LAWHEAD
STATE OF WASHINGTON

FRANK E. LAWHEAD STATE OF WASHINGTON OWNER...

g County Housing Authority
STMINSTER MANO!

PHASE...

Bid Set

JOB NO...
23-10

10

DATE...
8/13/24

Ext. Details

+---

SHEET NO...

SHEET TITLE...

A8-1

ROOF ACCESS DOOR

THRESHOLD

REMOVE EXISTING JAMB FINISH & REPLACE WITH LIKE MATERIALS. PAINT TO MATCH ADJACENT INTERIOR WALLS. **ANGLED OUT DOOR JAMB** 1/2" FIBERGLASS REINF. EXT. GYP. SHEATHING, TYP.

16 GA. GALV. Z-GIRT

SELF-TAPPING #10

SELF-ADHERED AIR /

SCREWS PER STRUCT.

EXISTING 3 5/8" 18 GA.

@ 19.2" O.C.

@ 16" O.C., SEE STRUCT.

WEATHER BARRIER. HOLD

OFF OF CORNERS 1", TYP.

LIGHT GA. MTL. FRAMING

1/2" FIBERGLASS REINF.

3" = 1'-0"

EXT. GYP. SHEATHING.

1/2" CDX PLYWOOD.

16 GA. GALV. Z-GIRT

@ 16" O.C.. SEE STRUCT.

1" MINERAL WOOL INSUL.

SELF-ADHERED AIR /

SELF-TAPPING #10

@ 19.2" O.C.

SCREWS PER STRUCT.

EXISTING 3 5/8" 18 GA.

1/2" FIBERGLASS REINF.

EXT. GYP. SHEATHING.

LIGHT GA. MTL. FRAMING

GLASS

DOOR

SECURED W/ FASTENERS

WEATHER BARRIER, HOLD

OFF OF CORNERS 1", TYP.

FURRING STRIP

WASHERS.

FURRING STRIPS

LIQUID FLASHING, EXTEND MIN. 3" BEYOND AIR / WEATHER BARRIER, EXISTING 3 5/8" 18 GA. LIGHT GA. MTL. FRAMING @ 19.2" O.C. CEDAR BLOCKING. SELF-ADHERED AIR / WEATHER BARRIER. HOLD OFF OF CORNERS 1", TYP. 1" MINERAL WOOL INSUL SECURED W/ FASTENERS IN 3" Ø POLYPROPYLENE WASHERS. SELF-TAPPING #10 SCREWS PER STRUCT. 16 GA. GALV. Z-GIRT FURRING STRIPS @ 16" O.C.. SEE STRUCT. - 5/16" FIBER CEMENT PANEL SIDING. PAINT. 'EASY TRIM REVEALS' EZ 20 BASIS-OF-DESIGN SEAL SEAM BTWN. TRIM & FLASHING, TYP. 2-PC, "S-LOCK" PRIMED 24 GA, SHT, MTL, FLASHING ASSEMBLY, PAINT PER SPEC. EXISTING STOREFRONT WINDOW.

PANEL SIDING TO 12 STOREFRONT JAMB

EXISTING SUBSTRATE, F.V. SELF-ADHERED AIR / WEATHER BARRIER, HOLD 1" MINERAL WOOL OFF OF CORNERS 1", TYP. INSUL. BTWN. 1x4 **DECAY-RESISTANT** FIBER CEMENT **FURRING MEMBERS** HORIZONTAL LAP SIDING. @ 16" O.C.-TYP., PAINT REMOVE 1" MINERAL WOOL INSUL. AND BTWN. 1x4 DECAY-**REPLACE** RESISTANT FURRING **EXISTING** MEMBERS @ 16" O.C. TRIM. 1/2" CDX PLYWOOD. MATCH **EXISTING** LIQUID SEALANT MATERIALS,

SELF-ADHERED FLASHING DIMENSION, MEMBRANE, LAP OVER PROFILE, & SHT. MTL. FLASHING PAINT **COLOR** PRIMED 24 GA. SHT. MTL. HEAD FLASHING W/ DRIP EDGE, PAINT PER SPEC., SLOPE TO DRAIN.

> **DOOR UNIT** LIQUID FLASHING, EXTEND MIN. 3" BEYOND AIR / WEATHER BARRIER,

CORNER.

EXTEND HORIZONTALLY

TO NEAREST INSIDE

NEW SLIDING GLASS

REMOVE EXISTING HEAD FINISH AND REPLACE WITH LIKE MATERIALS, PAINT TO MATCH ADJACENT INTERIOR WALLS.

5/16" FIBER CEMENT PANEL SIDING. PAINT.

TYP. DOOR HEAD PRIMED 24 GA. SHT. MTL. FLASHING ON 24 GA SHT. MTL. CLEAT. PAINT PER SPEC. SEAL SEAM BTWN. TRIM AND FLASHING, TYP. METAL TRIM CHANNEL PER SPEC

1" MINERAL WOOL INSUL. SECURED W/ FASTENERS IN 3" Ø POLYPROPYLENE WASHERS. 24 GA. GALV. SELF-TAPPING #10 IN 3" Ø POLYPROPYLENE 4"x4" L-FLASHING SCREWS PER STRUCT. **BEHIND EMBEDDED** 16 GA. GALV. Z-GIRT IN ELASTOMERIC FURRING STRIPS COATING BELOW. @ 16" O.C.. SEE STRUCT. SELF-ADHERED AIR / WEATHER BARRIER. HOLD OFF OF CORNERS 1", TYP. EXISTING 3 5/8" 18 GA. LIGHT GA. MTL. FRAMING @ 19.2" O.C. 1/2" FIBERGLASS REINF. EXT. GYP. SHEATHING. 1/2" CDX PLYWOOD. SLIDING DECAY-RES. WD. NAILER CUT TO FIT. F.V. DIM.

LINEAR DOOR JAMB

AIR / WEATHER BARRIER, TYP. REMOVE & REPLACE EXISTING TRIM. MATCH EXISTING MATERIALS, DIMENSION, PROFILE, & PAINT COLOR

LIQUID FLASHING, EXTEND MIN. 3" BEYOND

REMOVE EXISTING JAMB FINISH & REPLACE WITH LIKE MATERIALS, PAINT TO MATCH ADJACENT INTERIOR WALLS.

3" = 1'-0"

NEW SLIDING GLASS DOOR UNIT LIQUID FLASHING CEDAR FILLER PIECE **WRAPPED IN PRIMED 24** GA. SHT. MTL. FLASHING, PAINT PER SPEC. BOTT. LEG EMBEDDED IN ELASTOMERIC COATING. **SPRAY-ON ELASTOMERIC** COATING PER SPEC. SELF-ADHERED AIR / WEATHER BARRIER PRIMED 24 GA. SHT. MTL FLASHING, PAINT PER 1" MINERAL WOOL INSUL. BTWN. 1x4 DECAY-

RESISTANT FURRING MEMBERS @ 16" O.C. 5/16" FIBER CEMENT LAP SIDING. PAINT.

1/2" CDX PLYWOOD

3" = 1'-0" 13 TYP. DOOR THRESHOLD

GENERAL NOTES:

1. FIELD VERIFY SUBSTRATE MATERIALS. USE APPROPRIATE FASTENERS & FASTENER SPACINGS FOR EACH SUBSTRATE PER STRUCT. & MFR..

2. PRE-TREAT FASTENERS WITH LIQUID FLASHING PRIOR TO PENETRATING AIR / WEATHER BARRIER. TYP.

3. COMPLY WITH INSTALLATION INSTRUCTIONS FOR ALL FLASHING, AIR / WEATHER BARRIER, AND CLADDING SYSTEMS. WHERE CONFLICT OCCURS IMMEDIATELY NOTIFY ARCHITECT OR OWNER'S REPRESENTATIVE. EXISTING SUBSTRATE, F.V. PRIMED 24 GA. SHT. MTL. FLASHING ON 24 GA. SHT. MTL. CLEAT. PAINT 1/2" CDX PLYWOOD. PER SPEC. SEAL SEAM BETWEEN TRIM & SELF-ADHERED AIR / FLASHING, TYP. WEATHER BARRIER. HOLD METAL TRIM CHANNEL OFF OF R.O. 1", TYP. FIBER CEMENT HORIZ. 5/16" FIBER CEMENT LAP SIDING, TYP., PAINT PANEL SIDING. PAINT. WHERE IT OCCURS, - LIQUID SEALANT 16 GA. GALV. Z-GIRT **REMOVE & REPLACE** FURRING STRIP SELF-ADHERED FLASHING EXISTING TRIM. @ 16" O.C., SEE STRUCT. MEMBRANE, LAP OVER MATCH EXISTING SHT. MTL. FLASHING SELF-ADHERED AIR / MATERIALS, DIM., NEW VINYL WEATHER BARRIER. HOLD PROFILE, & PAINT 1" MINERAL WOOL INSUL. WINDOW OFF OF CORNERS 1", TYP. COLOR BTWN. 1x4 DECAY-RES. UNIT FURRING MEMBERS SELF-TAPPING #10 @ 16" O.C. SCREWS PER STRUCT. 1" MINERAL WOOL INSUL. SECURED W/ FASTENERS IN 3" Ø POLYPROPYLENE WASHERS. PRIMED 24 GA. SHT. MTL. EXISTING 3 5/8" 18 GA. FLASHING W/ DRIP EDGE, LIGHT GA. MTL. FRAMING PAINT PER SPEC. @ 19.2" O.C. SLOPE TO DRAIN


DECAY-RES. NAILER CUT TO FIT. F.V. DIM. 1/2" CDX PLYWOOD. LIQUID FLASHING, EXTEND MIN. 3" BEYOND LIQUID FLASHING, EXTEND MIN. 3" BEYOND AIR / WEATHER BARRIER, TYP. AIR / WEATHER BARRIER. TYP.

REMOVE EXISTING HEAD FINISH AND REPLACE WHERE IT OCCURS, REMOVE AND REPLACE WITH LIKE MATERIALS, PAINT TO MATCH ADJACENT EXISTING TRIM. MATCH EXISTING MATERIALS, INTERIOR WALLS. DIMENSION, PROFILE, & PAINT COLOR **ANGLED WINDOW JAMB** TYP. WINDOW HEAD

3" = 1'-0"

NEW VINYL WINDOW UNIT - 1x3 CEDAR NAILER 5/16" FIBER CEMENT LAP PRIMED 24 GA. SHT. MTL. FLASHING ON 24 GA. SHT. SIDING. PAINT. MTL. CLEAT, PAINT PER SPEC. 1" MINERAL WOOL INSUL. SEAL SEAM BETWEEN TRIM AND FLASHING, TYP. SECURED W/ 3/4" 16 GA. GALV. Z-GIRTS @ 16" O.C. SELF-ADHERED AIR / WEATHER BARRIER, HOLD OFF OF CORNERS 1", TYP. PRIMED 24 GA. SHT. MTL. FLASHING, PAINT PER SPEC. **NEW VINYL WINDOW UNIT** A A - 1/2" CDX PLYWOOD. FURR OUT JAMB AS REQ. COORD. W/ WINDOW DIM. \downarrow LIQUID FLASHING, SEXTEND MIN. 3" BEYOND AIR / WEATHER BARRIER, $\times \P \setminus$ 1/2" FIBERGLASS REINF. EXT. GYP. REMOVE EXISTING JAMB SHEATHING. FINISH AND REPLACE WITH LIKE MATERIALS, LIQUID FLASHING, EXTEND MIN. 3" REMOVE EXISTING PAINT TO MATCH BEYOND AIR / WEATHER BARRIER, TYP. JAMB FINISH AND ADJACENT INTERIOR REPLACE WITH LIKE WHERE IT OCCURS, REMOVE & EXISTING SUBSTRATE, F.V. WALLS. MATERIALS, PAINT TO REPLACE EXISTING TRIM. MATCH MATCH ADJACENT EXISTING MATERIALS, DIMENSION,

WINDOW JAMB AT INTERIOR WALLS. **CORNER LINEAR WINDOW JAMB**

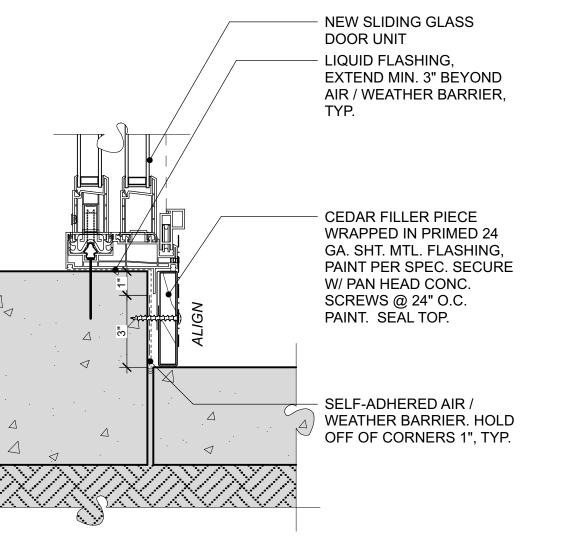

FIRST FLOOR DOOR THRESHOLD

REMOVE EXISTING SILL FINISH AND REPLACE WITH LIKE MATERIALS, PAINT TO MATCH ADJACENT INTERIOR WALLS. **NEW VINYL WINDOW UNIT** SEAL SEAM BETWEEN TRIM & WINDOW, TYP. PRIMED 24 GA. SHT. MTL. FLASHING, PAINT PER SPEC. FIBER CEMENT HORIZONTAL LAP SIDING TYP., PAINT SELF-ADHERED AIR / WEATHER BARRIER. HOLD OFF OF CORNERS 1", TYP LIQUID FLASHING, EXTEND MIN. 3" BEYOND AIR / WEATHER BARRIER, 1" MINERAL WOOL INSUL BTWN. 1x4 DECAY-RESISTANT FURRING MEMBERS @ 16" O.C. 1/2" CDX PLYWOOD. WHERE IT OCCURS, REMOVE & REPLACE EXISTING TRIM MATCH EXISTING MATERIALS, DIMENSION, PROFILE, &

3" = 1'-0" **15** TYP. WINDOW SILL

PAINT COLOR

LAWHEAD ARCHITECTS 1239 120TH AVE. N.E., STE. D BELLEVUE, WA 9800 SIGNATURE...

STATE OF WASHINGTON

OWNER...

NEW VINYL WINDOW UNIT

MTL. TRIM CHANNEL, TYP.

1" MINERAL WOOL INSUL.

SECURED W/ FASTENERS

IN 3" Ø POLYPROPYLENE

FIBER CEMENT SIDING

WEATHER BARRIER. HOLD

OFF OF CORNERS 1". TYP.

@ 16" O.C., SEE STRUCT.

PANEL, TYP., PAINT

SELF-ADHERED AIR /

16 GA. GALV. Z-GIRT

SELF-TAPPING #10

SCREWS PER STRUCT.

EXISTING 3 5/8" 18 GA.

LIGHT GA. MTL. FRAMING

FURRING STRIP

@ 19.2" O.C.

PROFILE, & PAINT COLOR


WASHERS.

3" = 1'-0"

PHASE... **Bid Set** JOB NO... 23-10 DATE... 8/13/24 SHEET TITLE...

Ext. Details

SHEET NO...

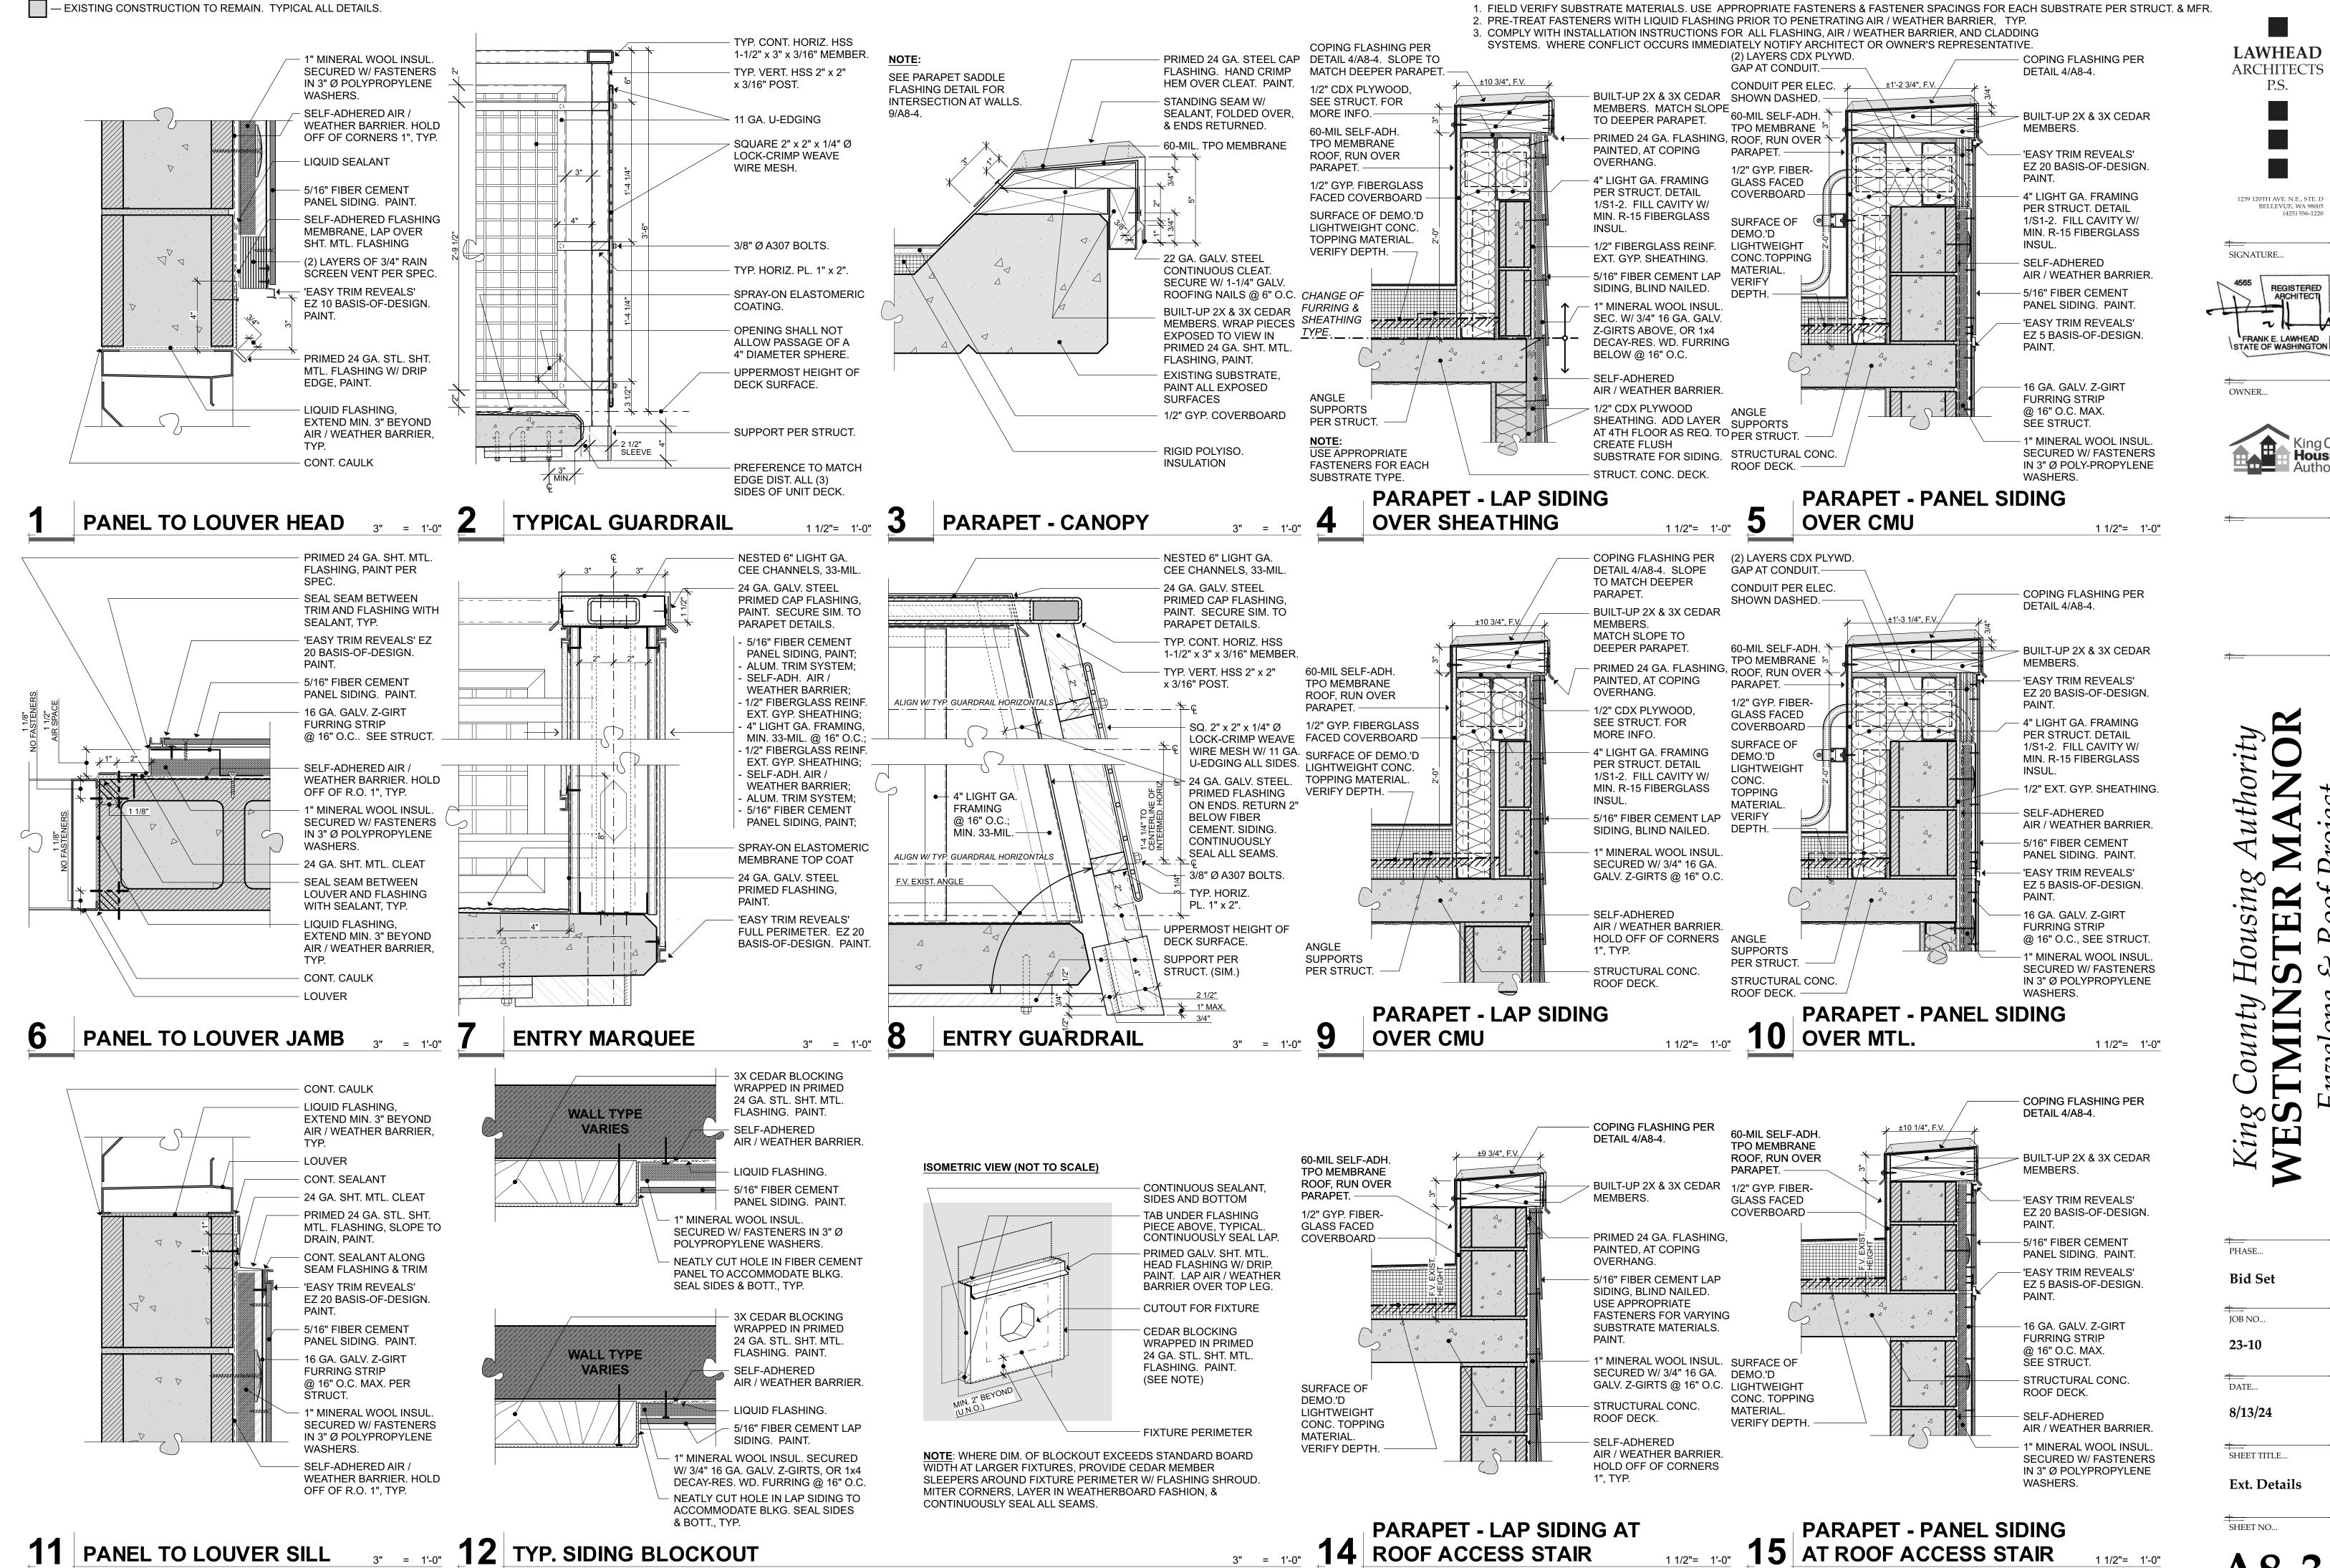

GENERAL NOTES:

E

60-MIL TPO ROOF MEMBRANE:

TAPERED PERLITE INSUL. BOARD;

1/2" FIBERGLASS REINF.

GYP. COVERBOARD;

CONCRETE CANOPY

EXISTING:

- SEAL AROUND

& PENETRATION.

NEW CUT OPENING

HEAT WELDED

TPO FLASHING

TYP. CLAMP

INTO DRAIN

ASSEMBLIES.

STRIP,

- 60-MIL TPO ROOF MEMBRANE;

- RIGID INSULATION;

BOARD;

EXISTING

TYPICAL FALL

1/2" GYPSUM COVER

- CONCRETE ROOF DECK;

PROTECTION STANCHION 1 1/2" 1'-0" 12 CANOPY ROOF DRAIN

EXISTING ROOF DRAIN.

IN SAME LOCATION.

REMOVE & INSTALL NEW

'HERCULES RETRODRAIN'

PHASE... **Bid Set** EXT. GYP. SHEATHING. JOB NO... 5/16" FIBER CEMENT 23-10 PANEL SIDING. PAINT. NEATLY CUT HOLE IN FIBER CEMENT PANEL TO DATE... BLOCKING. SEAL ON ALL 8/13/24 SHEET TITLE... STRAP, – HEM EDGES. 24 GA. PRIMED SHT. MTL. Ext. Details DOWNSPOUT, PAINT. SEE

SPEC. FOR MORE INFO. TYP. DOWNSPOUT SHEET NO... 15 BRACKET 3" = 1'-0"

ACCOMMODATE

SIDES, TYP.

LAWHEAD

ARCHITECTS

1239 120TH AVE N F STF D

STATE OF WASHINGTON

SIGNATURE...

OWNER...

.

Sousing

ER

E

BELLEVUE, WA 98005

(425) 556-1220

— EXISTING CONSTRUCTION TO REMAIN. TYPICAL ALL DETAILS.

GENERAL NOTES:

1. FIELD VERIFY SUBSTRATE MATERIALS. USE APPROPRIATE FASTENERS & FASTENER SPACINGS FOR EACH SUBSTRATE PER STRUCT. & MFR.


2. PRE-TREAT FASTENERS WITH LIQUID FLASHING PRIOR TO PENETRATING AIR / WEATHER BARRIER, TYP. 3. COMPLY WITH INSTALLATION INSTRUCTIONS FOR ALL FLASHING, AIR / WEATHER BARRIER, AND CLADDING


SYSTEMS. WHERE CONFLICT OCCURS IMMEDIATELY NOTIFY ARCHITECT OR OWNER'S REPRESENTATIVE.

IN LIEU OF HEAD FLASHING W/ DRIP.

1 1/2"= 1'-0"

CONDUIT ENCLOSURE

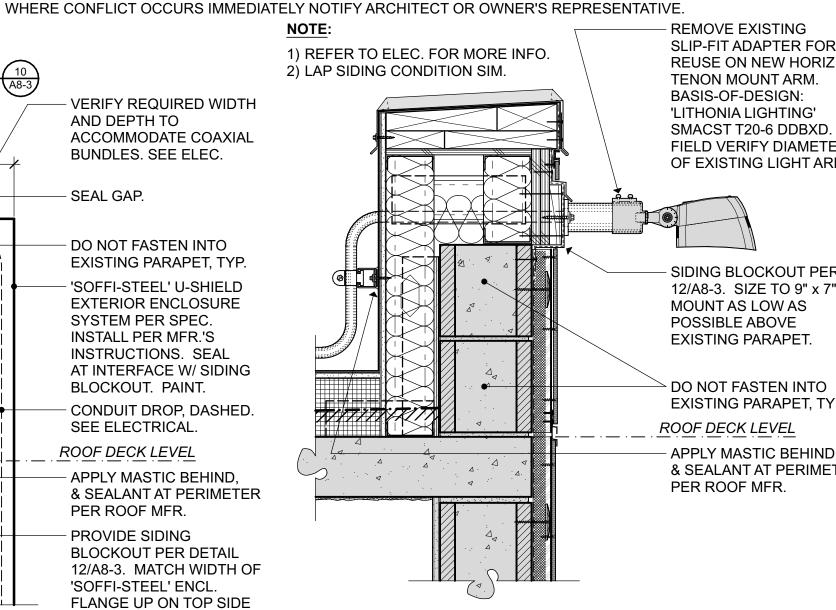

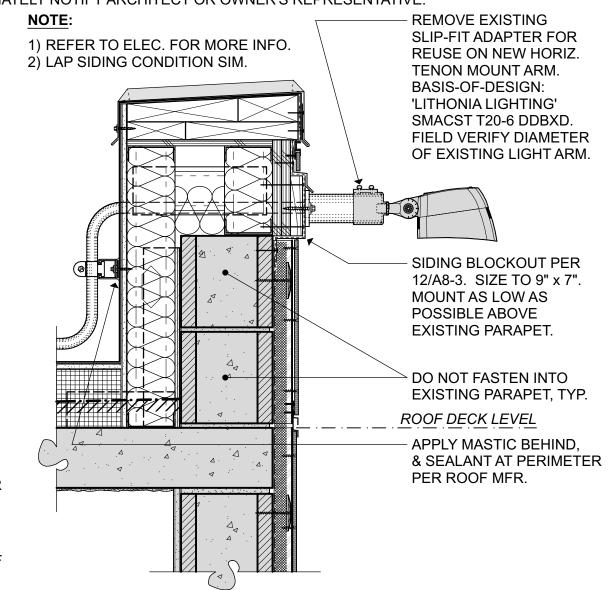

King County Housing

1 1/2"= 1'-0"

NOTE:

DETAIL APPLIES TO

OWNER...

LAWHEAD

ARCHITECTS

1239 120TH AVE. N.E., STE. D BELLEVUE, WA 98005

SIGNATURE...

(425) 556-1220


REGISTERED

STATE OF WASHINGTON

VERTICAL FLASHING PIECES SHOWN IN DETAILS: 3/A8-1; 4/A8-1; 5/A8-1; 8/A8-1; 9/A8-1; 13/A8-1; & 1/A8-4. PRIMED 24 GA. STL. SHT. MTL. FLASHING W/ DRIP EDGE, PAINT. ALLOW FREE MOVEMENT BETWEEN UPPER & LOWER FLASHING PIECES. - LIQUID FLASHING.

AREA LIGHT AT PARAPET

TYP. FLASHING VERTICAL TRANSITION AT FLOORS

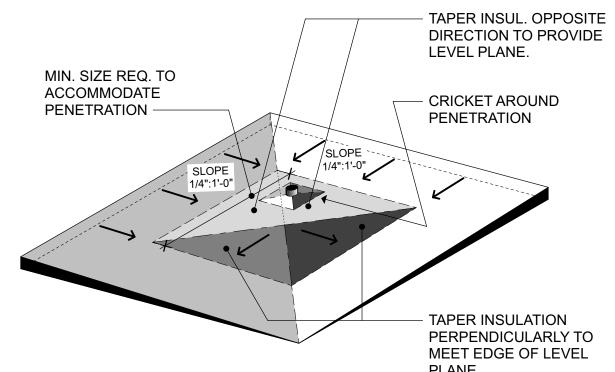

PLANE. 8/13/24 SHEET TITLE... Ext. Details SHEET NO...

TYP. CRICKET AT VALLEY PENETRATIONS

3/4" = 1'-0"

PHASE...

Bid Set

JOB NO...

23-10

DATE...

thori

ALL METHODS, MATERIALS AND WORKMANSHIP SHALL CONFORM TO THE 2018 INTERNATIONAL BUILDING CODE (IBC) AS AMENDED AND ADOPTED BY THE LOCAL BUILDING OFFICIAL OR APPLICABLE JURISDICTION.

DESIGN CRITERIA

10 SF

20 SF

50 SF

100 SF

- EXPOSURE CATEGORY = B
- BASIC WIND SPEED, (3 SEC. GUST), V_{ULT} = 98 MPH; V_{ASD} = 76 MPH
- RISK CATEGORY PER IBC TABLE 1604.5 = II
- TOPOGRAPHIC FACTOR K_{ZT} = 1.0
- INTERNAL PRESSURE COEFFICIENT (ENCLOSED) = ± 0.18 - COMPONENTS AND CLADDING LOADS, SEE THE FOLLOWING TABLES:

16.0

16.0

16.0

		F	ROOF SURFAC	CES ¹				
	POSITIVE PRESSURES	NEGATIVE PRESSURES (PSF)						
EFFECTIVE WIND AREA	(PSF)	_						
	ALL ZONES	1	2	2'	3	3'		

-23.1

-22.8

-21.8

-21.5

-27.4

-26.2

	WALL SURFACE	S AND ROOF O	VERHANGS	1			
	POSITIVE PRE	NEGATIV	NEGATIVE PRESSURE (PSF)				
EFFECTIVE WIND AREA		ZO			NE ²		
	4	5	4		5		
10 SF	18.4	18.4	-20.0		-24.6		
20 SF	17.6	17.6	-19.1		-23.0		
50 SF	16.5	16.5	-18.0		-20.8		
100 SF	16.0	16.0	-17.2		-19.1		
500 SF	16.0	16.0	-16.0		-16.0		

-20.0

-20.0

1. VALUES SHOWN IN TABLE ARE GROSS ULTIMATE WIND PRESSURES.

2. WALL ZONES ARE AS DEFINED BY FIGURE 30.3-1 FOR ASCE 7-16 IN LOW RISE BUILDINGS.

SEISMIC: (ASCE 7-16)

BRACE EXISTING UNREINFORCED MASONRY PARAPETS SEISMIC IMPORTANCE FACTOR, Ie = II RISK CATEGORY OF BUILDING PER IBC TABLE 1604.5 = II DESIGN SPECTRAL RESPONSE ACCELERATIONS S_{DS} = 1.024 ANALYSIS PROCEDURE USED = SEISMIC DEMANDS ON NONSTRUCTURAL COMPONENTS

POST-INSTALLED ANCHORS

POST-INSTALLED ANCHORS: INSTALL IN ACCORDANCE WITH THE MANUFACTURER'S PUBLISHED INSTALLATION INSTRUCTIONS. INSTALLER SHALL BE QUALIFIED AND TRAINED BY THE MANUFACTURER. HOLES SHALL BE HAMMER DRILLED ONLY (ROTARY DRILLED ONLY AT UNREINFORCED MASONRY - NO HAMMER TOOLS).

CONCRETE ANCHORS

- SCREW ANCHORS: KWIK HUS-EZ (ICC ESR-3027) BY HILTI, INC.

- ADHESIVE ANCHORS: HILTI HIT-HY 270 WITH SCREEN TUBES AT HOLLOW CMU (ICC-ESR-4143) BY HILTI, INC. - SCREW ANCHORS: HILTI KIWK CON II BY HILTI, INC.

STRUCTURAL STEEL

MATERIAL PROPERTIES

HOLLOW STRUCTURAL SECTIONS: ASTM A500, GRADE C (Fy=50KSI)

SHAPES AND PLATES: ASTM A36 (Fy = 36 KSI) TYP.

WELDING

STRUCTURAL STEEL: WELD IN ACCORDANCE WITH "STRUCTURAL WELDING CODE" AWS D1.1.

<u>CERTIFICATION</u>: ALL WELDING SHALL BE PERFORMED BY WABO CERTIFIED WELDERS. WELDERS SHALL BE PREQUALIFIED FOR EACH POSITION AND WELD TYPE WHICH THE WELDER WILL BE PERFORMING.

WELD TYPE	FILLER METAL TENSILE STRENGTH	CHARPY V-NOTCH (CVN) RATING
FILLET	70 KSI	
PARTIAL PENETRATION	70 KSI	
COMPLETE PENETRATION	70 KSI	20 FT-LBS @ 40 DEG F

ADHESIVE ANCHOR RODS: FULLY THREADED ASTM F1554, GRADE 36.

COLD-FORMED STEEL FRAMING CONSTRUCTION

THE DESIGN, INSTALLATION AND CONSTRUCTION OF COLD-FORMED CARBON OR LOW-ALLOY STEEL STRUCTURAL AND NON-STRUCTURAL STEEL FRAMING, SHALL BE IN ACCORDANCE WITH IBC SECTION 2211 AND AMERICAN IRON AND STEEL INSTITUTE (AISI) STANDARD S100-16 AND S240-15 AND SHALL BE MANUFACTURED BY A MEMBER OF THE STEEL STUD MANUFACTURER'S ASSOCIATION (SSMA), CERTIFIED STEEL STUD ASSOCIATION (CSSA), STEEL FRAMING INDUSTRY ASSOCIATION (SFIA), OR PRE-APPROVED EQUAL, IN ACCORDANCE WITH CURRENT ICC EVALUATION SERVICE REPORT, AISI S202-15 AND S240-15. ALL 54 MIL AND HEAVIER GALVANIZED MEMBERS SHALL BE FORMED FROM STEEL THAT MEETS THE REQUIREMENTS OF ASTM A653, QUALITY SQ. GRADE 50, CLASS 1, FY=50 KSI. ALL 43 MIL AND LIGHTER GALVANIZED MEMBERS SHALL BE FORMED FROM STEEL THAT MEETS THE REQUIREMENTS OF ASTM A653, QUALITY SQ, GRADE 33, FY=33 KSI.

CARPENTRY:

N/A

N/A

N/A

N/A

N/A

-43.3

-38.7

-32.4

-27.8

-30.9

-27.8

-24.6

-21.5

WOOD SHEATHING (STRUCTURAL): SHEATHING SHALL BE PLYWOOD ONLY. WOOD SHEATHING SHALL BE CONFORMING TO PS1-09 AND/OR PS2-10. ALL PANELS SHALL BEAR THE STAMP OF AN APPROVED GRADING AGENCY. SPAN RATING SHALL BE PROVIDED AS (48/24).

NAILS: CONNECTION DESIGNS ARE BASED ON NAILS WITH THE FOLLOWING PROPERTIES:

PENNYWEIGHT	DIAMETER (INCHES)	LENGTH (INCHES)
8d	0.131	2-1/2
10d	0.148	3
16d	0.148	3-1/2
20d	0.192	4

ALL NAILS AND STAPLES SHALL CONFORM TO ASTM F1667 INCLUDING SUPPLEMENT 1

SHOP DRAWINGS/SUBMITTALS

THE FOLLOWING SHOP DRAWINGS/SUBMITTALS SHALL BE PROVIDED FOR REVIEW AND APPROVAL BY THE STRUCTURAL ENGINEER PRIOR TO FABRICATION OR DELIVERY.

		STRUCTURAL ENGR.	BLDG. DEPT.
1.	STRUCTURAL STEEL	X	X
2.	COLD-FORMED STEEL FRAMING	X	X
3.	CONTRACTOR'S STATEMENT OF RESPONSIBILITY	X	X

SPECIAL INSPECTION: SPECIAL INSPECTION SHALL BE PROVIDED BY AN INDEPENDENT TESTING LABORATORY PER THE REQUIREMENTS OF IBC CHAPTER 17 AND THE LOCAL BUILDING OFFICIAL OR APPLICABLE JURISDICTION AND THE CONTRACT DOCUMENTS. THE SPECIAL INSPECTOR SHALL SUBMIT INSPECTION REPORTS AND A FINAL SIGNED REPORT TO THE BUILDING OFFICIAL FOR THE ITEMS LISTED IN THE QUALITY ASSURANCE/SPECIAL INSPECTION SECTION:

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STATEMENT OF SPECIAL INSPECTIONS:

SPECIAL INSPECTION: SPECIAL INSPECTION SHALL BE PROVIDED PER THE REQUIREMENTS OF IBC SECTION 1704 AND 1705 AND AS NOTED HEREIN.

STRUCTURAL SYSTEM	VERIFICATION AND INSPECTION	CONTINUOUS	PERIODIC	COMMENTS	REFERENCES
STEEL CONSTRUCTION	MATERIAL VERIFICATION OF STRUCTURAL STEEL A. FOR STRUCTURAL STEEL, IDENTIFICATION MARKINGS TO CONFORM TO AISC 360		Х	MANUFACTURER TO PROVIDE CERTIFIED MILL TEST REPORTS	AISC 360 CHAPTER N5 AISC 341 CHAPTER J6
	B. MANUFACTURER'S CERTIFIED MILL TEST REPORTS		X		
	MATERIAL VERIFICATION OF WELD FILLER MATERIALS A. IDENTIFICATION MARKINGS TO CONFORM TO AWS SPECIFICATIONS LISTED IN GENERAL NOTES		Х	MANUFACTURER TO PROVIDE CERTIFICATE OF COMPLIANCE	AISC 360 CHAPTER N5
	B. MANUFACTURER'S CERTIFICATE OF COMPLIANCE		X		
	INSPECTION OF WELDING A. COMPLETE AND PARTIAL JOINT PENETRATION GROOVE WELDS B. MULTI-PASS FILLET WELDS C. SINGLE-PASS FILLET WELDS > 5/16" D. PLUG AND SLOT WELDS E. SINGLE-PASS FILLET WELDS ≤ 5/16" F. FIELD-INSTALLED WELDED STUDS G. WELDING OF STAIRS AND RAILING SYSTEMS	X X X X	X X X	SPECIAL INSPECTIONS IN THIS SECTION ARE WAIVED WHERE FABRICATION IS PERFORMED ON THE PREMISES OF A FABRICATOR REGISTERED AND APPROVED IN ACCORDANCE WITH IBC SECTION 1704.2.5	AISC 360 CHAPTER N5 AISC 341 CHAPTER J6 AWS D1.1
CONCRETE	ANCHORS POST-INSTALLED IN HARDENED CONCRETE (MECHANICAL ANCHORS INSTALLED IN ANY DIRECTION AND ADHESIVE ANCHORS INSTALLED DOWNWARD)		Х	PERIODIC INSPECTION TO INCLUDE A QUANTITY OF 10% WITH A MINIMUM OF (5) ANCHORS INSPECTED PER INSTALLER ON A DAILY BASIS.	ACI 318: 17.8.2 MFR EVAL REPORT MFR PUBLISHED INSTALLATION INSTRUCTIONS
MASONRY	POST INSTALLED ANCHORS INTO MASONRY	Х			MFR EVAL REPORT
COLD-FORMED STEEL FRAMING	EXTERIOR WALLS		Х		IBC 1705.11.3, 1705.12.5

TESTING AND SPECIAL INSPECTION REPORTS SHALL BE PREPARED FOR EACH INSPECTION ITEM ON A DAILY BASIS WHENEVER WORK IS PERFORMED ON THAT ITEM. REPORTS SHALL BE DISTRIBUTED TO OWNER, CONTRACTOR, BUILDING OFFICIAL, ARCHITECT AND STRUCTURAL ENGINEER OF RECORD.

GENERAL CONTRACTOR SHALL SUBMIT A WRITTEN CONTRACTOR'S STATEMENT OF RESPONSIBILITY TO THE BUILDING OFFICIAL AND OWNER PRIOR TO COMMENCEMENT OF WORK. THE CONTRACTOR'S STATEMENT OF RESPONSIBILITY SHALL INCLUDE ACKNOWLEDGMENT OF AWARENESS OF THE SPECIAL INSPECTION REQUIREMENTS CONTAINED IN THE STATEMENT OF SPECIAL INSPECTION.

			ABBREV	IATION LIST			
@	AT	D.F.	DOUGLAS FIR	HGR	HANGER	P.P.T.	PRESERVATIVE PRESSURE TREATED
A.B.	ANCHOR BOLT	DIA. OR Ø	DIAMETER	HORIZ.	HORIZONTAL	P.S.F.	POUNDS PER SQUARE FOOT
ADD'L	ADDITIONAL	DIAG.	DIAGONAL	HSS	HOLLOW STRUCTURAL SECTION	PSL	PARALLAM
A.F.F.	ABOVE FINISH FLOOR	DIM.	DIMENSION	HT	HEIGHT	P.T.	POST TENSION
ALT.	ALTERNATE	D.L.	DEAD LOAD	INT.	INTERIOR	PW.	PLYWOOD
ARCH.	ARCHITECTURAL	DWG	DRAWING	JST	JOIST	REINF.	REINFORCING
BLD'G	BUILDING	DWL	DOWEL	JT	JOINT	REQ'D	REQUIRED
BLK'G	BLOCKING	(E)	EXISTING	L	ANGLE	SCHED.	SCHEDULE
BM	BEAM	EA.	EACH	L.L.	LIVE LOAD	S.C.L.SHT'G	STRUCTURAL COMPOSITE LUMBER
B.O.F.	BOTTOM OF FOOTING	E.F.	EACH FACE	LLH	LONG LEG HORIZONTAL	SHT'G	SHEATHING
ВОТ.	ВОТТОМ	EL.	ELEVATION	LLV	LONG LEG VERTICAL	SIM.	SIMILAR
BRG	BEARING	ELEV.	ELEVATOR	LOC.	LOCATION	S.O.G.	SLAB ON GRADE
BTWN	BETWEEN	ENGR.	ENGINEER	LSL	LAMINATED STRAND LUMBER	SQ.	SQUARE
B.V.	BUILT UP	EQ.	EQUAL	L√L	LAMINATED VENEER LUMBER	STD	STANDARD
(C=)	CAMBER	E.M.	EACH WAY	MAX.	MAXIMUM	STIFF.	STIFFENER
CANT.	CANTILEVER	EXP.	EXPANSION	M.B.	MACHINE BOLT	STL	STEEL
C.F.S.	COLD-FORMED STEEL	EXT.	EXTERIOR	MECH.	MECHANICAL	STRUCT.	STRUCTURAL
C.J.	CONTROL/CONSTRUCTION JOINT	FDN	FOUNDATION	MEZZ.	MEZZANINE	T&B	TOP & BOTTOM
<u> </u>	CENTERLINE	F.F.	FAR FACE	MFR	MANUFACTURER	T&G	TONGUE AND GROOVE
CLR.	CLEARANCE	FLR	FLOOR	MIN.	MINIMUM	THR'D	THREADED
CMU	CONCRETE MASONRY UNIT	F.O.M.	FACE OF MASONRY	MISC.	MISCELLANEOUS	T.O.F.	TOP OF FOOTING
COL.	COLUMN	F.O.S.	FACE OF STUD	MTL	METAL	T.O.S.	TOP OF STEEL
CONC.	CONCRETE	FRM'G	FRAMING	N.F.	NEAR FACE	TRT'D	TREATED
CONN.	CONNECTION	F.R.T.	FIRE RETARDANT TREATED	N.S.	NEAR SIDE	TYP.	TYPICAL
CONST.	CONSTRUCTION	F.S.	FAR SIDE	NTS	NOT TO SCALE	U.N.O.	UNLESS NOTED OTHERWISE
CONT.	CONTINUOUS	FTG	FOOTING	O.C.	ON CENTER	U.T.	ULTRASONIC TESTED
CONTR.	CONTRACTOR	GA.	GAGE/GAUGE	OPN'G	OPENING	VERT.	VERTICAL
COORD.	COORDINATE	GALV.	GALVANIZED	OPP.	OPPOSITE	W/	MITH
C.P.	COMPLETE PENETRATION	GL.	GLULAM	P.A.F.	POWDER ACTUATED FASTENER	W.P.	WORK POINT
CTR'D	CENTERED	GR.	GRADE	PERP.	PERPENDICULAR	MT	WEIGHT
C.Y.	CUBIC YARD	GWB	GYPSUM WALL BOARD	P	PLATE	W.W.R.	WELDED WIRE REINFORCING
DBL.	DOUBLE	HDR	HEADER	P.P.	PARTIAL PENETRATION		
	-		-	_ ·	-		

STRUCTURAL DRAWING INDEX				
SHEET NUMBER	SHEET DESCRIPTION			
S1-1	General Notes			
S1-2	Details			
Grand total: 2				

P.S. BELLEVUE, WA 98005

LAWHEAD

ARCHITECTS

PHASE... **Bid Set**

JOB NO...


23-10 DATE...


8/13/24 SHEET TITLE...

General Notes

1%" MINIMUM IS FROM FASTENER TO ALL EDGES OF CONCRETE MANSONRY UNIT BLOCK.

- EXISTING 4" CONCRETE MASONRY UNIT (MASONRY) HOLLOW TYPICAL EXISTING 8" CONCRETE MASONRY UNIT (MASONRY) SOLID GROUTED TYPICAL
- FURRING DISCONTINOUS ACROSS FLOORS. FOR ELEVAITON SEE ARCHITECT. FOR DETAIL SEE 3/S1-2.
- AT EXISTING WOOD STUD WALL FRAMING PROVIDE 2x4 HORIZONTAL BLOCKING AT 16" ON CENTER MAXIMUM VERTICALLY BETWEEN ALL EXISTING STUDS WITH (3) 16D TOE NAIL EACH END TO EXISTING STUD. ATTACH VERTICAL 54MIL 50 KSI Z FURRING @ 16" ON CENTER TO STUDS WITH #10 SCREWS @ 12" O.C.

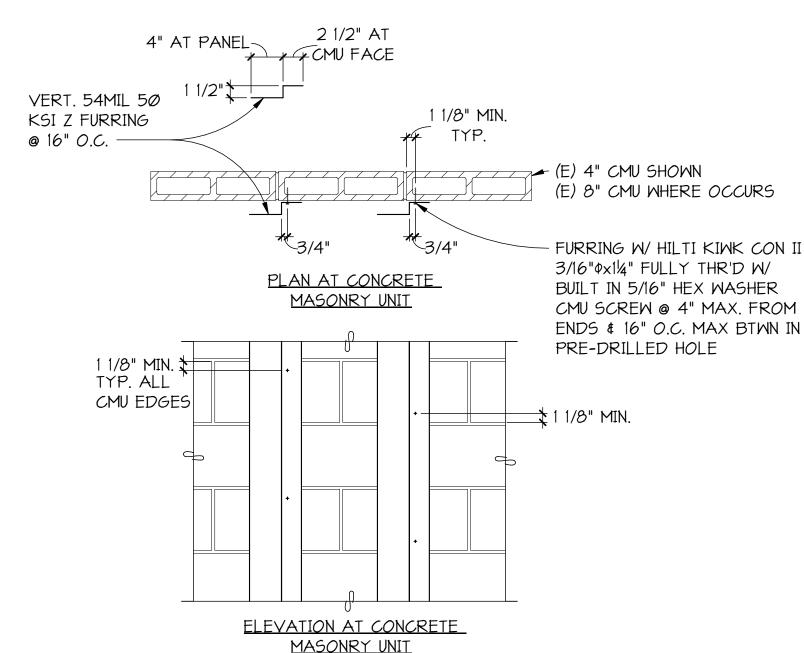

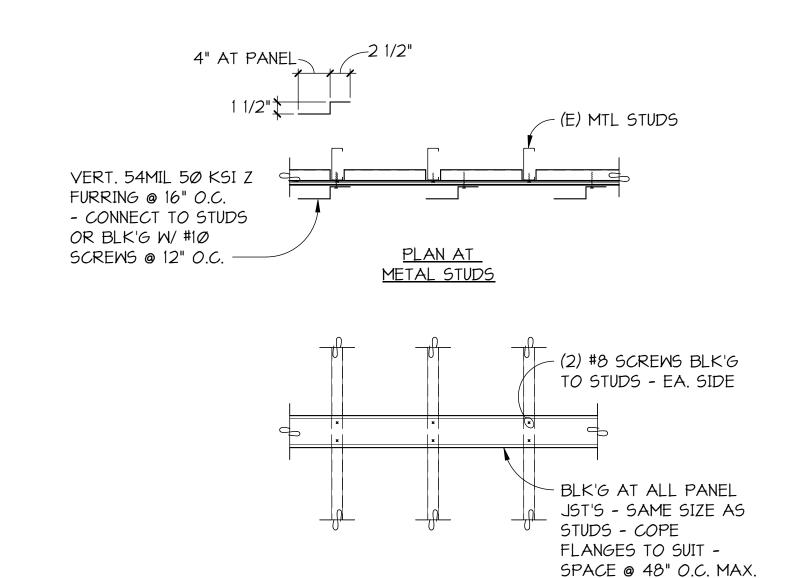


ELEVATION AT METAL STUDS

MASONRY UNIT

TYPICAL 1/5" Z FURRING - FOR LOCATION SEE ARCHITECT



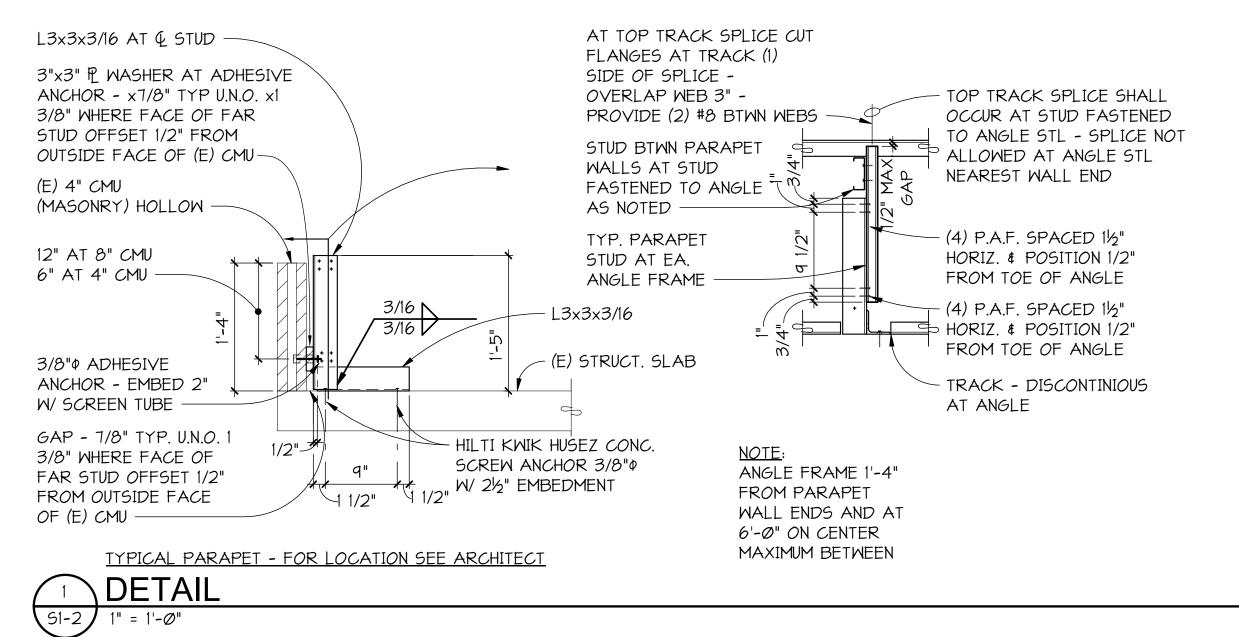

- SPLICE SHALL OCCURED

AS SPECIFIED THIS DETAIL

#8 EA. LEG TO EA. STUD

- 7/8" GAP TYP. U.N.O. 1%" GAP

WHERE FACE OF FAR STUD


OFFSET 1/2" FROM (E) CMU

TRACK LEG NEAREST (E) CMU

CONT. 400T125-33 W/ P.A.F. @ 16" O.C. TO

(E) STRUCT. SLAB W/ #8 SCREW EA. LEG TO STUD - PROVIDE 3/8" LONG SCREW AT

CONT. 400T125-33 W/

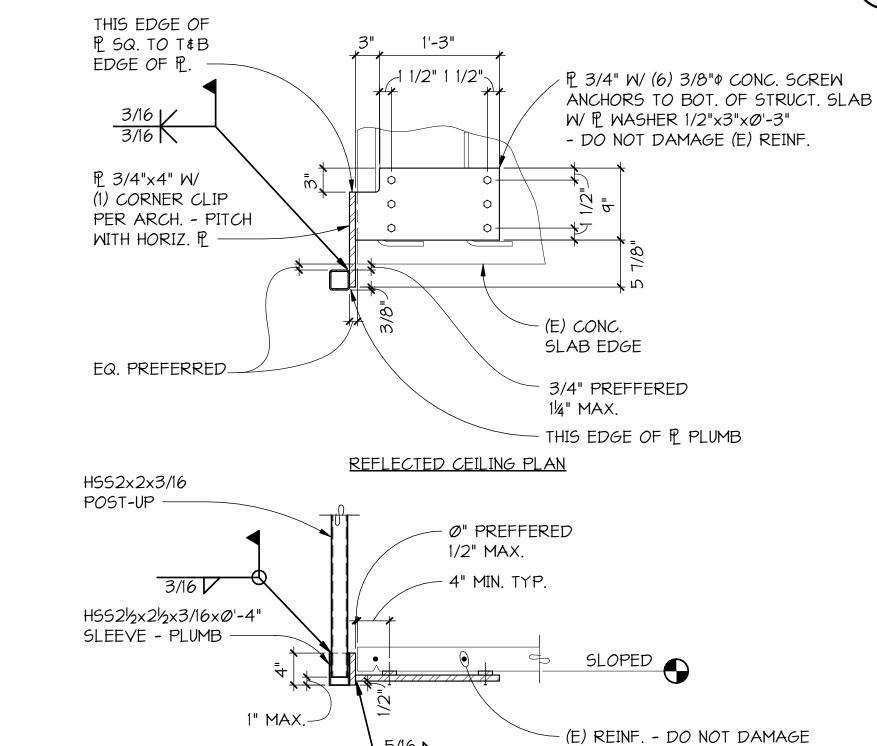


- DETERMINE LOC. THROUGH

NON-DISTRUCTIVE MEANS

PRODUCTION

PRIOR TO SHOP DRAWING

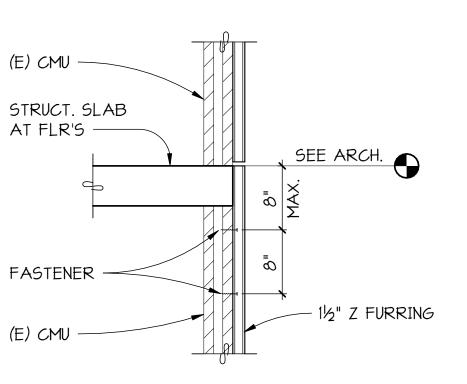



1/2" PW. SHT'G - FACE

WALLS - W/ (2) ROWS #8

@ 16" - OFFSET SCREWS

33 MILx3½"xØ'-5" @ 48" O.C. MAX. W/ (2) KWIK CON

CMU & (3) #8 TO BOT.

PW. SHIM AT P

4005137-33 BTWN

PARAPET WALLS AT

STUD FASTENED TO

II 3/16"0x14" FULLY THR'D W/

CMU SCREW @ 3" O.C. TO (E)

BUILT IN 5/16" HEX WASHER

TRACK - WHERE FACE OF

STUD OFFSET 1/2" FROM

FACE OF CMU PROVIDE 1/2"


ANGLE W/ (3) #8 EA. END -

GRAIN PERP. TO

BTWN ROWS 8"

4005137-33 @


16" O.C. MAX. -

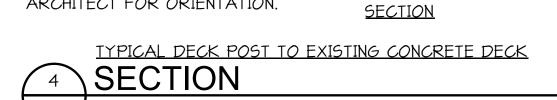

NOTE: CONDITION AT DECK FAR EDGE

SHOWN - CONDITION AT FACE

OF BUILDING SIMILAR - SEE ARCHITECT FOR ORIENTATION.

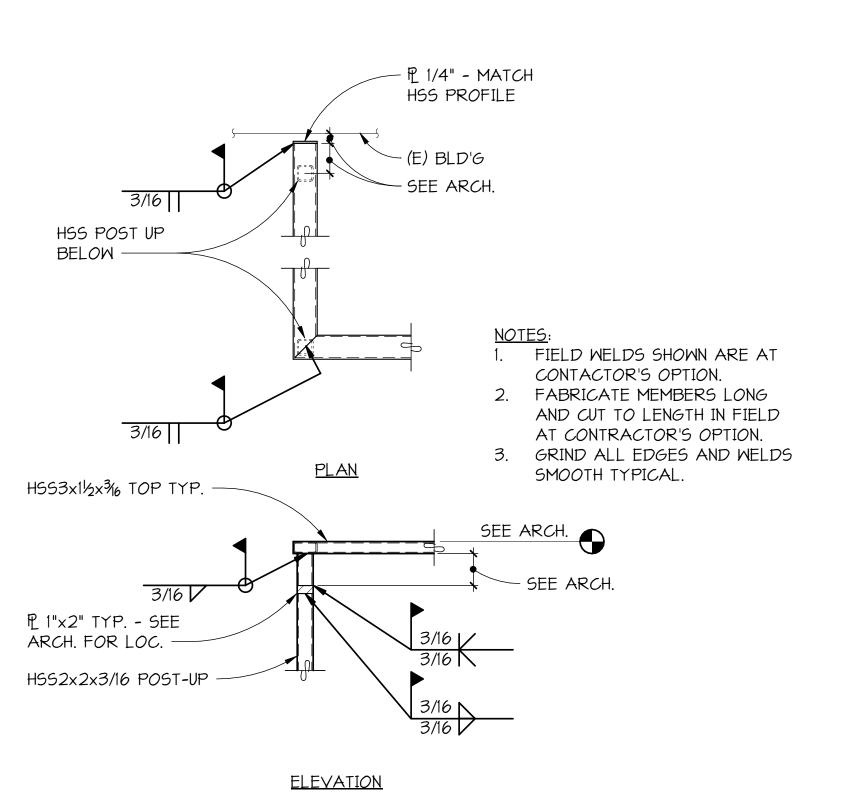

DETAIL

OWNER... King County **Housing**

LAWHEAD

ARCHITECTS

P.S.

BELLEVUE, WA 98005

RE...

23-10

DATE... 8/13/24

SHEET TITLE... Details

SHEET NO...

- NOTES: 1. ROOF ANCHOR, WALL ANCHOR & GUY BRACING TO BE CONTRACTOR DESIGNED TO WITHSTAND EXPECTED FORCES ON FLUE PER CODE. DESIGN SHOWN IS CONCEPTUAL ONLY.
 - 2. SUBMIT SHOP DRAWINGS W/ WA STATE ENGINEERS STAMP W/ PRODUCT INFORMATION, ANCHOR DETAILS, & BRACING DETAILS.
 - 3. VERIFY (E) ROOF DECK THICKNESS & ANY (E) REINFORCEMENT.




MECHANICAL GENERAL NOTES

- CONTRACTOR SHALL CAREFULLY COORDINATE WORK W/ ALL OTHER TRADES. SEE ELECTRICAL DRAWINGS FOR DISCONNECTING POWER TO ITEMS. SEE ARCHITECTURAL DRAWINGS FOR ALL ROOF FLASHING & DETAILS.
- DRAWINGS SCALES APPLY TO FULL SIZE SHEET ONLY. USE CAUTION IN OBTAINING DIMENSIONS AND QUANTITIES FROM DRAWINGS THAT ARE NOT FULL SIZE; USE DIMENSIONS CALCULATED FROM DIMENSIONS ON THE ARCHITECTURAL AND STRUCTURAL DRAWINGS OVER OTHER METHODS OF OBTAINING DIMENSIONS
- FURNISH AND INSTALL ALL MATERIALS, APPURTENANCES, DEVICES, AND MISCELLANEOUS ITEMS NOT SPECIFICALLY MENTIONED HEREIN OR NOTED ON THE DRAWINGS, BUT WHICH ARE NECESSARY TO MAKE A COMPLETE WORKING INSTALLATION OF ALL MECHANICAL SYSTEMS. NOT ALL ACCESSORIES OR DEVICES ARE SHOWN OR SPECIFIED THAT ARE NECESSARY TO FORM COMPLETE AND FUNCTIONAL SYSTEMS.
- THE LEVEL OF DESIGN AND INFORMATION PRESENTED IN THE DOCUMENTS REPRESENTS THE EXTENT OF THE DESIGN BEING FURNISHED TO THE CONTRACTOR; ALL ADDITIONAL DESIGN NEEDED SHALL BE PROVIDED BY THE CONTRACTOR. ALL DESIGN BY THE CONTRACTOR SHALL BE PERFORMED BY INDIVIDUALS SKILLED AND EXPERIENCED IN SUCH WORK, AND WHERE REQUIRED BY LOCAL CODE (OR ELSEWHERE IN THE DOCUMENTS) SHALL BE PERFORMED BY ENGINEERS LICENSED IN THE STATE WHERE THE PROJECT IS LOCATED. INCLUDE IN BID THE COSTS OF ALL SUCH PROJECT DESIGN; INCLUDING ENGINEERING, DRAFTING, FIELD INVESTIGATION, COORDINATION, AND ALL RELATED ACTIVITIES AND WORK.
- 5. VISIT THE SITE PRIOR TO BIDDING OR STARTING CONSTRUCTION TO VERIFY EXISTING CONDITIONS, EXISTING MATERIALS OF CONSTRUCTION, & ITEMS RELATED TO THE WORK.
- 6. ALL WORK SHALL COMPLY WITH CODE & BEST CONSTRUCTION PRACTICES.
- PROVIDE SUBMITTALS ON PROPOSED NEW MATERIALS. ALL ITEMS ARE NEW UNLESS NOTED AS EXISTING.
- PROVIDE ALL PRESSURE TESTS OF SYSTEMS WHERE ITEMS HAVE BEEN DISCONNECTED/RECONNECTED. PROVIDE SUCH TESTS AS REQ'D BY THE AHJ.
- SEAL ALL BLDG PENETRATIONS AT AREAS OF WORK TO PREVENT ENTRY OF WATER.
- 10. COORDINATE DOWNTIME OF ALL SYSTEMS WITH OWNER. SEE DOCUMENTS FOR RESTRICTIONS & NOTIFICATIONS. PROVIDE TEMPORARY CAP-OFFS TO MINIMIZE DOWNTIME AND TO ALLOW SYSTEMS TO BE PLACED BACK IN SERVICE AS SOON AS POSSIBLE WHILE GENERAL BUILDING WORK IS BEING PERFORMED.
- 11. PROVIDE ALL CUTTING & PATCHING AS REQ'D TO PERFORM THE WORK.
- 12. ANCHORING DESIGN & ATTACHMENT OF FLUE BRACING TO ROOF IS CONTRACTOR DESIGN/BUILD. RETAIN PROFESSIONAL ENGINEER TO DESIGN ANCHORS & SELECT FASTENERS. SEE NOTES ON DETAIL 1/M0-1.

GENERAL DEMOLITION NOTES

- DEMOLITION DRAWINGS ARE INTENDED TO ONLY GIVE A GENERAL REPRESENTATION OF THE DEMOLITION INVOLVED, AND DO NOT CONSTITUTE A FULL LISTING OF ALL ITEMS REQUIRING REMOVAL. VERIFY W/ OWNER EXTENT OF UNUSED ITEMS IN ATTIC TO BE DEMO'D.
- 2. IT IS THE CONTRACTOR'S RESPONSIBILITY TO REVIEW SITE CONDITIONS AND TO IDENTIFY ALL DEMOLITION WORK, AND INCLUDE IN HIS BID ALL COSTS FOR DEMOLITION & DISPOSAL
- PROVIDE TEMPORARY CAP-OFF OF ALL EXIST. SYSTEMS TO ALLOW CONTINUED BUILDING OCCUPANCY AND PROTECT FROM ENTRY OF DEBRIS UNTIL THE FINAL SYSTEM COMPONENTS ARE INSTALLED AND CONNECTED (I.E. ROOFTOP DUCTS, VENTS, ETC.)
- VERIFY SIZE & LOCATION OF ALL EXISTING ITEMS SHOWN TO BE DEMO'D. LOCATIONS SHOWN ARE
- THE MAJORITY OF (E) MECHANICAL ITEMS ARE TO BE SALVAGED. CAREFULLY REMOVE & PROPERLY STORE ITEMS UNTIL TIME FOR REINSTALLATION.

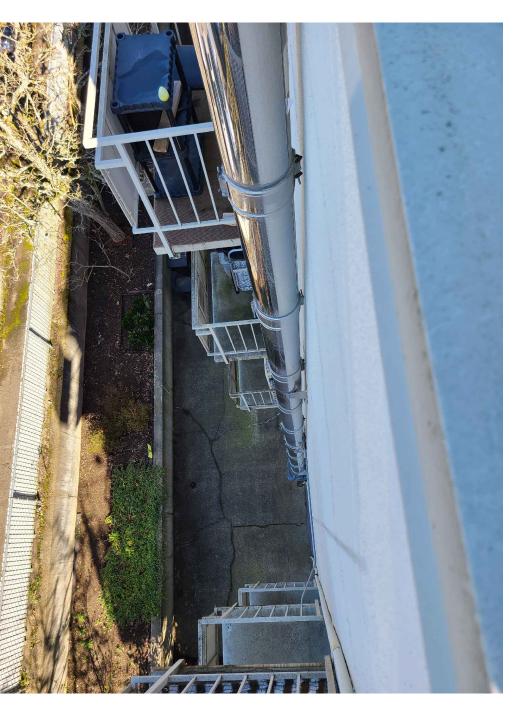




	MECHANICAL LEGEN	ND	
SYMBOL	DESCRIPTION	SYMBOL	DESCRIPTION
→ ○ → ○ → ○ ← A → ○ ←	PIPE UP PIPE DOWN DUCTWORK DOWN DUCTWORK UP ROOFTOP FAN PLUMBING VENT PHOTOGRAPH IDENTIFIER	AHJ APPROX ARCH BLDG DIA, Ø DN DWG EA ELEC (E), EXIST (ETR) EXH GC IMC MFR MAX MECH MIN NO. NTS REF REQ'D SS TYP UNO UPC	AUTHORITY HAVING JURISDICTION APPROXIMATELY ARCHITECTURAL BUILDING DIAMETER DOWN DRAWING EACH ELECTRICAL, ELECTRIC EXISTING EXISTING TO REMAIN EXHAUST GENERAL CONTRACTOR INTERNATIONAL MECHANICAL CODE MANUFACTURER MAXIMUM MECHANICAL MINIMUM NUMBER NOT TO SCALE REFERENCE REQUIRED STAINLESS STEEL TYPICAL UNLESS NOTED OTHERWISE
		W/ WA	UNIFORM PLUMBING CODE VOLTS, VOLTAGE WITH WASHINGTON

MATERIAL NOTES

- ALL MATERIALS AND WORK SHALL COMPLY W/ CODE & BEST CONSTRUCTION PRACTICES. MATERIALS SHALL MATCH & BE CONSISTENT WITH EXISTING & NEW WORK.
- ALL FASTENERS, GUIDES, SUPPORTS, ANCHORS, ETC. EXPOSED TO THE OUTDOORS SHALL BE CORROSION RESISTANT (I.E. GALVANIZED, CADMIUM PLATED, OR STAINLESS
- 3. PLUMBING VENT PIPING SHALL BE NO-HUB CAST IRON; COMPLYING WITH UPC.
- DUCTWORK SHALL BE GALVANIZED STEEL, G90 LOCK-FORMING GRADE, CONSTRUCTED PER IMC AND SMACNA STANDARDS.
- FLUE SHALL BE DOUBLE WALL STAINLESS STEEL TYPE, SUITABLE FOR CONDENSING BOILERS. PROVIDE W/ BOTTOM DRAIN. UL 1738 LISTED, CATEGORY IV. INNER PIPE CONSTRUCTED OF AL29-4C SS, OUTER PIPE OF TYPE 430 SS. PROVIDE WITH ALL FITTINGS, CAPS, EXPANSION JOINTS, SUPPORTS, SEALANTS, APPLIANCE CONNECTOR & ACCESSORIES. METAL FAB "CORR/GUARD II" (OR EQUAL).
- NEW HOSE BIBB TO BE: MANUFACTURER: PRIER; MODEL: P-164/264 SERIES FREEZELESS WALL HYDRANT.
- GAS PIPING TO BE SCHEDULE 40 BLACK STEEL W/ 150 LB MALLEABLE FITTINGS, THREADED OR WELDED.
- FIRE SPRINKLER PIPING TO BE STEEL, PER NFPA 13 & LOCAL AHJ REQUIREMENTS. SPRINKLER HEADS TO MATCH EXISTING.
- 9. FLUE DRAIN PIPE SHALL BE SCHEDULE 40 CPVC WITH SOLVENT JOINTS.

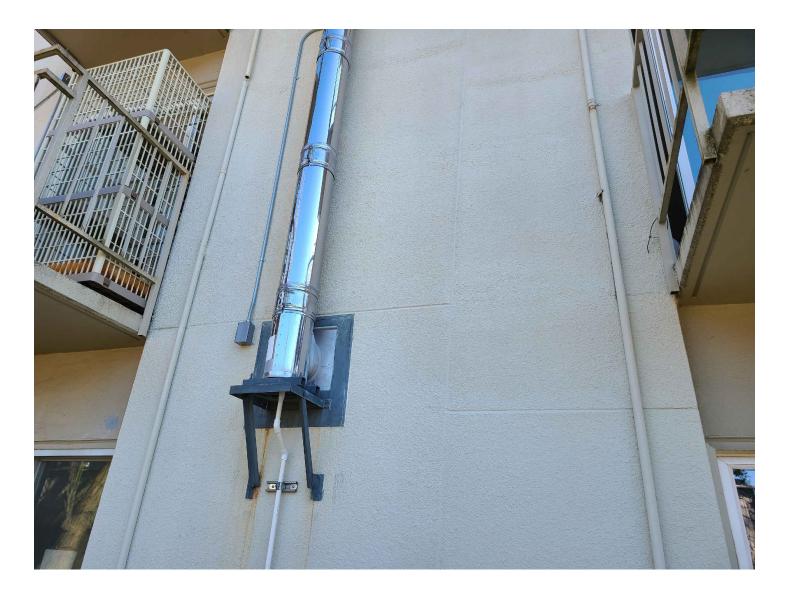

EXISTING FLUE



1111 Fawcett Ave Suite 100 Tacoma, WA 98402 Phone: (253) 383-3257 Fax: (253) 383-3283







Bid Set

JOB NO...

23-10

8/13/24

SHEET TITLE...


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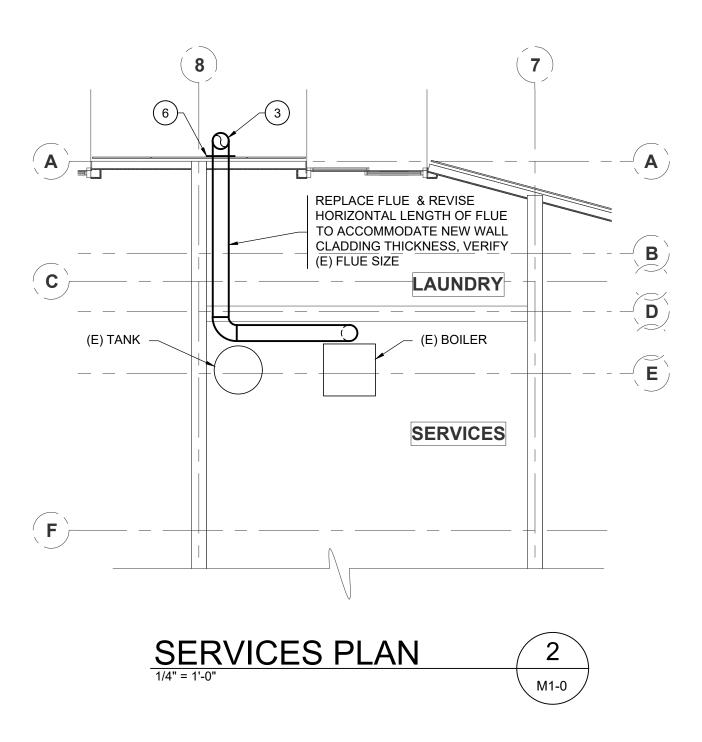
Mechanical Legend and Notes

M0-1



EXISTING AC CONDENSER



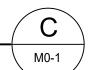


GENERAL NOTES:

- 1. SEE MECHANICAL GENERAL NOTES & DEMOLITION NOTES SHEET M0-1.
- 2. AS-BUILTS ARE NOT AVAILABLE; CONTRACTOR TO FIELD VERIFY ALL EXISTING CONDITIONS & SIZES/ LOCATIONS OF ALL ITEMS.

KEYED NOTES:

- 1) REMOVE EXISTING ITEM TO ALLOW FOR WALL DEMO/ CONSTRUCTION. REVISE EXISTING PIPING (OR DUCTWORK) & CONNECTING ACCESSORIES TO SUIT NEW WALL THICKNESS AND REINSTALL ITEM (UNO). PROVIDE TEMPORARY CAP OFF AS REQUIRED TO ALLOW OTHER PORTIONS OF SYSTEM TO REMAIN IN OPERATION.
- 2 REMOVE EXISTING HOSE BIBB AND PROVIDE TEMPORARY CAP. REVISE CW ROUGH-IN AND INSTALL NEW FREEZE-PROOF HOSE BIBB.
- (3) REMOVE EXISTING FLUE TO ALLOW FOR WALL DEMO/ CONSTRUCTION. INSTALL NEW FLUE ONCE WALL WORK IS COMPLETE. WORK REQUIRES TALLER FLUE & REVISED LOCATION OFF WALL DUE TO NEW WALL CLADDING. ANCHOR IN SIMILAR FASHION AS EXISTING W/ PRESSURE TREATED WOOD BLOCKING AT WALL ANCHORAGE TO ACCOUNT FOR THICKER EXTERIOR WALL SYSTEM. PROVIDE 3/4" DRAIN PIPE & ANCHORS, ROUTE DOWN TO EXISTING DRAIN AT GRADE. MINIMIZE SYSTEM DOWNTIME.
- (4) PROVIDE TEMPORARY FLUE EXTENSION HORIZONTALLY 10' ABOVE GRADE. PROVIDE BIDDER DESIGNED WELDED STEEL SUPPORTS. FLUE SERVES GAS FIRED BOILER FOR BUILDING HOT WATER. PROVIDE BOILER REPRESENTATIVE TO ADJUST BOILER OPERATION W/ TEMPORARY FLUE & AGAIN ONCE FINAL FLUE IS INSTALLED. PROVIDE WRITTEN REPORT. EXISTING BOILER IS AERCO INNOVATION 600. EXISTING FLUE IS 8"Ø (FIELD VERIFY SIZE) DOUBLE WALL SS TYPE.
- (5) PROVIDE NEW DRYER VENT WALL CAPS.
- (6) REMOVE (E) WALL BRACKET & CLOSURE PANEL AT BASE OF FLUE (& FLUE PER KEYED NOTE 3). EXTEND BRACKET/OFF WALL TO ACCOUNT FOR REVISED WALL THICKNESS; PROVIDE PT WOOD BACKING AT LOWER WALL SUPPORT SIMILAR TO DETAIL 1/M0-1. PROVIDE NEW BRACKETS SIMILAR TO EXISTING TYPE (SEE PHOTO A/M0-1); FOR USE W/ NEW FLUE.

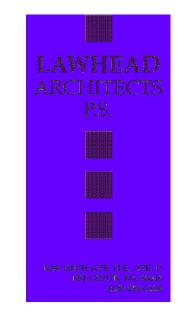





King County WESTMIN

Bid Set

JOB NO... 23-10


DATE...

8/13/24

SHEET TITLE... First Floor Plan -Mechanical


SHEET NO...

M1-0

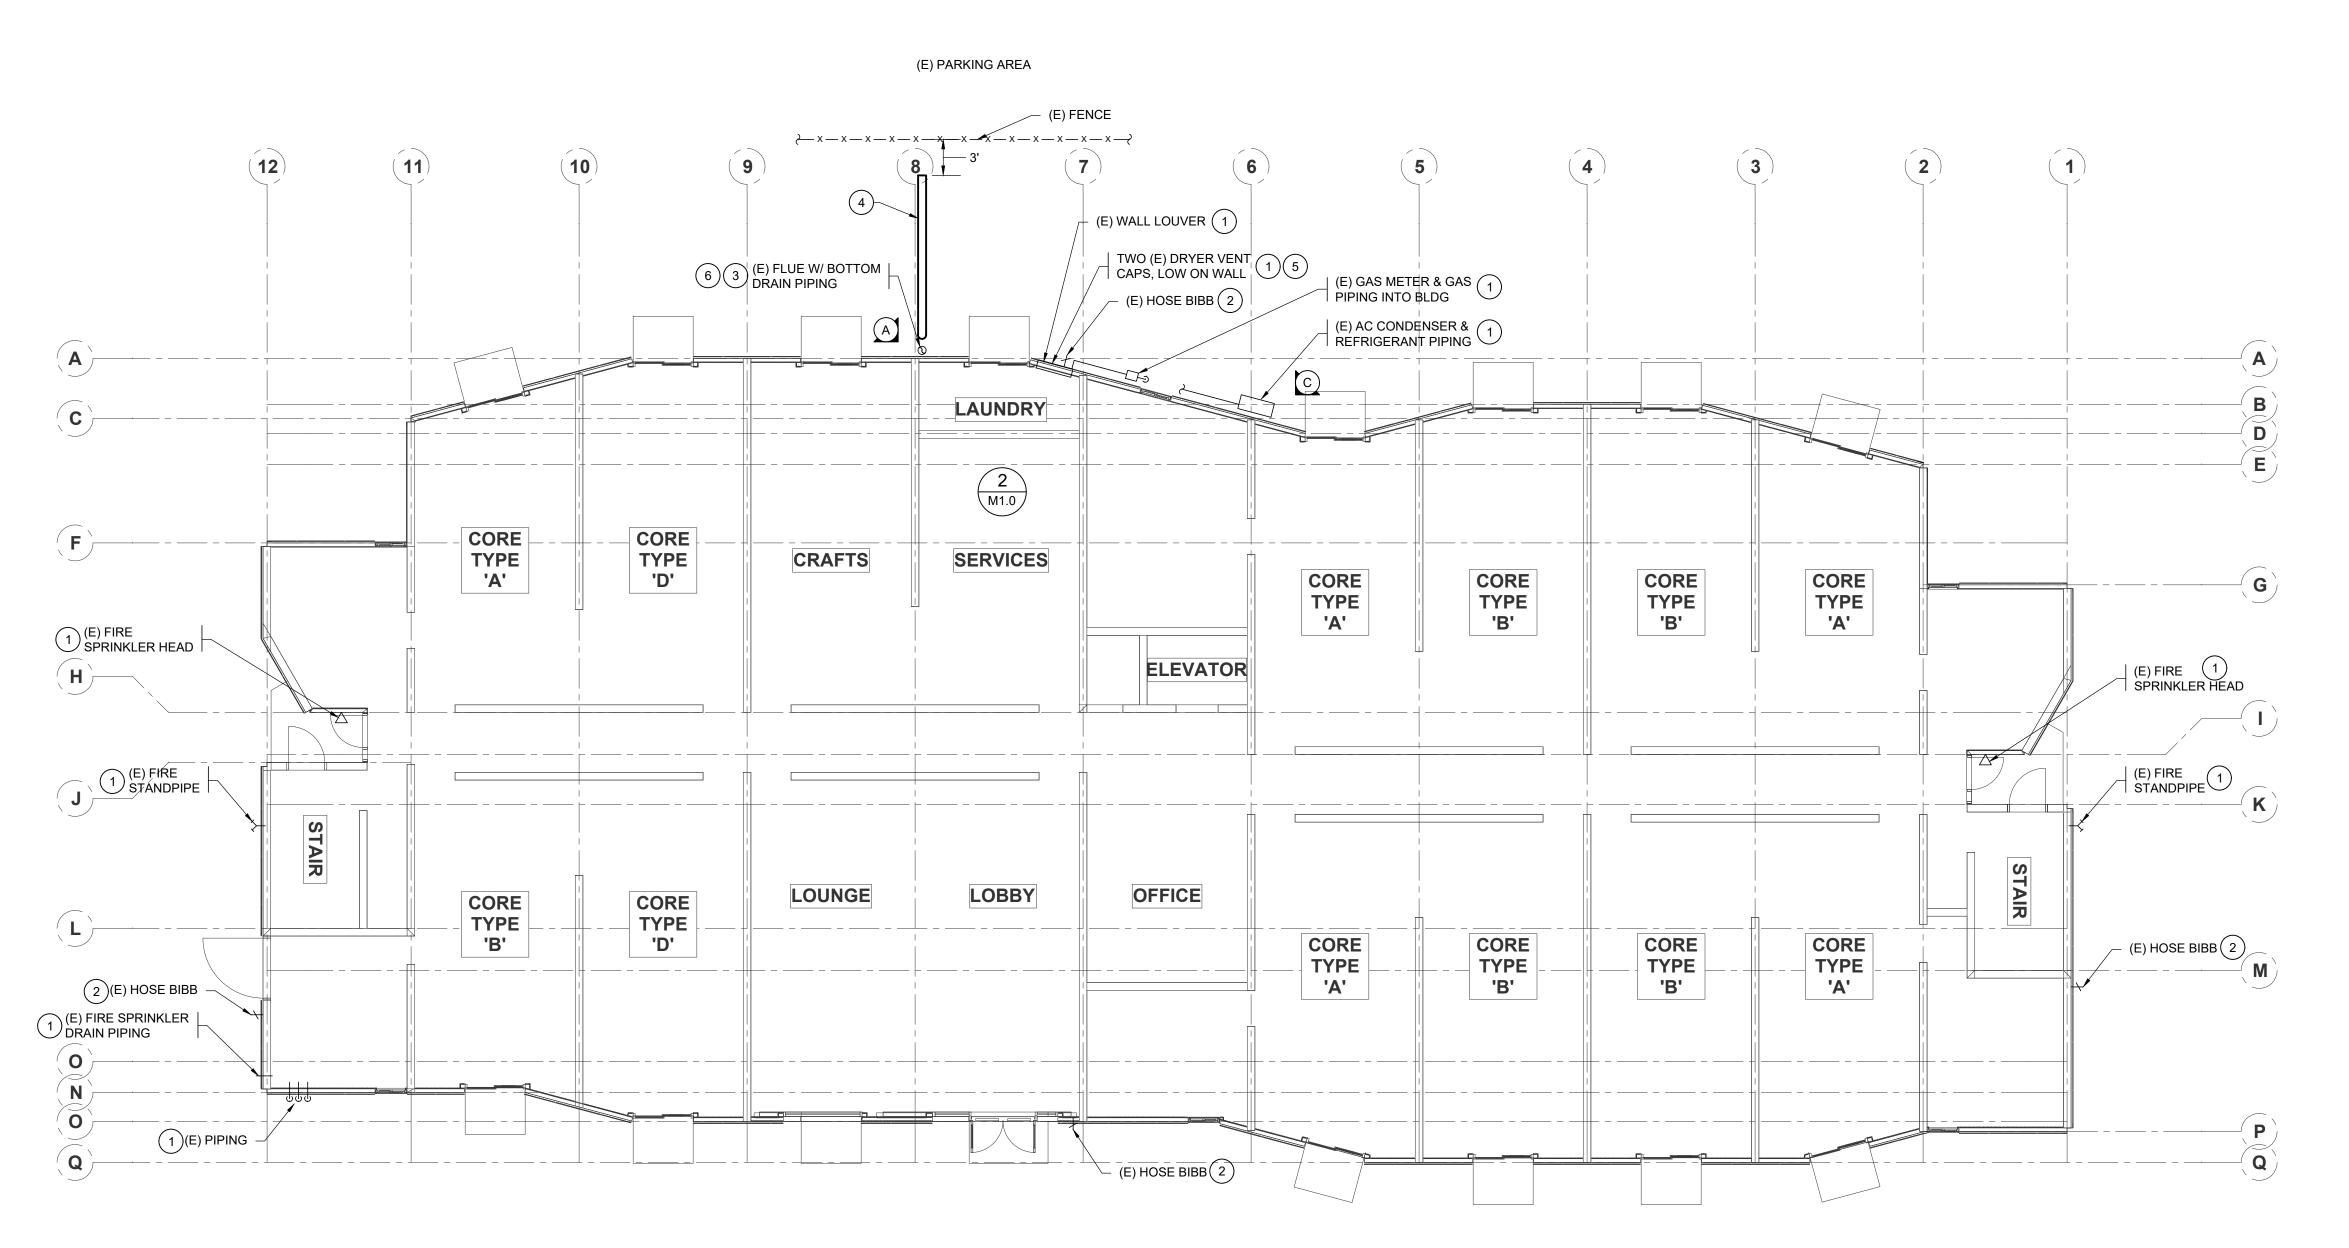

GENERAL NOTES:

- 1. SEE MECHANICAL GENERAL NOTES & DEMOLITION NOTES SHEET M0-1.
- AS-BUILTS ARE NOT AVAILABLE; CONTRACTOR TO FIELD VERIFY ALL EXISTING CONDITIONS.
- 3. EXTEND (E) PLUMBING VENTS TO TERMINATE MIN 8" ABOVE ROOF. FIELD VERIFY SIZE & LOCATION; ASSUME ALL ARE 4" VENTS (UNO) FOR BIDDING
- 4. REMOVE ALL EXISTING ROOF FANS, ROOF HOODS, AND CURB ADAPTERS TO ALLOW FOR ROOF WORK. REINSTALL ITEMS ON NEW CURBS AT REVISED HEIGHT. DISCONNECT/RECONNECT CONTROLS. EXTEND (E) DUCTWORK AS REQUIRED. SEE ELECTRICAL DRAWINGS FOR POWER DISCONNECT/RECONNECT.

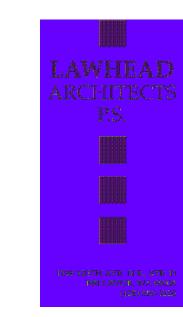





King County Housing Authority WESTMINSTER MANOR Envelope & Roof Project

PHASE...

Bid Set

JOB NO...

23-10


DATE...
8/13/24

SHEET TITLE...

Roof Plan -Mechanical

SHEET NO...

M2-0

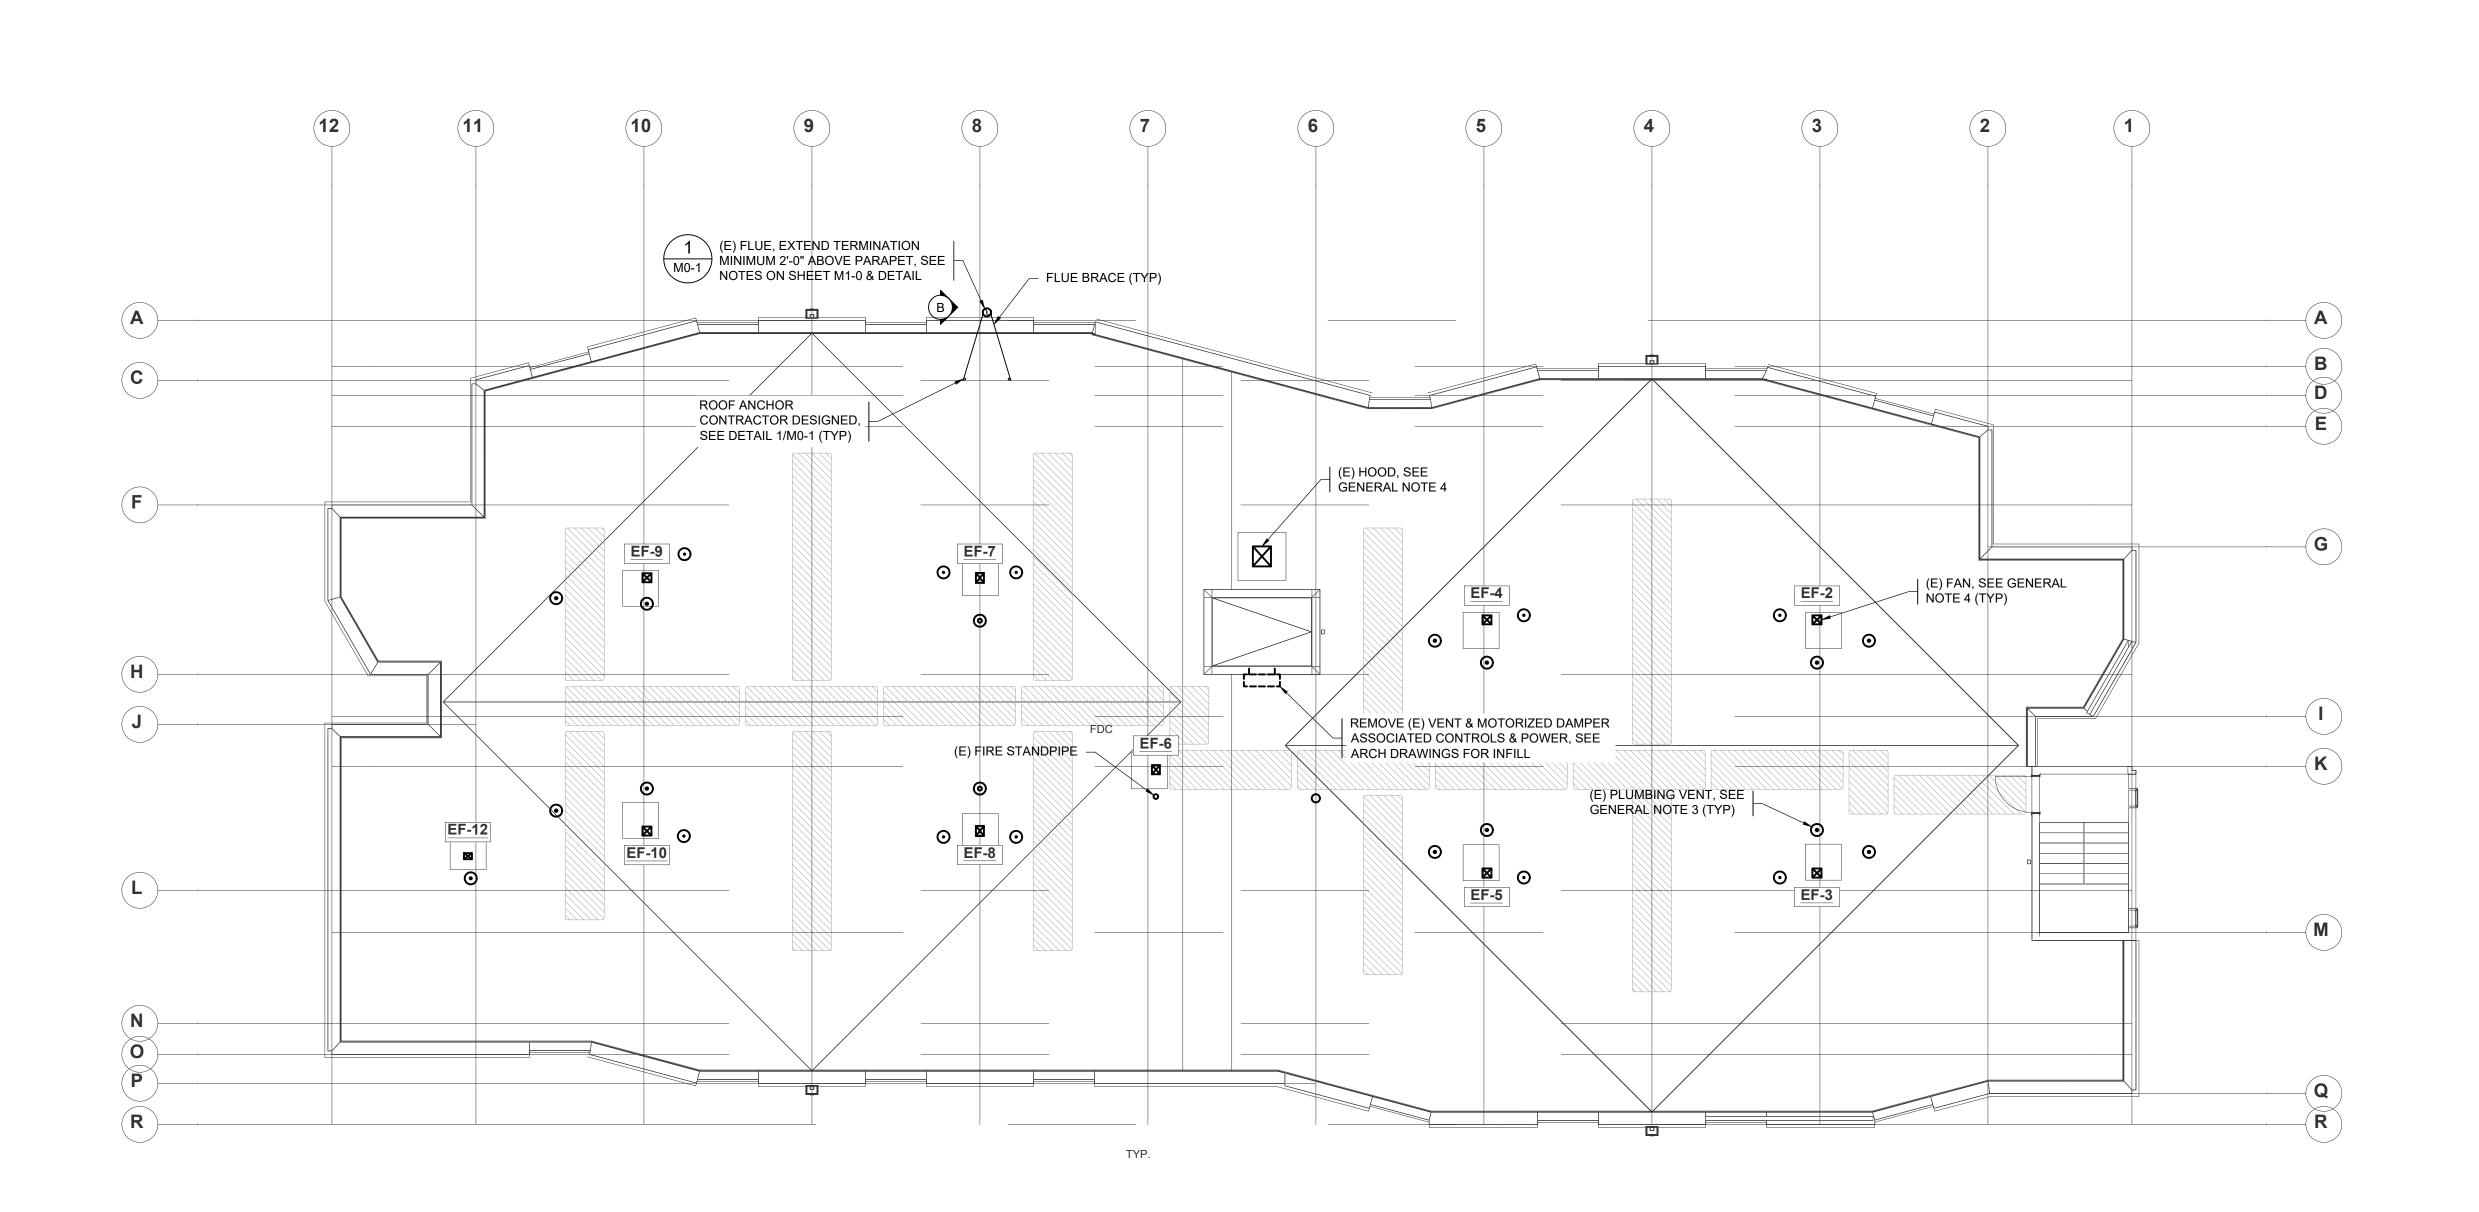

ABBREVIATIONS						
	(SOME ABBREVIATIONS MAY NOT BE USED ON DRAWINGS)					
ABBREVIATION	DESCRIPTION	ABBREVIATION	DESCRIPTION			
A or AMP	AMPERES	MAX	MAXIMUM			
AC	ALTERNATING CURRENT	MCA	MINIMUM CIRCUIT AMPS			
A/C	AIR CONDITIONING	MCB	MAIN CIRCUIT BREAKER			
AIC	AMPERE INTERRUPTING CAPACITY	MCC	MOTOR CONTROL CENTER			
AL	ALUMINUM	MCM, KCM	THOUSAND CIRCULAR MILS			
ARCH	ARCHITECTURAL	MDF	MAIN DISTRIBUTION FRAME			
ATS	AUTOMATIC TRANSFER SWITCH	MECH	MECHANICAL MINIMUM			
AWG BKR	AMERICAN WIRE GAUGE BREAKER	MIN MLO	MAIN LUGS ONLY			
		MOP, MOCP	MAXIMUM OVERCURRENT PROTECTION			
BLDG	BUILDING					
C	CONDUIT	NIC	NOT IN CONTRACT			
C.O.	CONDUIT ONLY	NTS	NOT TO SCALE			
CB	CIRCUIT BREAKER	OC	ON CENTER			
CCTV	CLOSED CIRCUIT TELEVISION	PA	PUBLIC ADDRESS			
CFM	CUBIC FEET PER MINUTE	PB	PULLBOX			
CKT	CIRCUIT	Ø or PH	PHASE			
CL	CENTER LINE	PNL	PANEL			
CLG	CEILING	PR	PAIR			
CONC	CONCRETE	PRI	PRIMARY			
CT	CURRENT TRANSFORMER	PVC	POLYVINYL CHLORIDE			
CU	COPPER	RECPT	RECEPTACLE			
CW	COLD WATER	REQ	REQUIRED			
DC	DIRECT CURRENT	RM	ROOM			
DIA	DIAMETER	SHT	SHEET			
DIV	DIVISION	SP	SINGLE POLE			
DPDT	DOUBLE POLE, DOUBLE THROW	SPD	SURGE PROTECTIVE DEVICE			
DPST	DOUBLE POLE, SINGLE THROW	SPDT	SINGLE POLE, DOUBLE THROW			
DWG	DRAWING	SPST	SINGLE POLE, SINGLE THROW			
EGC	EQUIPMENT GROUND CONDUCTOR	SW	SWITCH			
ELEC	ELECTRIC	SWBD	SWITCHBOARD			
EMT	ELECTRICAL METALLIC TUBING	TEL	TELEPHONE			
E.T.R.	EXISTING TO REMAIN	TV	TELEVISION			
EXST, (E)	EXISTING	ТТВ	TELECOMMUNICATIONS TERMINAL BOARD			
EV	ELECTRIC VEHICLE	TYP	TYPICAL			
FA	FIRE ALARM	UL	UNDERWRITERS LABORATORY			
FC	FOOTCANDLE	UF	UNDERFLOOR			
FLA	FULL LOAD AMPS	UG	UNDERGROUND			
GFCI	GROUND FAULT CIRCUIT INTERRUPTER	V	VOLTS			
GND	GROUND	VA	VOLT AMPERES			
HP	HORSEPOWER	VAC	VOLTS ALTERNATING CURRENT			
IDF	INTERMEDIATE DISTRIBUTION FRAME	VAC	REACTIVE VOLT AMPERES			
J-BOX	JUNCTION BOX	W	WATTS			
		WP	WEATHERPROOF			
KV KV	KILOVOLT AMPERES					
KVA	KILOVOLT AMPERES	/W	WITH			
KW	KILOWATTS	W/O	WITHOUT			
LTO	LIGHT	XFER	TRANSFER			
LTG	LIGHTING	XFMR	TRANSFORMER			

OUTLET MOUNTING HEIGHTS				
(ME	ASURE TO CENTER OF BOX, UNLESS OTH	HERWISE INDICATED)		
(=	7,001,2 10 02,11,21, 01 20,1, 01,2200 011			
COUNTER HEIGHT (*)	+3 INCHES ABOVE SPLASH	FIRE ALARM		
CASEWORK OUTLETS	AS DIRECTED	MANUAL STATIONS	48 INCHES TO TOP	
SWITCHES AND DIMMERS	48 INCHES	SIGNALING DEVICES	80 INCHES TO BOTTOM	
RECEPTACLES	18 INCHES	REMOTE ALARM LIGHTS	80 INCHES TO BOTTOM	
THERMOSTATS	48 INCHES	REMOTE ANNUNCIATOR	60 INCHES TO BOTTOM	
OCCUPANCY SENSORS	12 FEET MAXIMUM	GRAPHIC PLAQUES	60 INCHES TO BOTTOM	
DATA (COMPUTER)	18 INCHES	SECURITY		
WALL PHONE	48 INCHES	KEY PAD	48 INCHES TO TOP	
TV (TELEVISION)	18 INCHES	CARD READER	48 INCHES	
TV WALL MOUNTED	CENTER OF TV BRACKET	CCTV	WITHIN 6 INCHES OF	
SPEAKERS	90 INCHES		CAMERA MOUNT	
CLOCKS	90 INCHES	CCTV POLE MOUNTED	16 FEET	
CLOCK/SPEAKER	90 INCHES, GYM OR COMMONS - 120"			
PROJECTOR	ABOVE WHITEBOARD, TO BE COORDINA	ATED		

SYMBOL DESCRIPTION SUBSCRIPTION DESCRIPTION DESCRIPTI	
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PANEEDRACE - SURFACE	
PANELORATO - EXISTING (SURFACE PANELS SHOWN)	
PRODUCT SWITCH FUSED DISCONNECT SWITCH	OUND
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W/OVERLOADS	٦.
MC MOMENTARY CONTACT FIRE ALARM	
P SWITCH W/PILOT LIGHT FAP FIRE ALARM CONTROL PANEL T TIMER	
WP WEATHERPROOF FAA FIRE ALARM ANNUNCIATOR	
a, b, c MULTIGANG SWITCH STATION F MANUAL STATION	
DAYLIGHT SENSOR - DUAL ZONE	VICE
OS OCCUPANCY SENSOR FAC CEILING MOUNT FIRE ALARM VISUAL AN	AND AUDIBLE DEV
(H) HEAT DETECTOR	
ETR UL924 EMERGENCY TRANSFER RELAY SMOKE DETECTOR	
LINE TYPES R RELAY	
———— EXISTING CONDITIONS NEW WORK FIRE ALARM SPRINKLER ALARM BELL	

NEW WORK

GENERAL ELECTRICAL NOTES:


- 1. SEE ARCHITECTURAL PLANS FOR LOCATION OF FIRE RATED CONSTRUCTION.
- 2. BRANCH CIRCUIT NOTES:
- A. VERIFY BRANCH CIRCUIT WIRE COUNT BEFORE PULLING CONDUCTORS. PROVIDE REQUIRED CONDUCTORS TO EACH OUTLET AND DEVICE FOR PHASE, NEUTRAL AND EQUIPMENT GROUND BASED ON CIRCUIT DESIGNATIONS SHOWN AND AS OTHERWISE INDICATED ON PLANS OR NOTE BELOW.
- B. FOR SWITCHED OUTLETS, PROVIDE ADDITIONAL CONDUCTOR COUNT REQUIRED FOR SWITCH LEGS TO ACCOMMODATE SWITCH CONTROL INDICATED. MAINTAIN UNSWITCHED LEG IN LIGHTING BRANCH CIRCUITS TO EXIT, EMERGENCY, AND NIGHT LIGHTING SHOWN.
- C. MINIMUM BRANCH CIRCUIT CONDUCTOR SIZE FOR OUTDOOR AND EXTERIOR BUILDING LIGHTING SHALL BE #10 AWG.
- D. PROVIDE SEPARATE NEUTRAL CONDUCTOR FOR BRANCH CIRCUITS SERVING RECEPTACLE OUTLETS UNLESS OTHERWISE INDICATED.
- 3. MINIMUM CONDUIT SIZE FOR HOMERUNS AND FOR CONDUIT INSTALLED BELOW GRADE OUTDOORS SHALL BE 3/4 INCH.
- 4. REFER TO ARCHITECTURAL PLANS FOR LIGHT FIXTURE LOCATIONS AND FOR MOUNTING HEIGHT OF SUSPENDED AND WALL MOUNTED LIGHT FIXTURES. REFER TO REFLECTED CEILING PLANS, INTERIOR ELEVATIONS, EXTERIOR ELEVATIONS, ROOM SECTIONS, AND DETAILS SHOWN ON ARCHITECTURAL CONTRACT DOCUMENTS PRIOR TO ROUGH-IN. REPORT CONFLICTS TO ARCHITECT/ENGINEER FOR RESOLUTION.
- 5. REFER TO ARCHITECTURAL ELEVATIONS FOR LOCATION AND MOUNTING HEIGHT OF WIRING DEVICES. REPORT CONFLICTS TO ARCHITECT/ENGINEER FOR RESOLUTION.
- 6. VERIFY EXACT LOCATION OF FLOOR BOXES AND OUTLETS LOCATED IN KNEE SPACES AND CASEWORK. OBTAIN ARCHITECT APPROVAL PRIOR TO ROUGH-IN.
- 7. VERIFY BACK BOX REQUIREMENTS OF EQUIPMENT FURNISHED UNDER OTHER THAN DIVISION 26, 27 OR 28 SECTIONS AND EQUIPMENT FURNISHED BY OWNER.
- 8. SEE MECHANICAL PLANS FOR QUANTITY AND LOCATION OF FIRE / SMOKE DAMPERS. PROVIDE 120 VOLT CONNECTION TO EACH DAMPER.

ENERGY CODE COMPLIANCE NOTES

- 1. MANUAL LIGHTING CONTROL: PROVIDE EACH ROOM WITH MANUAL LIGHTING CONTROL AS INDICATED. REMOTE LIGHTING CONTROLS SHALL IDENTIFY WHERE LIGHTS ARE CONTROLLED AND ON/OFF STATUS. MANUAL CONTROLS FOR SPACES NOT COVERED IN C405.2.1.2 LISTED EXCEPTIONS SHALL INCLUDE PROVISION FOR 50% LIGHT REDUCTION.
- 2. AUTOMATIC TIME SWITCH CONTROL: PROVIDE PROGRAMMABLE TIME SWITCH WITH MANUAL OVERRIDE FOR AUTOMATIC CONTROL OF LIGHTING IN ALL AREAS OF THE BUILDING NOT CONTROLLED BY OCCUPANCY SENSORS. TIME SWITCH AND OVERRIDE CONTROL SHALL COMPLY WITH MINIMUM REQUIREMENTS OF C405.2.2.1.
- 3. OCCUPANCY SENSORS: PROVIDE OCCUPANCY SENSORS IN ALL CLASSROOMS, CONFERENCE/MEETING ROOMS, LUNCH AND BREAK ROOMS, PRIVATE OFFICES, RESTROOMS, WAREHOUSE AND STORAGE SPACES, JANITORIAL CLOSETS, AND OTHER SPACES 300 SQUARE FEET OR LESS.
- 4. DAYLIGHT ZONES: PROVIDE AUTOMATIC CONTROL OF PRIMARY (DZ1) AND SECONDARY (DZ2) DAYLIGHT ZONES INDICATED ON PLANS INDEPENDENT OF MANUAL LIGHTING CONTROL ZONES INDICATED.
- 5. DAYLIGHT ZONE CONTROL: PROVIDE AUTOMATIC CONTINUOUS DIMMING CONTROL OF LIGHTS LOCATED WITHIN PRIMARY AND SECONDARY DAYLIGHT ZONES.
- 6. SPECIFIC APPLICATION CONTROLS: PROVIDE DEDICATED CONTROL INDEPENDENT OF OTHER LIGHTING FOR THE FOLLOWING:
 - A. MEANS OF EGRESS: PROVIDE AUTOMATIC CONTROL OF EGRESS LIGHTING BY MEANS OF OCCUPANCY SENSORS OR TIME CLOCK AS INDICATED. EMERGENCY LIGHTS TO HAVE UL924 RELAYS TO OVERRIDE CONTROL STATE UPON LOSS OF
- B. DISPLAY AND ACCENT LIGHTS: PROVIDE MANUAL CONTROL AS INDICATED.
- C. FIXED MOUNTED TASK LIGHTING: PROVIDE LIGHTS WITH INTEGRAL ON/OFF CONTROL AND CONTROL BY OCCUPANCY SENSOR IN SPACE.
- 7. EXTERIOR LIGHTING CONTROL: PROVIDE AUTOMATIC CONTROL OF EXTERIOR LIGHTING USING COMBINATION OF PHOTOCELL AND ENERGY MANAGEMENT SYSTEM, SEE SERVICE PLAN FOR ADDITIONAL INFORMATION.
- 8. ELECTRIC ENERGY METERING: PROVIDE END-USE METERING FOR HVAC AND WATER HEATING PER SECTION C409.
- 9. TRANSFORMERS: DRY TYPE DISTRIBUTION TRANSFORMERS RATED 600 VOLTS OR LESS SHALL COMPLY WITH MINIMUM EFFICIENCY REQUIREMENTS OF NEMA TP-1, TABLE
- 10. MOTORS SHALL COMPLY WITH EFFICIENCY REQUIREMENTS OF C405.8, SEE MECHANICAL DOCUMENTS FOR MOTOR EFFICIENCY DATA.
- 11. COMMISSIONING: PROVIDE PROGRAMMING, CALIBRATION, AND FUNCTIONAL PERFORMANCE TESTING OF AUTOMATIC LIGHTING CONTROL SYSTEMS TO INCLUDE OCCUPANCY SENSORS, DAYLIGHT CONTROLS, AND TIME SWITCHES PER APPROVED COMMISSIONING PLAN. SUBMIT COMPLETED COMMISSIONING COMPLIANCE CHECKLIST (C408.1.2.1) FOR SIGNATURE PRIOR TO FINAL INSPECTIONS BY MECHANICAL AND ELECTRICAL INSPECTION AUTHORITIES.

LAWHEAD ARCHITECTS

1239 120TH AVE. N.E., STE. D BELLEVUE, WA 98005 (425) 556-1220

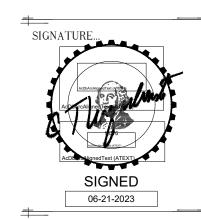

OWNER...



PHASE...

Bid Set

JOB NO... 23-10

DATE...

8/13/24

ABBREVIATIONS, LEGEND & GENERAL NOTES

SHEET NO...

Hultz BHU

engineers inc

1111 Fawcett Ave, Suite 100 Tacoma, WA 98402 Phone: (253) 383-3257 Fax: (253) 383-3283 general@hultzbhu.com Job Number: 22-043

SCOPE

- A. PROVIDE ALL LABOR, EQUIPMENT, MATERIAL, ACCESSORIES, AND TESTING FOR LIGHTING, POWER, AND SIGNAL SERVICE AND DISTRIBUTION, COMPLETE AND OPERATING, AS INDICATED AND SPECIFIED. ALL INDOOR WIRING AND CONDUIT PATHWAY FOR POWER, LIGHTING, AND SIGNAL SYSTEMS SHALL BE CONCEALED WITHIN BUILDING CONSTRUCTION (BELOW FLOOR SLAB OR IN ATTICS, CEILING SPACES, CRAWL SPACES, AND WITHIN WALL CONSTRUCTION) UNLESS OTHERWISE APPROVED BY ARCHITECT.
- B. OBTAIN AND REVIEW ALL PROJECT DOCUMENTS. PROVIDE POWER WIRING, DISCONNECT SWITCHES, AND ELECTRICAL CONNECTION OF EQUIPMENT IDENTIFIED IN THE PROJECT DOCUMENTS TO BE FURNISHED BY OTHER TRADES OR BY OWNER.
- C. CONTRACTORS BIDDING ELECTRICAL WORK SHALL VISIT THE BUILDING SITE PRIOR TO BIDDING AND BECOME FAMILIAR WITH THE EXISTING CONDITIONS AND ALL OTHER FACTORS WHICH MAY AFFECT THE EXECUTION OF THE WORK. INCLUDE ALL COSTS RELATED TO EXISTING SITE CONDITIONS IN THE BID PROPOSAL.
- D. MAINTAIN AT PROJECT SITE ONE SET OF CLEAN, DRY, AND LEGIBLE RED LINED RECORD DRAWINGS FOR SUBMITTAL AT CONTRACT CLOSE OUT. INDICATE ELECTRICAL CHANGES AND ELECTRICAL WORK ADDED OR OTHERWISE INSTALLED AND NOT SHOWN ON THE BID DOCUMENTS.
- SUBMITTALS
- A. OBTAIN WRITTEN APPROVAL FROM ARCHITECT/ENGINEER PRIOR TO ORDERING MATERIALS AND COMMENCING WORK.
- B. LIGHTING SYSTEMS: PROVIDE PRODUCT SUBMITTALS ON LIGHT FIXTURES, LAMPS, AND AUTOMATIC CONTROLS.
- C. POWER SYSTEMS: PROVIDE PRODUCT SUBMITTALS ON WIRING DEVICES.
- D. SIGNAL SYSTEMS: PROVIDE PRODUCT SUBMITTALS ON WIRE AND CABLE AND ALL EQUIPMENT, COMPONENTS, AND DEVICES BEING FURNISHED FOR EACH SIGNAL SYSTEM. SUBMIT FIRE ALARM SHOP DRAWINGS.
- DEFINITIONS
- A. FURNISH: OBTAIN AND/OR PREPARE AND DELIVER TO THE PROJECT.
- B. INDICATED: SHOWN, SCHEDULED, NOTED, OR OTHERWISE CALLED OUT ON THE DRAWINGS.
- C. INSTALL: ENTER PERMANENTLY INTO THE PROJECT COMPLETE AND READY FOR SERVICE.
- D. PROVIDE: FURNISH AND INSTALL COMPLETE AND READY FOR SERVICE.
- E. EQUIPMENT CONNECTION: MAKE BRANCH CIRCUIT CONNECTION, MOUNT AND CONNECT CONTROL DEVICES AS REQUIRED. PROVIDE DISCONNECT AND OVERCURRENT PROTECTION WHEN REQUIRED BY NEC AND UMC, IF NOT OTHERWISE INDICATED OR FURNISHED WITH EQUIPMENT.
- F. WIRING: CONDUCTORS IN RACEWAY OR AN APPROVED CABLE ASSEMBLY.
- G. PANEL: DISTRIBUTION PANELBOARD, LIGHTING & APPLIANCE PANELBOARD, OR LOADCENTER.
- 4. EXISTING CONDITIONS
- A. CUTTING AND PATCHING: PROVIDE CUTTING AND PATCHING REQUIRED FOR ELECTRICAL WORK AND TO PROVIDE OPENINGS IN FOR ELECTRICAL PENETRATIONS. LOCATE AND EXECUTE CUTS SO AS NOT TO DAMAGE OTHER WORK OR WEAKEN STRUCTURAL COMPONENTS. CORE DRILL OR SAW CUT RIGID MATERIALS. PATCH AND RESTORE TO ORIGINAL CONDITION. SEAL ALL CONDUIT PENETRATIONS WEATHER TIGHT WITH ACRYLIC WEATHERPROOF CAULKING SUITABLE FOR PAINTING. SEAL ALL OPENINGS AND CONDUIT PENETRATIONS TO MAINTAIN RATING OF FIRE RATED CONSTRUCTION. PROVIDE FLASHING AROUND CONDUITS AT ALL REQUIRED ROOF PENETRATIONS. ROOF FLASHING SHALL CONFORM TO STANDARD RECOMMENDED INSTALLATION DETAILS OF THE ROOF SYSTEM MANUFACTURER WHICH MAY BE OBTAINED FROM
- B. POWER OUTAGES: SCHEDULE POWER OUTAGES FOR EVENINGS, WEEKENDS, OR HOLIDAYS UNLESS OTHERWISE APPROVED. INCLUDE COSTS FOR OVERTIME AND WORK OUTSIDE REGULAR HOURS.
- C. FIELD VERIFICATION: FIELD VERIFY EXISTING POWER AND SIGNAL CIRCUIT WIRING AND SOURCE OF SUPPLY AS REQUIRED TO PERFORM WORK.
- D. ACCESS: CAREFULLY REMOVE, STORE, AND REINSTALL REMOVABLE PANELS AND CEILING TILES WHERE ACCESS TO PERFORM WORK IN CRAWL SPACES AND CEILING SPACES IS REQUIRED. ACCESS TO CRAWL SPACES SHALL BE SECURED AT ALL TIMES EXCEPT WHEN CONTRACTOR IS PRESENT AND PERFORMING WORK IN THE ACCESSED SPACE.
- E. CIRCUIT DIRECTORIES: UPDATE CIRCUIT DIRECTORIES IN EXISTING PANELS TO INDICATE CHANGES AND ADDITIONS TO EACH CIRCUIT. PROVIDE TYPEWRITTEN INDEX OF CIRCUITS LOCACTED ON INSIDE FOOR OF EACH PANEL. IDENTIFY LOAD TYPE AND LOCATION USING FINAL ROOM NAMES OR NUMBERS VERIFIED BY OWNER.
- 5. DEMOLITION AND EXTENSION OF EXISTING ELECTRICAL WORK
- A. REMOVE, RELOCATE AND EXTEND EXISTING SYSTEMS TO ACCOMMODATE NEW CONSTRUCTION. FOR SELECTIVE DEMOLITION, REFER TO ARCHITECTURAL AND MECHANICAL PLANS AND INCLUDE ELECTRICAL DEMOLITION TO SUPPORT REMOVAL AND REPLACEMENT WORK NOT OTHERWISE INDICATED IN ELECTRICAL DRAWINGS.
- B. ELECTRICAL DEMOLITION INCLUDES THE DISCONNECTING, REMOVAL, AND DISPOSAL OF FIXTURES, DEVICES AND EQUIPMENT WHERE INDICATED, ALONG WITH ASSOCIATED WIRING.
- C. THE FOLLOWING SHALL BE CONSIDERED AS ABANDONED UNLESS OTHERWISE INDICATED:
- 1. WIRING TO FIXTURES, DEVICES, AND EQUIPMENT BEING REMOVED OR DISCONNECTED.
- CONDUIT CONTAINING CONDUCTORS OR CABLE THAT HAVE BEEN DISCONNECTED FROM A SOURCE OF SUPPLY OR LEFT EMPTY BY THE REMOVAL OF CONDUCTORS.
- OPEN CONDUCTORS OR CABLE THAT HAVE BEEN DISCONNECTED FROM A SOURCE OF SUPPLY.
- 4. FIXTURES, DEVICES, EQUIPMENT, AND OUTLETS LOCATED IN WALLS, CEILINGS, AND FLOORS INDICATED TO BE REMOVED.
- 5. FIXTURES, DEVICES, AND EQUIPMENT IDENTIFIED AS BEING REPLACED.
- D. REMOVE ABANDONED WIRE AND CABLE FOR POWER AND SIGNAL SYSTEMS TO SOURCE OF SUPPLY.
- E. REMOVE ABANDONED CONDUIT, CABLE, AND OUTLETS WHERE EXPOSED AND WITHIN ACCESSIBLE CEILING, PLENUM, AND OPENED WALL SPACES.
- F. DISCONNECT ABANDONED OUTLETS AND REMOVE DEVICES.
- G. REPAIR ADJACENT CONSTRUCTION AND FINISHES DAMAGED DURING DEMOLITION AND EXTENSION WORK.
- H. CUT-IN FLUSH OUTLET BOXES AND FISH CONDUIT IN EXISTING CONSTRUCTION OF REMODELED AREAS WHERE CONDITIONS PERMIT. FLEXIBLE CONDUIT IS APPROVED WHERE FISHING OF CONDUIT IS REQUIRED.
- I. EXTEND EXISTING OUTLET BOXES AS REQUIRED TO ACCOMMODATE NEW SURFACE TREATMENTS.

- J. MAINTAIN ACCESS TO EXISTING ELECTRICAL SYSTEMS TO REMAIN ACTIVE. MODIFY INSTALLATION OR PROVIDE ACCESS PANELS AS APPROPRIATE.
- K. REPLACE, MODIFY OR EXTEND EXISTING OUTLET BOXES TO MEET VOLUME REQUIREMENTS. CUT SURFACES AS REQUIRED TO REPLACE (OR MODIFY) EXISTING OUTLET BOXES AND TO INSTALL SUPPORTS FOR NEW BOXES AND FIXTURES AND PATCH TO MATCH ADJACENT SURFACE.
- L. PROVIDE NEW SUPPORTS FOR EXISTING CONDUIT AND OPEN CABLE ACCESS DURING CONSTRUCTION AND WHICH IS TO REMAIN OR BE REUSED, AS REQUIRED TO COMPLY WITH CURRENT CODE. COMPLY WITH REQUIREMENTS OF APPLICABLE SIGNAL SYSTEM SPECIFICATIONS FOR SUPPORT OF SIGNAL CABLES.
- 6. DISPOSITION OF MATERIALS
- A. PRIOR TO START OF DEMOLITION, COORDINATE WITH OWNER TO IDENTIFY MATERIALS AND EQUIPMENT FOR SALVAGE. DISCONNECT AND REMOVE ITEMS TO BE SALVAGED AND DELIVER TO AN AREA ON SITE DESIGNATED BY THE OWNER. DISCONNECT, REMOVE, AND HANDLE SALVAGE MATERIAL AND EQUIPMENT IN A MANNER SO AS NOT TO DAMAGE OR OTHERWISE RENDER UNUSABLE.
- B. MATERIALS AND EQUIPMENT REMOVED AND NOT REUSED OR SALVAGED TO THE OWNER SHALL BECOME THE PROPERTY OF THE CONTRACTOR UNLESS OTHERWISE INDICATED. REMOVE SUCH MATERIAL AND EQUIPMENT FROM THE OWNER'S PROPERTY AND DISPOSE LEGALLY OFF SITE.
- C. TRANSFORMERS, BALLASTS, FLUORESCENT LAMPS, AND OTHER REMOVED MATERIALS AND EQUIPMENT WHICH MAY CONTAIN POLYCHLORINATED BIPHENYLS (PCB'S) OR MERCURY SHALL BE CONSIDERED HAZARDOUS WASTE. HANDLE, TRANSPORT, AND DISPOSE OF THESE MATERIALS AND EQUIPMENT IN ACCORDANCE WITH APPLICABLE STATE AND FEDERAL LAWS. PROVIDE TO THE OWNER A CERTIFICATE OF DISPOSAL WITHIN THE ONE YEAR CONTRACT WARRANTY PERIOD.
- 7. REGULATORY REQUIREMENTS
- NATIONAL ELECTRICAL CODE, STATE AND LOCAL ELECTRICAL, FIRE, AND BUILDING CODES; LOCAL UTILITY COMPANY REQUIREMENTS. OBTAIN AND PAY FOR REQUIRED PERMITS.

 8. FIRE RATED CONSTRUCTION
- VERIFY LOCATION OF FIRE RATED WALLS AND CEILINGS WITH ARCHITECTURAL PLANS PRIOR TO ROUGH-IN. INSTALLATION OF BOXES, ROUGH-IN CANS, AND CONDUITS THAT RESULT IN MEMBRANE OR THROUGH PENETRATIONS SHALL COMPLY WITH IBC 712.1 THROUGH 712.4 TO MAINTAIN FIRE RATING OF CONSTRUCTION ASSEMBLY. COORDINATE LOCATIONS AND CONSTRUCTION REQUIREMENTS WITH GENERAL CONTRACTOR.
- 9. MOUNTING HEIGHTS
- A. HEIGHT OF OUTLETS MEASURED TO CENTER OF BOX, UNLESS OTHERWISE INDICATED:

WALL SWITCHES AND DIMMERS 48 INCHES WALL RECEPTACLES 18 INCHES

WATER COOLERS MANUF. RECOMMENDATION

COUNTER HEIGHT +3 INCHES ABOVE SPLASH


VOICE/DATA 18 INCHES
TV 18 INCHES

CASEWORK AND OTHER OUTLETS AS DIRECTED

- B. MOUNTING HEIGHT FOR WALL MOUNTED LIGHT FIXTURES AND FOR HANGING FIXTURES SUPPORTED BY PENDANTS, CABLE, CHAIN, CONDUIT, RODS, OR OTHER MEANS SHALL BE DETERMINED BY THE ARCHITECT/ENGINEER DURING CONSTRUCTION UNLESS OTHERWISE INDICATED IN THE CONSTRUCTION DOCUMENTS.
- 10. GROUNDING
- A. GROUND NEW ELECTRICAL SERVICES AND SEPARATELY DERIVED SYSTEMS PER CODE. A MINIMUM OF TWO (2) NEC 250.52 PERMITTED GROUNDING ELECTRODES MUST BE INSTALLED AND LOCATED AT LEAST 10 FEET APART AND SHALL INCLUDE A CONCRETE ENCASED OR A DRIVEN ELECTRODE.
- B. PROVIDE EQUIPMENT GROUNDING PER CODE EXCEPT INCLUDE A SEPARATE INSULATED GREEN EQUIPMENT GROUNDING CONDUCTOR IN ALL FEEDERS AND IN BRANCH CIRCUITS.
- C. ISOLATED GROUND RECEPTACLE OUTLETS: PROVIDE A SEPARATE INSULATED GROUNDING CONDUCTOR, GREEN WITH YELLOW STRIPE, AND CONNECTED TO GROUND ONLY AT SERVICE OR SEPARATELY DERIVED POWER SOURCE. PROVIDE SEPARATE EQUIPMENT GROUNDING AND ISOLATED GROUNDING CONDUCTORS IN CONDUITS WHICH SERVE BOTH ISOLATED AND NON-ISOLATED PLUG-IN OUTLETS.
- 11. RACEWAYS
- A. GENERAL: EMT INDOORS; RIGID GALVANIZED STEEL OUTDOORS ABOVE GRADE; SCHEDULE 40 PVC BELOW GRADE; FLEXIBLE CONDUIT FOR FIXTURE AND EQUIPMENT CONNECTIONS, LIQUID TIGHT IN DAMP AND WET LOCATIONS, 72 INCH MAXIMUM LENGTH. FLEXIBLE CONDUIT MAY BE USED BRANCH CIRCUIT WIRING WHERE CONCEALED IN WALLS AND CASEWORK. CONCEAL RACEWAYS WITHIN BUILDING CONSTRUCTION UNLESS OTHERWISE NOTED OR SPECIFICALLY AUTHORIZED BY THE ARCHITECT/ENGINEER. MINIMUM SIZE CONDUIT FOR HOMERUNS SHALL BE 3/4 INCH DIAMETER.
- COPPER BUILDING WIRE INSTALLED IN RACEWAY, TYPE THWN, UNLESS OTHERWISE INDICATED. MINIMUM CONDUCTOR SIZE FOR LIGHTING AND POWER BRANCH CIRCUITS SHA
- INDICATED. MINIMUM CONDUCTOR SIZE FOR LIGHTING AND POWER BRANCH CIRCUITS SHALL BE #12 AWG.
- 13. WIRING DEVICES
- A. GENERAL: PROVIDE COMMERCIAL SPECIFICATION GRADE WITH MATCHING COVER PLATE. RECEPTACLE OUTLETS SHALL BE DUPLEX NEMA 5-20R UNLESS OTHERWISE INDICATED, EXCEPT NEMA 5-15R MAY BE SUBSTITUTED FOR MULTI-OUTLET GENERAL PURPOSE CIRCUITS. DEVICE AND PLATE COLOR AS SELECTED BY ARCHITECT/OWNER.
- B. GFCI: PROVIDE GFCI PROTECTION FOR OUTLETS LOCATED WITHIN 6 FEET OF SINKS AND AS OTHERWISE INDICATED.
- C. COMPUTER PURPOSE OUTLETS: STANDARD CONVENIENCE OUTLETS ON SEPARATE BRANCH CIRCUITS.
- [C. COMPUTER PURPOSE OUTLETS: SAME MANUFACTURE, DESIGN, AND COLOR AS DUPLEX GENERAL PURPOSE OUTLETS EXCEPT DEVICE GROUND TERMINAL SHALL BE ISOLATED FROM DEVICE MOUNTING STRAP AND PERMANENT SPECIAL PURPOSE IDENTIFICATION SHALL BE VISIBLE ON THE WIRING DEVICE.]
- 14. LIGHTING
- A. GENERAL: PROVIDING LIGHTING FIXTURES COMPLETE WITH LAMPS, BALLASTS, MOUNTING HARDWARE, AND SUPPORTS. SEE FIXTURE SCHEDULE.
- B. MOUNTING: PROVIDE NECESSARY HANGERS, BRACKETS, PLATES, ANCHORS, AND OTHER MOUNTING ACCESSORIES REQUIRED BY CONSTRUCTION FEATURES AND CEILING CONDITIONS. SECURE FIXTURES TO COMPLY WITH SEISMIC REQUIREMENTS PER CODE.
- C. EXIT, SELF-CONTAINED EMERGENCY, NIGHT LIGHTS: CONNECT AHEAD OF SWITCH CONTROL ON LOCAL LIGHTING CIRCUIT.
- 15. SIGNAL PATHWAY
- A. SINGLE PURPOSE OUTLETS (VOICE, DATA, TV): 4-INCH SQUARE X 2-1/8-INCH DEEP OUTLET BOX WITH SINGLE GANG PLASTER RING. PROVIDE BLANK DEVICE PLATE ON UNUSED OUTLETS.

- B. TELECOMMUNICATIONS OUTLETS (COMBINATION VOICE/DATA): 4-INCH SQUARE X 2-1/8-INCH DEEP OUTLET BOX WITH SINGLE GANG PLASTER RING. PROVIDE BLANK DEVICE PLATE ON UNUSED OUTLETS.
- C. OUTLET RACEWAY: UNLESS OTHERWISE INDICATED, PROVIDE 3/4 INCH DIAMETER CONDUIT CONCEALED INSIDE WALL OR CASEWORK FROM EACH OUTLET UP TO NEAREST ACCESSIBLE CEILING SPACE OF SAME FLOOR [CRAWL SPACE]. TERMINATE CONDUIT WITH PLASTIC BUSHING. INSTALL MAXIMUM TWO 90 DEGREE EQUIVALENT BENDS BETWEEN RACEWAY TERMINATIONS.
- D. CONDUIT SLEEVES: PROVIDE CONDUIT SLEEVES FOR INSTALLING OPEN SIGNAL CABLES THRU FIRE RATED CONSTRUCTION AND THRU PARTITION WALLS ABOVE ACCESSIBLE CEILINGS. LOCATE AND SIZE SLEEVES PER APPROVED SHOP DRAWINGS PROVIDED UNDER RELATED SECTIONS AND AS OTHERWISE INDICATED.
 - 16

LAWHEAD ARCHITECTS P.S.

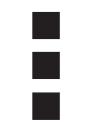

1239 120TH AVE. N.E., STE. D BELLEVUE, WA 98005 (425) 556-1220





|

VESTMINSTER MANOR

Fixelone & Roof Project

PHASE...

JOB NO...

23-10

DATE... 8/13/24

SHEET TITLE...

ELECTRICAL

SPECIFICATIONS

SHEET NO...

F0-2

GENERAL NOTES:

- ALL EQUIPMENT IS EXISTING AND TO BE RE-USED UNLESS NOTED OTHERWISE.
- DISCONNECT ALL ELECTRICAL DEVICES, REMOVE DEVICES AND CONDUIT ON EXTERIOR OF BUILDING. RE-INSTALL DEVICES AS CLOSE TO ORIGINAL LOCATION AS POSSIBLE. CONCEAL CONDUIT WITHIN NEW SIDING WHERE POSSIBLE.



Sing County Housing Authority
VESTMINSTER MANOR

PHASE...

Bid Set

JOB NO...


23-10

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8/13/24


SHEET TITLE...

1ST FLOOR PLAN


E3-1

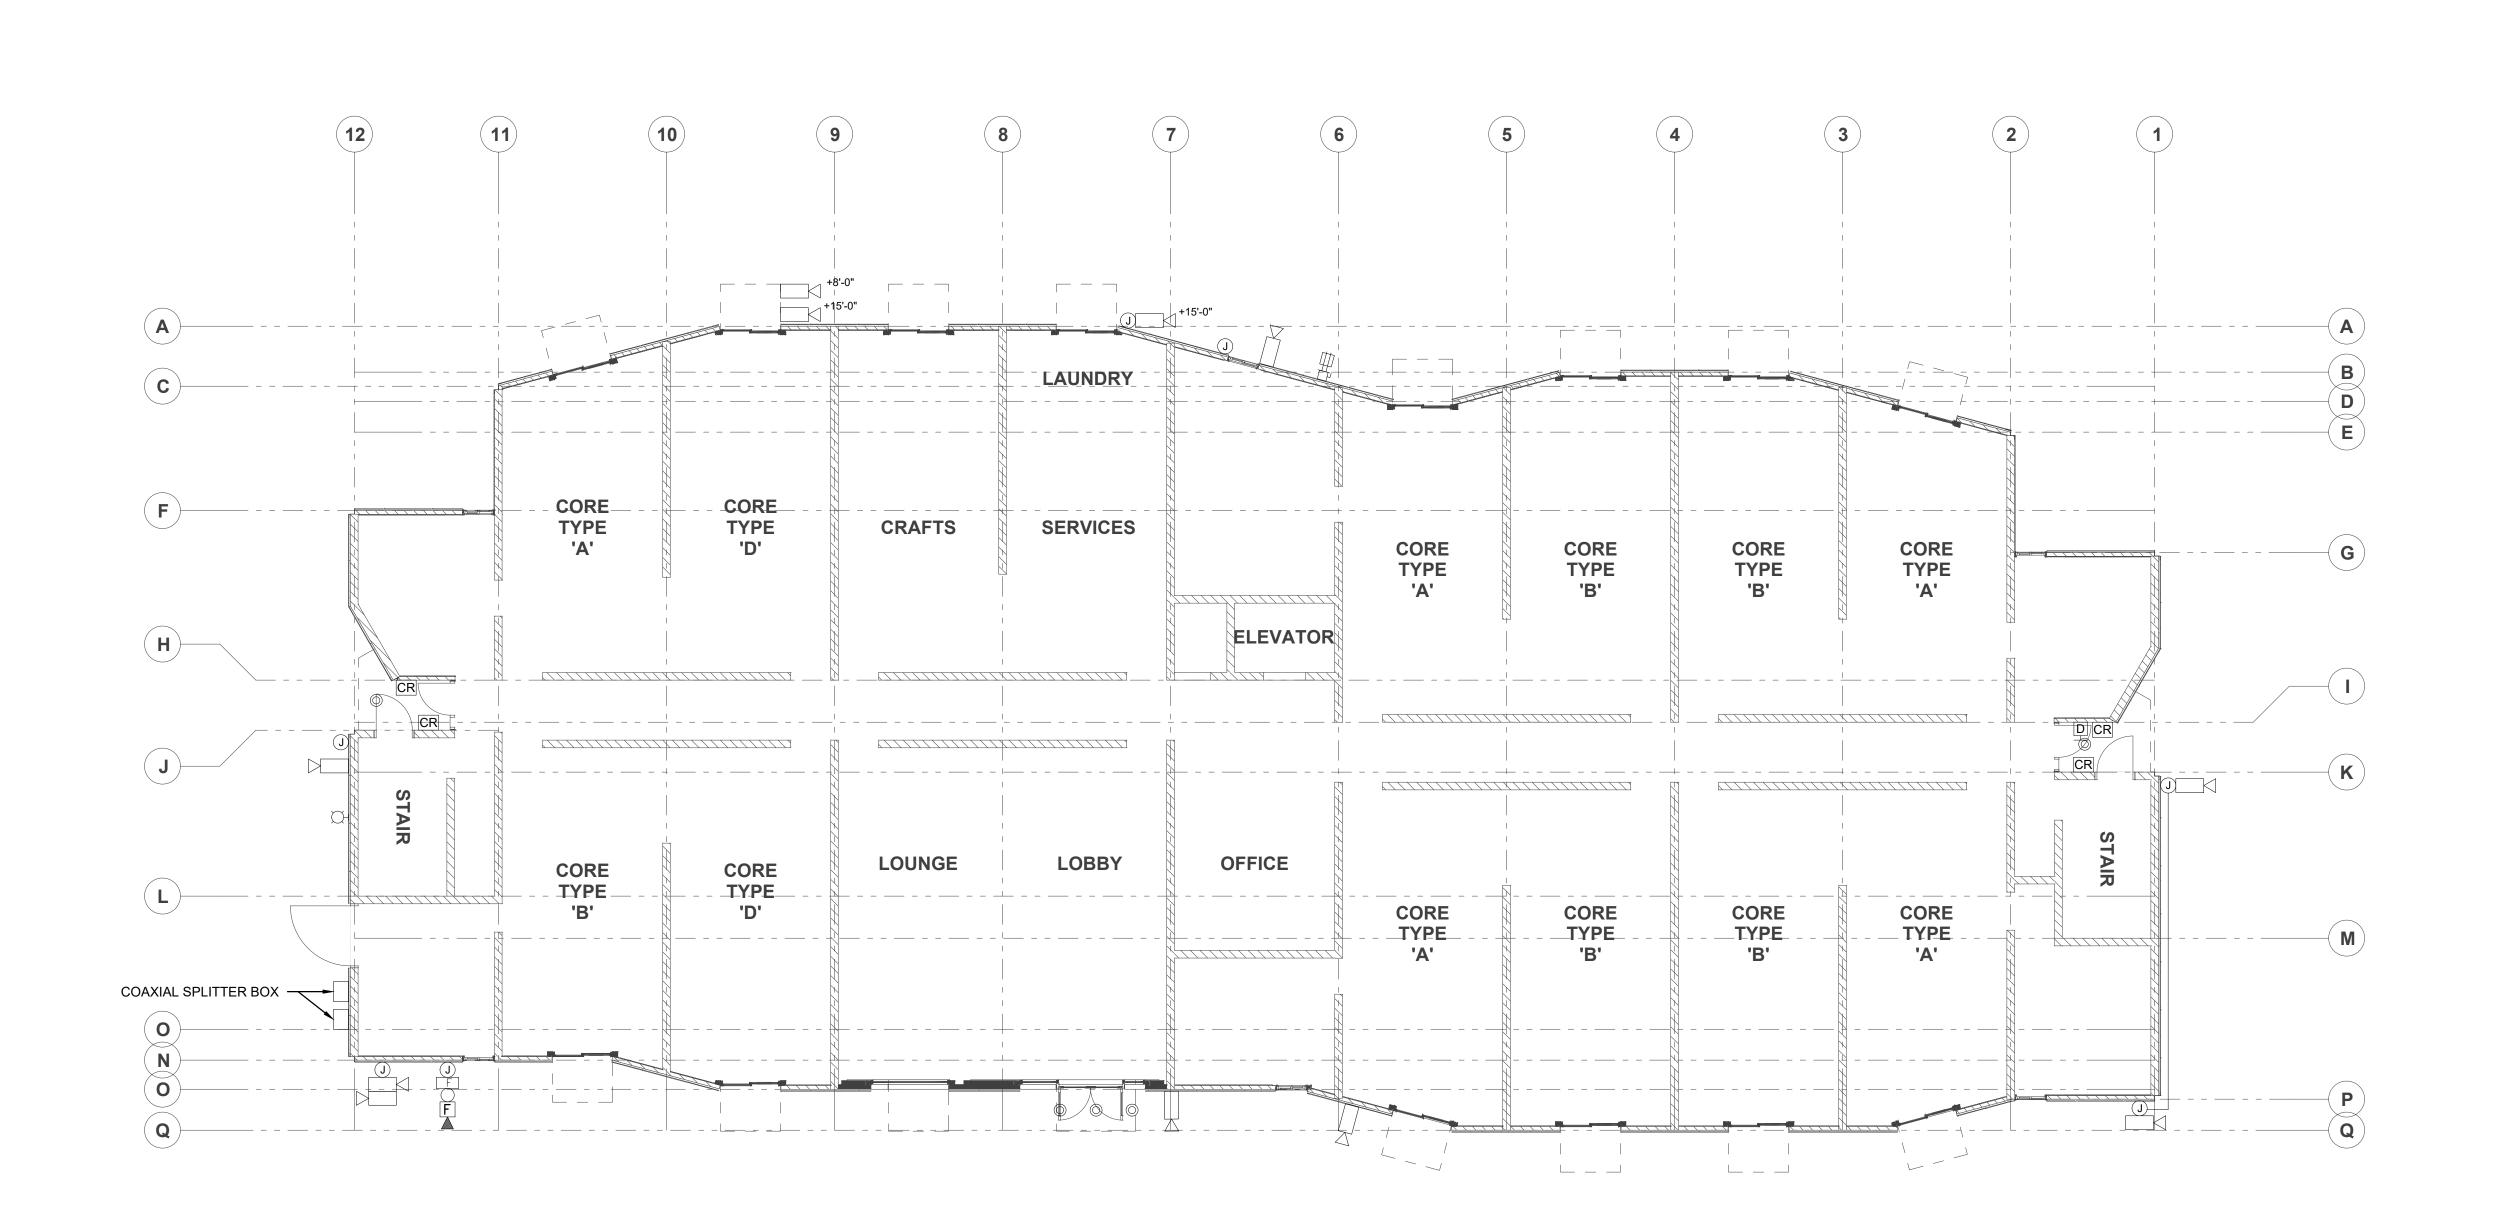

1 1ST FLOOR PLAN

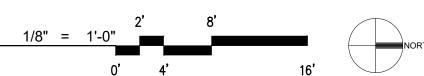

ALL EQUIPMENT IS EXISTING AND TO BE RE-USED UNLESS NOTED OTHERWISE.

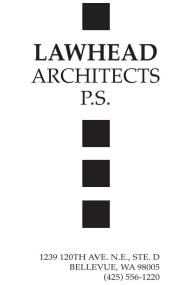





JOB NO... 23-10


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SHEET TITLE... 4TH FLOOR PLAN




4TH FLOOR PLAN



ROOFTOP EQUIPMENT FED FROM PANEL 'MC' ON 4TH FLOOR. SEE SHEET E3-4.

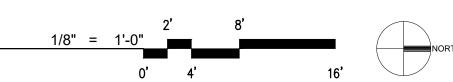PLAN NOTES:

- DISCONNECT POWER FROM EXHAUST FANS TO ALLOW FOR REMOVAL AND RE-ROOFING. RECONNECT WHEN FANS ARE REINSTALLED.
- REMOVE CONDUIT AND CONDUCTORS FROM ROOF SURFACE. RECONNECT AND RE-FEED ALL EQUIPMENT WHEN ROOFING IS COMPLETE. ROUTE CONDUIT AWAY FROM ROOF ACCESS DOOR.
- REMOVE COAXIAL CABLES TO JUNCTION BOX ON SIDE OF BUILDING. WHEN RE-FEEDING COAXIAL CABLE TO EACH UNIT. CONCEAL WITHIN NEW SIDING.
- VERIFY ANY ELECTRICAL CONNECTIONS TO LARGE EXHAUST HOOD NEXT TO EF-12. DISCONNECT AND REMOVE CONDUCTORS IF PRESENT.
- TEMOVE EXISTING AREA LIGHTS TO ALLOW FOR RE-ROOFING. REINSTALL AREA LIGHTS ONCE RE-ROOFING IS COMPLETE.

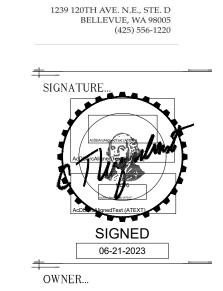

LAWHEAD ARCHITECTS




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8/13/24

ROOF PLAN



ROOF PLAN

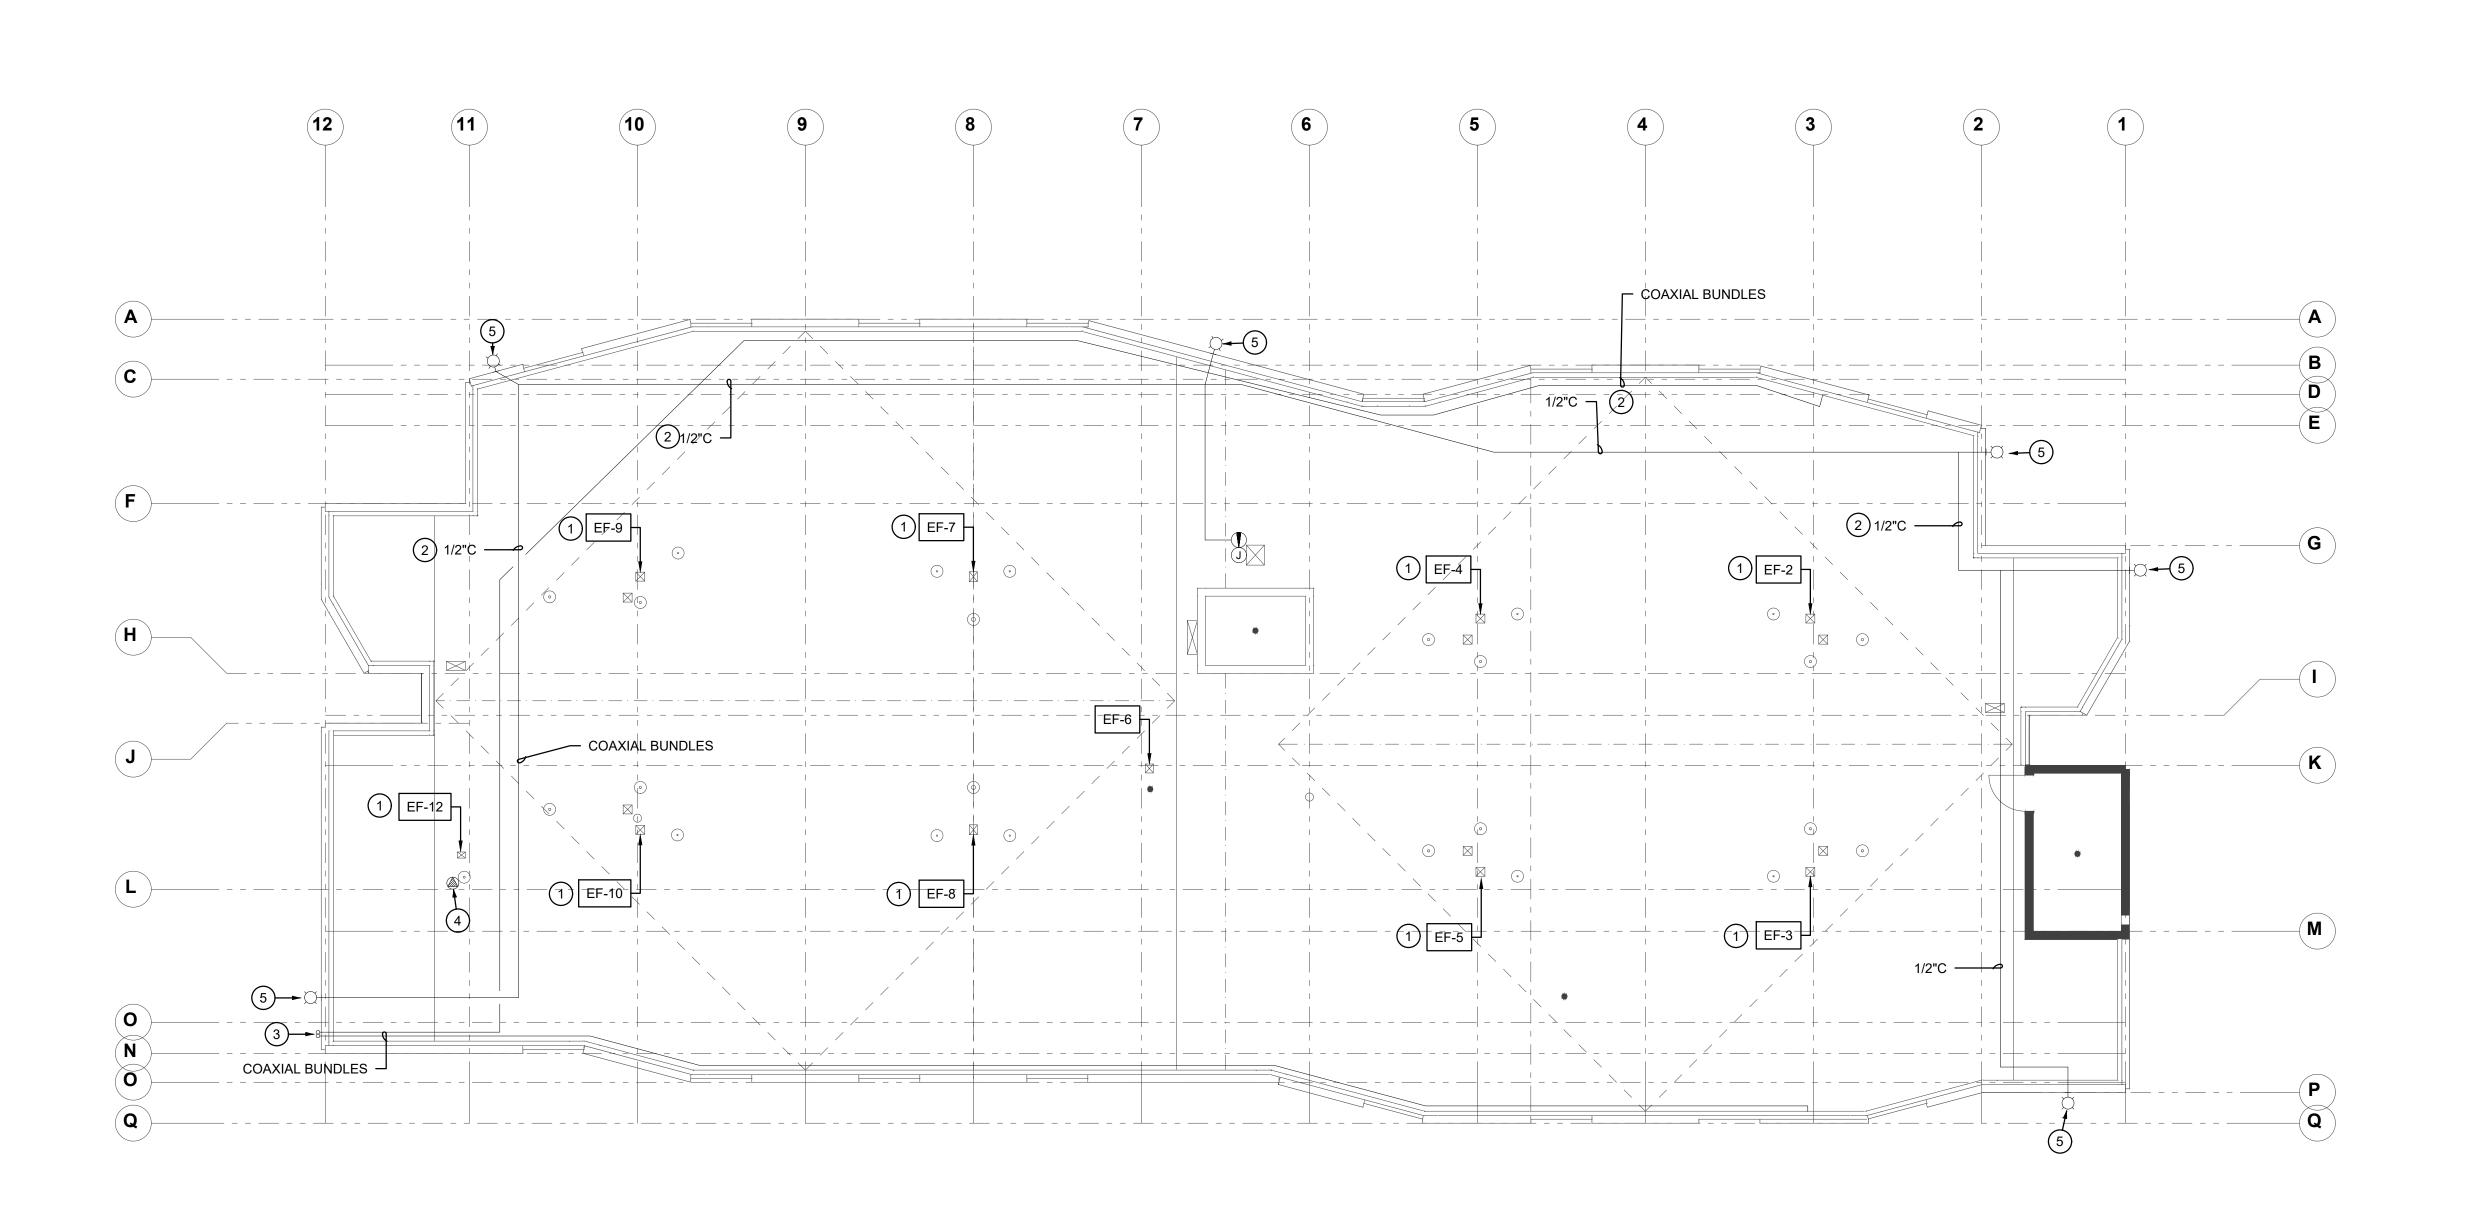