LEGAL DESCRIPTION:

(PER STATUTORY WARRANTY DEED RECORDED UNDER RECORDING NO. 20031103001766, RECORDS OF KING COUNTY, WASHINGTON)

PARCEL A:

THAT PORTION OF THE NORTHEAST QUARTER OF THE NORTHWEST QUARTER OF THE NORTHEAST QUARTER OF SECTION 7, TOWNSHIP 26 NORTH, RANGE 5 EAST, W.M., IN KING COUNTY, WASHINGTON, DESCRIBED AS FOLLOWS:

BEGINNING AT THE NORTHEAST CORNER OF SAID SUBDIVISION, THENCE WESTERLY ALONG THE NORTH LINE OF SAID NORTHEAST QUARTER, 30 FEET TO THE WEST LINE OF 96TH AVENUE NORTHEAST AND THE TRUE POINT OF

THENCE SOUTHERLY ALONG THE WEST LINE OF 96TH AVENUE NORTHEAST TO THE SOUTH LINE OF THE NORTH HALF OF SAID NORTHEAST QUARTER OF THE NORTHWEST QUARTER;

THENCE WESTERLY ALONG SAID SOUTH LINE 140 FEET;

THENCE NORTHWESTERLY TO A POINT ON THE NORTH LINE OF SAID NORTHEAST QUARTER, 175 FEET WESTERLY OF THE TRUE POINT OF

THENCE EASTERLY 175 FEET ALONG SAID NORTH LINE TO THE TRUE POINT OF

EXCEPT THE EAST 90 FEET OF THE SOUTH 235 FEET THEREOF.

PARCEL B:

THE EAST 90 FEET OF THE SOUTH 235 FEET OF THAT PORTION OF THE NORTHEAST QUARTER OF THE NORTHWEST QUARTER OF THE NORTHEAST QUARTER OF SECTION 7, TOWNSHIP 26 NORTH, RANGE 5 EAST, W.M., IN KING COUNTY, WASHINGTON, DESCRIBED AS FOLLOWS:

BEGINNING AT THE NORTHEAST CORNER OF SAID SUBDIVISION. THENCE WESTERLY ALONG THE NORTH LINE OF SAID NORTHEAST QUARTER, 30 FEET TO THE WEST LINE OF 96TH AVENUE NORTHEAST AND THE TRUE POINT OF

- THENCE SOUTHERLY ALONG THE WEST LINE OF 96TH AVENUE NORTHEAST TO THE SOUTH LINE OF THE NORTH HALF OF SAID NORTHEAST QUARTER OF THE NORTHWEST QUARTER;
- THENCE WESTERLY ALONG SAID SOUTH LINE 140 FEET; THENCE NORTHWESTERLY TO A POINT ON THE NORTH LINE OF SAID NORTHEAST QUARTER, 175 FEET WESTERLY OF THE TRUE POINT OF
- THENCE EASTERLY 175 FEET ALONG SAID NORTH LINE TO THE TRUE POINT OF BEGINNING;

PARK ROYAL APARTMENTS

TEMPORARY BENCH

TOP OF CURB **TEMPORARY EROSION AND**

SEDIMENTARY CONTROL

TRAFFIC

TYPICAL

AND

TO FINISH GRADE TOP OF WALL

TRAFFIC SIGNAL

UNLESS NOTED

OTHERWISE

WASHINGTON

ADMINISTRATIVE

DEPARTMENT OF

TRANSPORTATION

TOP OF THICKENED

WATER, WEST, WITH

WASHINGTON STATE

<u>ABBRI</u>	<u>EVIATIONS</u>	MNRL NO
AD	AREA DRAIN	N
AGG	AGGREGATE	NTS
APPROX	APPROXIMATELY	O/W
ARCH	ARCHITECTURAL	0,,,,
ASPH	ASPHALT	Р
AVE	AVENUE	PED
3/BC	BOTTOM OF CURB	PIP
3/BC 3M	BENCHMARK	PIV
BMP	BEST MANAGEMENT	PIV
DIVIP	PRACTICES	PL
℃ D	CATCH BASIN	POC
CB		PUC
CD	CONDUIT DUCT	DOE
O	BANK	PSE
CL, &	CENTER LINE, CLASS	DD0
00	CLEANOUT	PRC
COMM	COMMUNICATIONS	
CONC	CONCRETE	PC
COE	CITY OF EVERETT	
CSBC	CRUSHED SURFACE	PT
	BASE COURSE	
CSTC	CRUSHED SURFACE	PUD
	TOP COURSE	
OB	DUCT BANK	
)I	DUCTILE IRON	R
DOE	DEPARTMENT OF	RJ
	ECOLOGY	RL
DSP	BUILDING	ROW
	DOWNSPOUT	RT
DWG	DRAWING	S
DWY, D/W	DRIVEWAY	SD
E ECB	EAST	
ECB	ELECTRICAL	SF
	CONDUIT, BURIED	SL
ECD	ELECTRICAL	SNS
	CONDUIT, DUCT	SS
ELEC	ELECTRICAL	
EL/ELEV	ELEVATION	SSS
ESMT	EASEMENT	
EX/EXIST	EXISTING	ST
FDC	FIRE DEPARTMENT	STA
	CONNECTION	STD
=F	FINISHED FLOOR	SVC
- G	FINISH GRADE	SW
FH	FIE HYDRANT	S/W
	FLOW LINE	TBD
_ =[_	FLANGE	TBM
- FND	FOUNDATION	
- 0	FIBER OPTIC	TC
=U	FRANCHISE UTILITY	TESC
G	GAS	1200
GV	GATE VALVE	
∃H	HANDHOLE	
 	HOT MIX ASPHALT	TFG
_A	LANDSCAPE ARCH	TOW
-^ _T	LEFT	TR
MAX	MAXIMUM	TS
VIAA ME	MATCH EXISTING	TTE
MEP	MECHANICAL	116
VILI'	/ELECTRICAL	TYP
	/ELECTRICAL /PLUMBING	

/PLUMBING

MECHANICAL JOINT

MANHOLE

MINIMUM

MINERAL NUMBER NORTH NOT TO SCALE OIL WATER SEPARATOR PRIMARY POWER PEDESTRIAN PROTECT IN PLACE POST INDICATOR VALVE PROPERTY LINE POINT OF CONNECTION PUGET SOUND ENERGY POINT OF REVERSE CURVATURE POINT OF CURVATURE POINT OF TANGENCY SNOHOMISH COUNTY PUBLIC UTILITY DISTRICT RADIUS RESTRAINED JOINT RIGHT OF WAY LINE RIGHT OF WAY RIGHT SOUTH SERVICE DRAIN (STORM) SQUARE FEET STREET LIGHT STREET LIGHT STREET LIGHT STREET NAME SIGN SIDE SEWER COMBINED SIDE SEWER SANITARY STREET STATION STANDARD	NE 184TH PL WAY IN THORSK ST	NORTH NORTH	BOTHELL WAY NE
STREET STATION		NORTH	

SHEET INDEX				
SHEET NO	SHEET TITLE			
C1.0	COVER SHEET			
1	SURVEY			
C1.1	NOTES			
C2.0	TESC PLAN			
C2.1	TESC DETAILS			
C3.0	DEMOLITION PLAN			
C4.0	GRADING AND DRAINAGE PLAN			
C4.1	GRADING AND DRAINAGE DETAILS			
C4.2	WALL PROFILE			
S4.01	STRUCTURAL DETAILS			
C5.0	PAVING AND CHANNELIZATION			
C5.1	PAVING SECTIONS AND DETAILS			
C6.0	STREET FRONTAGE IMPROVEMENTS PLAN			

SURVEY LEGEND & ABBREVIATIONS PROJECT TEAM

SURVEY LE	EGEND & ABBREVIATIONS	PROJECT TEAM
\boxtimes WM	WATER METER	OWNER:
□ WR	WATER RISER	KING COUNTY HOUSING AUTHORITY 700 ANDOVER PARK W, SUITE C
∞	WATER BLOW-OFF	SEATTLE, WA 98188 PH: (206) 574-1249
Q	FIRE HYDRANT	Carl Frankel CarlF@KCHA.ORG
S	SEWER MANHOLE	CIVIL ENGINEER
CO	SEWER CLEANOUT	KPFF CONSULTING ENGINEERS 1601 5TH AVENUE, SUITE 1600
	STORM CATCH BASIN	SEATTLE, WA 98101 PH: (206) 926-0519
\ominus	STORM ROOF DRAIN/DOWNSPOUT	ALBERTO CISNEROS ALBERTO.CISNEROS@KPFF.COM
	STORM AREA DRAIN	-
Р	POWER VAULT	STRUCTURAL ENGINEER KPFF CONSULTING ENGINEERS
	SIGN	1601 5TH AVENUE, SUITE 1600 SEATTLE, WA 98101
	MAILBOX	PH: (206) 926-0519 NATE SCHWAB
	POST OR BOLLARD	NATE.SCHAB@KPFF.COM
	BENCH MARK	GEOTECHNICAL
•	MONUMENT (FOUND AS NOTED)	ENGINEER
XXXXXXXXXX	TAX PARCEL NUMBER	GEOENGINEERS 17425 NE UNION HILL ROAD #250
	DECIDUOUS TREE	REDMOND, WA 98052 PH: (425) 861-6050
D	DECIDUOUS (UNKNOWN TYPE)	ROBERT METCALFE RMETCALFE@GEOENGINEERS.COM
CY	CHERRY	
M	MAPLE	
COT	COTTONWOOD	
	CONIFEROUS TREE	
F	FIR	
#xx -	TREE TAG NO.	

CLF	CHAIN LINK FENCE
$= \sum_{i=1}^n \frac{a_i}{a_i} \left(\frac{a_i}{a_i} \frac{a_i}{a_i} \frac{a_i}{a_i} + \frac{a_i}{a_i} \frac{a_i}{a_i} \right) - \frac{a_i}{a_i} \partial_{a_i}^2 a_i^2$	
x -	x x
. 00000	• 00000000000
	10
	2

DRIVEWAY

FLOWLINE

WHEEL STOP

HOG WIRE FENCE

EXTRUDED CONCRETE CURB

CURB AND GUTTER

ECC

CG

ASPHALT PAVING CONCRETE PAVING **BUILDING LINE**

FENCE LINE (TYPE AS NOTED) ROCKERY WATER LINE

MAJOR CONTOURS MINOR CONTOURS STORM DRAINAGE LINE SANITARY SEWER LINE

UNDERGROUND POWER LINE

BID SET

SHEET **BOTHELL, WASHINGTON**


PARK ROYAL SITE









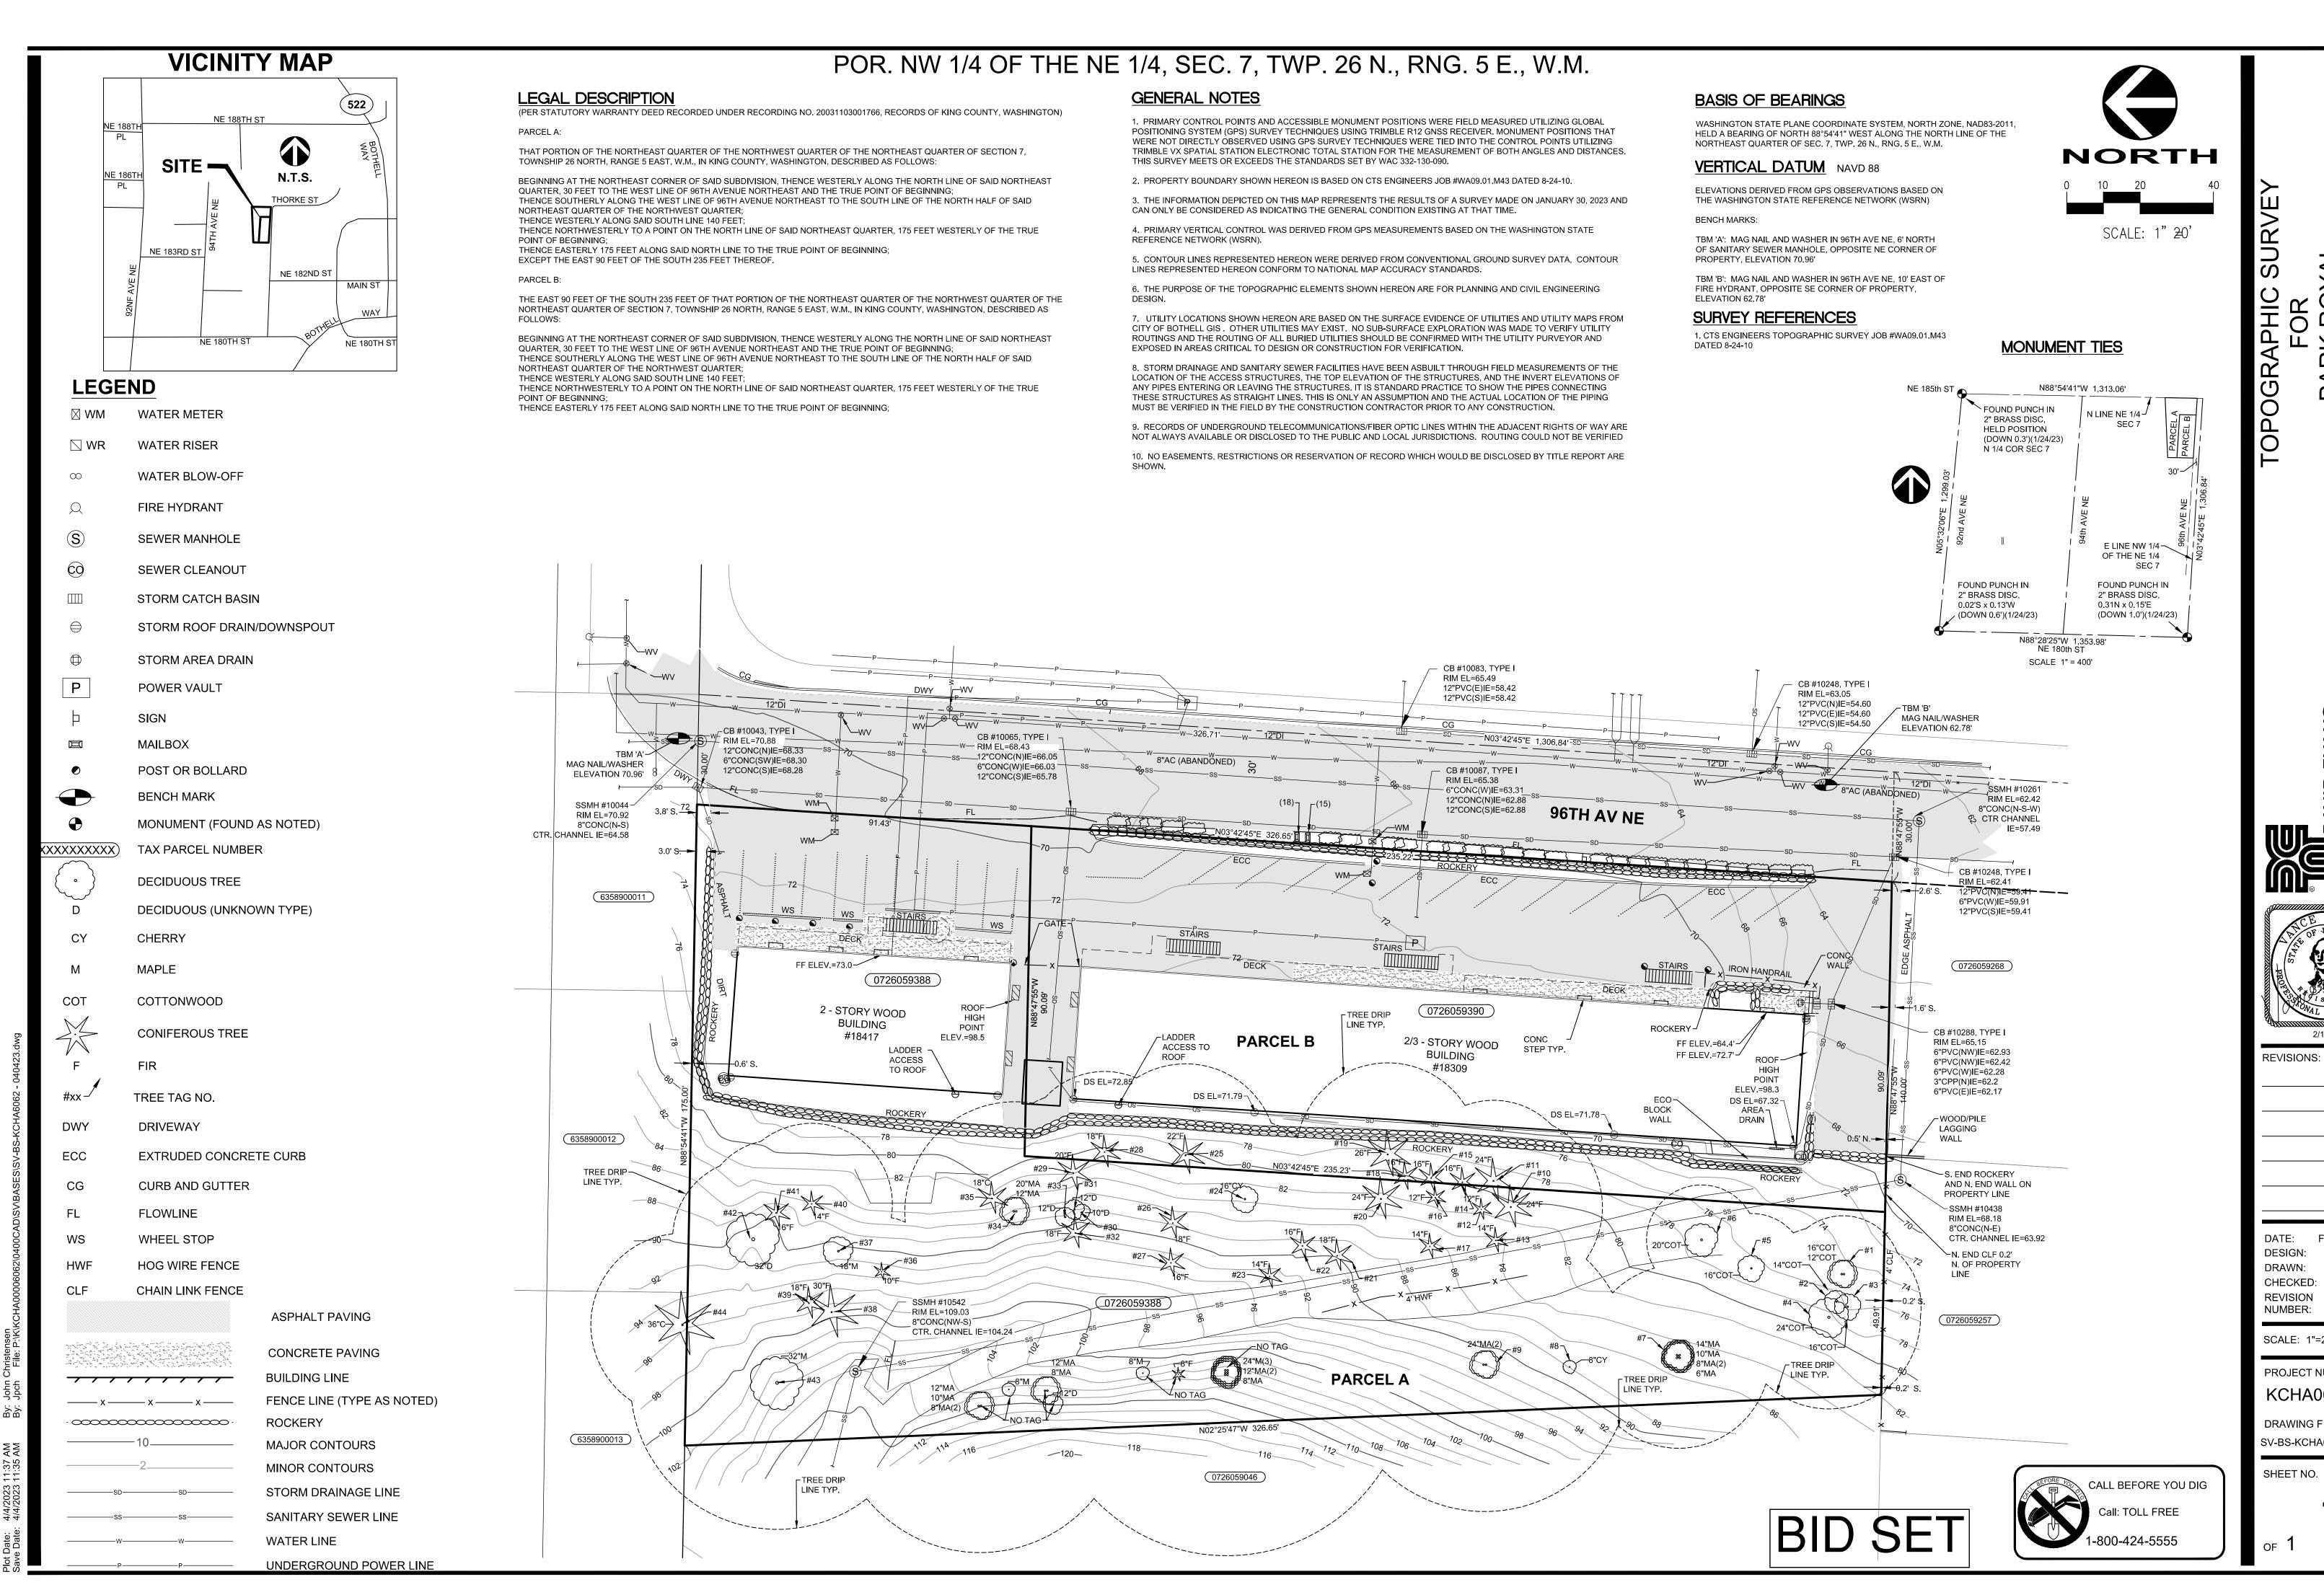

DESIGN: DRAWN: CHECKED: REVISION NUMBER:

SCALE: 1"=20'

PROJECT NUMBER:

KCHA00006062

DRAWING FILE: SV-BS-KCHA6062 - 040423.dwg

SHEET NO.

OF

(CITY OF BOTHELL) GENERAL PROJECT NOTES:

- 1. ALL DESIGN AND CONSTRUCTION MUST BE IN ACCORDANCE THE CITY OF BOTHELL MUNICIPAL CODE (BMC), THE CITY OF BOTHELL DESIGN AND CONSTRUCTION STANDARDS (BOTHELL STANDARDS), WSDOT STANDARD SPECIFICATIONS AND THE CONDITIONS OF PERMIT APPROVAL. IT IS THE SOLE RESPONSIBILITY OF THE DEVELOPER AND THE PROFESSIONAL CIVIL ENGINEER TO CORRECT ANY ERROR, OMISSION, OR VARIATION FROM THE ABOVE REQUIREMENTS FOUND IN THESE PLANS. ALL CORRECTIONS WILL BE AT NO ADDITIONAL COST OR LIABILITY TO CITY OF BOTHELI
- 2. THE DESIGN ELEMENTS WITHIN THESE PLANS HAVE BEEN REVIEWED ACCORDING TO BOTHELL STANDARDS REQUIREMENTS. SOME ELEMENTS MAY HAVE BEEN OVERLOOKED OR MISSED BY THE PLAN REVIEWER. ANY VARIANCE FROM ADOPTED STANDARDS IS NOT ALLOWED UNLESS SPECIFICALLY APPROVED BY THE CITY OF BOTHELL PRIOR TO CONSTRUCTION.
- 3. A COPY OF THE APPROVED PLANS, INCLUDING ALL REQUIRED CITY NOTES AND STAMPS, MUST BE ON THE JOB SITE WHENEVER CONSTRUCTION IS IN PROGRESS.
- . CONSTRUCTION NOISE IS LIMITED IN ACCORDANCE WITH BMC 8.26.; NORMALLY THIS IS 7:00 AM TO 8:00 PM, MONDAY THROUGH FRIDAY AND 9:00 AM THROUGH 6:00 PM ON SATURDAY WITH NO WORK ON SUNDAY OR CITY-OBSERVED HOLIDAYS UNLESS AS OTHERWISE APPROVED OR REQUIRED.
- 5. CITY OF BOTHELL DATUM MUST BE USED FOR ALL SURVEY CONTROL AND ELEVATION INFORMATION (NAVD 1988, NAD 83).
- 6. IT IS THE DEVELOPER /CONTRACTOR'S RESPONSIBILITY TO OBTAIN ALL CONSTRUCTION EASEMENTS NECESSARY BEFORE INITIATING OFF-SITE WORK. EASEMENTS REQUIRE REVIEW AND APPROVAL PRIOR TO CONSTRUCTION AND MUST BE INCLUDED ON THE APPROVED PLANS.
- 7. FRANCHISED UTILITIES OR OTHER INSTALLATIONS THAT ARE NOT SHOWN ON THESE APPROVED PLANS MAY NOT BE CONSTRUCTED UNLESS AN APPROVED SET OF PLANS THAT MEET ALL REQUIREMENTS FOR A RIGHT-OF-WAY INVASION PERMIT APPROVED BY THE CITY.
- 8. PRIVATE OR FRANCHISE UTILITIES MUST HAVE AT LEAST 5 FEET HORIZONTAL CLEARANCE FROM ALL CITY WATER SEWER, AND STORMWATER STRUCTURES.
- 9. A MINIMUM FULL-LANE WIDTH, 2-INCH MINIMUM THICKNESS GRIND AND OVERLAY IS REQUIRED FOR ROAD WIDENING OR PAVEMENT CUTS PARALLEL TO ROADWAY. FULL WIDTH, 2-INCH MINIMUM THICKNESS GRIND AND OVERLAY IS REQUIRED WHERE OTHER ROADWAY CUTS AND PATCHES ARE ACROSS THE ROADWAY WIDTH AT THE DIRECTION OF THE PUBLIC WORKS DIRECTOR. TRANSVERSE UTILITY TRENCHES MUST BE RESTORED WITH FULL ROAD WIDTH TRENCH-CUT PATCH A 5-FOOT MINIMUM BEYOND TRENCH EDGE.
- 10. ALL UTILITY TRENCHES AND ROADWAY SUBGRADE MUST BE BACKFILLED AND COMPACTED TO 95 PERCENT MAXIMUM DRY DENSITY. FLOWABLE CONTROLLED DENSITY FILL (CDF) MAY BE USED IF APPROVED BY THE PUBLIC WORKS CONSTRUCTION INSPECTOR (NO DRY CDF IS ALLOWED).
- 11. OPEN CUTTING OF EXISTING ROADWAYS FOR NON-FRANCHISED UTILITY OR STORM WORK IS NOT ALLOWED UNLESS SPECIFICALLY APPROVED AND NOTED ON THESE APPROVED PLANS. ANY OPEN CUT MUST BE RESTORED IN ACCORDANCE WITH BOTHELL STANDARDS.
- 12. SOIL TREATMENT INCLUDING BUT NOT LIMITED TO FLY-ASH AND CEMENT, MAY NOT BE USED AS IN FILL OR TRENCH BACKFILL WITHOUT APPROVAL BY THE PUBLIC WORKS DIRECTOR AND AN APPROVED PLACEMENT, TESTING, AND WATER-QUALITY INSPECTION PROGRAM.
- 13. CONTRACTOR IS RESPONSIBLE FOR PROVIDING ADEQUATE SAFEGUARDS, SAFETY DEVICES, PROTECTIVE EQUIPMENT, FLAGGERS, AND ANY OTHER NEEDED ACTIONS TO PROTECT THE LIFE, HEALTH, AND SAFETY OF THE PUBLIC, AND TO PROTECT PROPERTY IN CONNECTION WITH THE PERFORMANCE OF WORK COVERED BY THE CONTRACTOR. ANY WORK WITHIN THE TRAVELED RIGHT-OF-WAY THAT MAY INTERRUPT NORMAL TRAFFIC FLOW WILL REQUIRE AN APPROVED TRAFFIC CONTROL PLAN IN ACCORDANCE WITH THE MANUAL ON UNIFORM TRAFFIC CONTROL DEVICES (MUTCD) AND A TRAFFIC CONTROL PLAN APPROVED BY CITY OF BOTHELL.
- 14. CONTRACTOR MUST INSTALL AND MAINTAIN WHATEVER EROSION & SEDIMENTATION CONTROL MEASURES NECESSARY TO INSURE THAT SILT-LADEN WATER DOES NOT LEAVE THE CONSTRUCTION AREA. ANY SUCH FACILITIES INSTALLED MUST BE MAINTAINED IN PROPER OPERATING CONDITION UNTIL ALL DISTURBED AREAS HAVE BEEN REVEGETATED OR OTHERWISE DEVELOPED AND THE POTENTIAL FOR EROSION ELIMINATED.
- 15. CONSTRUCTION TRUCK TRAFFIC MUST BE ROUTED IN ACCORDANCE WITH AN APPROVED HAUL ROUTE AND CONTRACTOR PARKING MUST BE LOCATED ON-SITE UNLESS ALLOWED IN ACCORDANCE WITH AN APPROVED PARKING PLAN.
- 16. LOCATIONS OF EXISTING BURIED UTILITIES ARE SHOWN FOR DESIGN PURPOSES AND MAY NOT BE ACCURATE OR COMPLETE. IT IS THE RESPONSIBILITY OF THE CONTRACTOR TO LOCATE, HAVE LOCATED BY THE APPROPRIATE COMPANIES, AND/OR POTHOLE ALL UTILITIES PRIOR TO BEGINNING CONSTRUCTION. CALL UNDERGROUND LOCATE AT 1-800-424-5555 OR 811 A MINIMUM OF 48 HOURS PRIOR TO ANY EXCAVATIONS.
- 17. SUBMITTAL, REVIEW, AND APPROVAL OF AS-BUILT PLANS IS REQUIRED PRIOR TO ACCEPTANCE OF PLAT IMPROVEMENTS OR OTHER PERMIT FINALIZATION. AS-BUILTS ARE TO CONTAIN CAD, TIF, AND PDF FILES OF ALL PLAN SHEETS.

(CITY OF BOTHELL) TESC NOTES

- 1. THE TEMPORARY EROSION & SEDIMENT CONTROL (TESC) MEASURES SHOWN IN THESE PLANS ARE THE MINIMUM REQUIREMENTS FOR ANTICIPATED SITE CONDITIONS. DURING THE CONSTRUCTION PERIOD, THESE TESC MEASURES MUST BE UPGRADED AS NEEDED FOR UNEXPECTED STORM EVENTS AND MODIFIED TO ACCOUNT FOR CHANGING SITE CONDITIONS (E.G. ADDITIONAL COVER MEASURES, PUMPING AND CONTAINMENT, RELOCATION OF DITCHES AND SILT FENCES, PERIMETER PROTECTION ETC.) AS DIRECTED BY CITY OF BOTHELL.
- 2. THESE FACILITIES MUST BE SATISFACTORILY MAINTAINED UNTIL THE CONSTRUCTION AND LANDSCAPING IS COMPLETED AND THE POTENTIAL FOR ONSITE EROSION HAS PASSED. THE TESC PLANS ARE TO BE CONSIDERED A DYNAMIC MINIMUM GUIDELINE AND AS SUCH WILL MOST LIKELY HAVE TO BE CONTINUALLY EVALUATED AND/OR MODIFIED DEPENDING ON SITE CONDITIONS.
- 3. THE IMPLEMENTATION OF THESE TESC PLANS AND THE CONSTRUCTION, MAINTENANCE, REPLACEMENT, AND UPGRADING OF THESE TESC FACILITIES IS THE RESPONSIBILITY OF THE CONTRACTOR AND TESC SUPERVISOR UNTIL ALL CONSTRUCTION IS APPROVED.
- 4. THE BOUNDARIES OF THE CLEARING LIMITS SHOWN ON THIS PLAN MUST BE CLEARLY FLAGGED IN THE FIELD PRIOR TO CONSTRUCTION. DURING THE CONSTRUCTION PERIOD, NO DISTURBANCE BEYOND THE FLAGGED CLEARING LIMITS WILL BE PERMITTED. THE DEVELOPER AND CONTRACTOR MUST MAINTAIN THE FLAGGING FOR THE DURATION OF CONSTRUCTION.
- 5. STABILIZED CONSTRUCTION ENTRANCES MUST BE INSTALLED AT THE BEGINNING OF CONSTRUCTION AND MAINTAINED FOR THE DURATION OF THE PROJECT. ADDITIONAL MEASURES, SUCH AS CONSTRUCTED WHEEL WASH SYSTEMS OR WASH PADS, MAY BE REQUIRED TO ENSURE THAT ALL PAVED AREAS ARE KEPT CLEAN AND TRACK OUT TO ROAD RIGHT OF WAY DOES NOT OCCUR FOR THE DURATION OF THE PROJECT.
- 6. THE TESC FACILITIES SHOWN ON THIS PLAN MUST BE CONSTRUCTED PRIOR TO OR IN CONJUNCTION WITH ALL CLEARING AND GRADING SO AS TO ENSURE THAT THE TRANSPORT OF SEDIMENT TO SURFACE WATERS, DRAINAGE SYSTEMS, AND ADJACENT PROPERTIES IS MINIMIZED.
- THE TESC FACILITIES MUST BE INSPECTED DAILY BY THE DEVELOPER/TESC SUPERVISOR AND MAINTAINED TO ENSURE CONTINUED PROPER FUNCTIONING. WRITTEN RECORDS MUST BE KEPT OF WEEKLY REVIEWS OF THE TESC FACILITIES.
- 8. SOILS MUST NOT REMAIN EXPOSED AND UNWORKED FOR MORE THAN 7 DAYS FROM MAY 1 THROUGH SEPTEMBER 30 AND NOT MORE THAN 48 HOURS FROM OCTOBER 1 AND APRIL 30. EXPOSED AND UNWORKED SOILS MUST BE COVERED BY MULCH, SODDING, PLASTIC COVERING, JUTE-MATTING, OR AS OTHERWISE APPROVED OR REQUIRED BY THE PUBLIC WORKS CONSTRUCTION INSPECTOR.
- 9. THE TESC FACILITIES ON INACTIVE SITES MUST BE INSPECTED AND MAINTAINED A MINIMUM OF ONCE A MONTH DURING THE DRY SEASON, BI-MONTHLY DURING THE WET SEASON, OR WITHIN 24 HOURS FOLLOWING A STORM EVENT.
- 10. AT NO TIME MAY MORE THAN 6-INCHES OF SEDIMENT BE ALLOWED TO ACCUMULATE WITHIN A CATCH BASIN. ALL CATCH BASINS AND CONVEYANCE LINES MUST BE CLEANED PRIOR TO PAVING AND FINAL APPROVAL. THE CLEANING OPERATION MAY NOT FLUSH SEDIMENT-LADEN WATER INTO THE DOWNSTREAM SYSTEM.
- 11. ANY PERMANENT RETENTION/DETENTION FACILITY USED AS A TEMPORARY SETTLING BASIN MUST BE MODIFIED WITH THE NECESSARY TESC MEASURES AND MUST PROVIDE ADEQUATE STORAGE CAPACITY. IF THE FACILITY IS TO FUNCTION ULTIMATELY AS AN INFILTRATION SYSTEM, THE TEMPORARY FACILITY MUST BE ROUGH GRADED SO THAT THE BOTTOM AND SIDES ARE AT LEAST THREE FEET ABOVE THE FINAL GRADE OF THE PERMANENT FACILITY.
- 12. PRIOR TO THE BEGINNING OF THE WET SEASON (OCT. 1), ALL DISTURBED AREAS MUST BE REVIEWED TO IDENTIFY WHICH ONES CAN BE SEEDED IN PREPARATION FOR THE WINTER RAINS. DISTURBED AREAS MUST BE SEEDED WITHIN ONE WEEK OF THE BEGINNING OF THE WET SEASON. A SKETCH MAP OF THOSE AREAS TO BE SEEDED AND THOSE AREAS TO REMAIN UNCOVERED MUST BE SUBMITTED TO THE PUBLIC WORKS CONSTRUCTION INSPECTOR FOR REVIEW AND APPROVAL.
- 13. DUST GENERATED DURING CONSTRUCTION ACTIVITIES MUST BE CONTROLLED BY WETTING DUST SOURCES SUCH AS AREAS OF EXPOSED SOILS, WASHING TRUCK WHEELS BEFORE THEY LEAVE THE SITE, AND INSTALLING AND MAINTAINING ROCK CONSTRUCTION ENTRANCES. CONTRACTOR MUST MECHANICALLY SWEEP STREETS DAILY WITH VACUUM SWEEPER UNLESS OTHERWISE APPROVED. FLUSHING OF STREETS AND SIDEWALKS WILL NOT BE PERMITTED. A WHEEL-WASH FOR CONSTRUCTION TRAFFIC MUST BE INSTALLED IF REQUIRED BY THE PUBLIC WORKS CONSTRUCTION INSPECTOR. ANY VIOLATIONS OF THE CITY OF BOTHELL MUNICIPAL CODE OR OTHER APPLICABLE REGULATIONS MAY RESULT IN IMPOSING PENALTY FEE.

(CITY OF BOTHELL) STORM DRAINAGE STANDARD NOTES

- ALL DRAINAGE STRUCTURES, SUCH AS CATCH BASINS AND MANHOLES, NOT LOCATED WITHIN A TRAVELED ROADWAY OR SIDEWALK, MUST HAVE SOLID LOCKING LIDS. ALL DRAINAGE STRUCTURES ASSOCIATED WITH A PERMANENT RETENTION/DETENTION FACILITY MUST HAVE SOLID LOCKING LIDS.
- 2. ALL CATCH BASIN GRATES MUST CONFORM TO BOTHELL STANDARD DRAWINGS AND INCLUDE THE STAMPING "OUTFALL TO STREAM, DUMP NO POLLUTANTS" AND "PROPERTY OF CITY OF BOTHELL".
- 3. DEFAULT TO VERTICAL CURB AND GUTTER UNLESS SPECIFIED OTHERWISE ON APPROVED PLANS. SOLID LOCKING LIDS MUST BE USED FOR ALL CATCH BASINS NOT LOCATED WITHIN A GUTTER FLOWLINE AND VANED GRATE STYLE COVERS MUST BE USED WITHIN THE GUTTER FLOWLINE.
- 4. ALL DRIVEWAY CULVERTS LOCATED WITHIN CITY OF BOTHELL RIGHT-OF-WAY MUST BE OF SUFFICIENT LENGTH TO PROVIDE A MINIMUM 3:1 SLOPE FROM THE EDGE OF THE DRIVEWAY TO THE BOTTOM OF THE DITCH. CULVERTS MUST HAVE BEVELED END SECTIONS TO MATCH THE SIDE SLOPE.
- 5. ALL CONVEYANCE PIPE 6-INCHES OR GREATER IN DIAMETER MUST BE ASTM D3034 SDR 35 PVC UNLESS OTHERWISE SHOWN ON THE PLANS AS APPROVED BY THE DIRECTOR OF PUBLIC WORKS.
- 6. APPROVED BEDDING MATERIAL MUST BE 5/8 INCH OF CRUSHED ROCK. IT MUST BE PLACED A MINIMUM OF 6-INCHES UNDER THE PIPE AND TO A DEPTH OF AT LEAST 6-INCHES OVER THE TOP OF THE PIPE. THE BEDDING MATERIALS MUST BE RAMMED AND TAMPED AROUND THE PIPE BY THE USE OF APPROVED HAND-HELD TOOLS SO AS TO PROVIDE FIRM AND UNIFORM SUPPORT OVER THE FULL LENGTH OF ALL PIPE AND JOINTS. EXTRA CARE MUST BE GIVEN TO ENSURE A SMOOTH AND EVEN TRENCH BOTTOM SO THE PIPE IS UNIFORMLY SUPPORTED THROUGHOUT ITS LENGTH. BACKFILL MATERIAL MUST ACHIEVE COMPACTION TO 95% MDD WITHIN THE TRENCH AND FILL AREA.
- 7. STORM DRAIN CROSSINGS AT EXISTING UTILITIES MUST BE INSTALLED TO MAINTAIN 3 FEET MINIMUM COVER AND A MINIMUM OF 1.5 FEET ABOVE OR BELOW THE STORM DRAIN MEASURED AT THE TWO CLOSEST EDGES OF THE PIPES, UNLESS OTHERWISE APPROVED BY THE PUBLIC WORKS DIRECTOR.
- 8. DRAINAGE OUTLETS (STUB-OUTS) MUST BE PROVIDED FOR EACH INDIVIDUAL LOT. STUB-OUTS MUST CONFORM TO THE FOLLOWING:
 - I. EACH OUTLET MUST BE SUITABLY LOCATED AT THE LOWEST ELEVATION ON THE LOT, SO AS TO SERVICE ALL FUTURE ROOF DOWNSPOUTS AND FOOTING DRAINS, DRIVEWAYS, YARD DRAINS, AND ANY OTHER SURFACE OR SUBSURFACE DRAINS NECESSARY TO RENDER THE LOTS SUITABLE FOR THEIR INTENDED USE. EACH OUTLET MUST HAVE FREE-FLOWING, POSITIVE DRAINAGE TO AN APPROVED STORMWATER CONVEYANCE SYSTEM OR TO AN APPROVED OUTFALL LOCATION.
 - II. ENDS OF EACH STORM DRAIN STUB AT THE PROPERTY LINE MUST BE CAPPED AND LOCATED WITH A 2 INCH X 4 INCH BOARD MARKED PLAINLY AND PERMANENTLY "STORM" WITH DEPTH TO PIPE IN FEET AND INCHES, STENCILED IN BLACK LETTERS 2-INCH HIGH.
- 9. FOOTING DRAINS MUST BE PLACED AROUND ALL PERIMETER FOOTINGS. THE FOOTING DRAINAGE SYSTEM MUST BE TIED INTO THE ROOF DRAINAGE SYSTEM AT LEAST 3 FEET FROM, AND BELOW THE BOTTOM OF, THE BUILDING FOUNDATION. ALL PERFORATED DRAINAGE PIPE MUST BE RIGID PVC.
- 10. ALL SINGLE SERVICE BUILDING ROOF DRAIN DOWNSPOUTS AND FOOTING DRAINS MUST BE DIRECTLY CONNECTED TO THE MAIN STORM DRAINAGE CONNECTION VIA A MINIMUM 4-INCH DIAMETER PVC PIPE INSTALLED AT A MINIMUM SLOPE OF 2%.
- 11. MULTIPLE SERVICE ROOF AND FOOTING DRAINS MUST BE MIN. 6-INCH DIAMETER ASTM D3034 SDR 35, INSTALLED AT 2% MIN. SLOPE AND MUST INCLUDE CLEANOUTS WHERE INDIVIDUAL SERVICES CONNECT. NO FITTING MUST BE GREATER THAN 45° (I.E., USE TWO 45° BENDS WITH MINIMUM THREE FEET OF SEPARATION INSTEAD OF A 90° BEND).
- 12. CAST-IN-PLACE CONCRETE STORMWATER FACILITIES MUST HAVE BE SMOOTH WITH NO FINS, VOIDS, ROCK POCKETS, OR OTHER IRREGULARITIES WITH APPROVED WATER STOPS AT ALL CONSTRUCTION JOINTS. CONE SNAP TIES ARE REQUIRED FOR FORMWORK AND ARE TO BE REMOVED AND EPOXY SEALED AT ALL INTERIOR AND EXTERIOR WALL SURFACES. NO FLAT TIES ALLOWED.

BID SET


SHEET SHEET

-2209999\2200224 Park Royal Apartments\C/


CALL TWO BUSINESS
DAYS BEFORE YOU DIG
1-800-424-5555

SCALE:



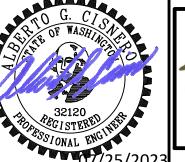



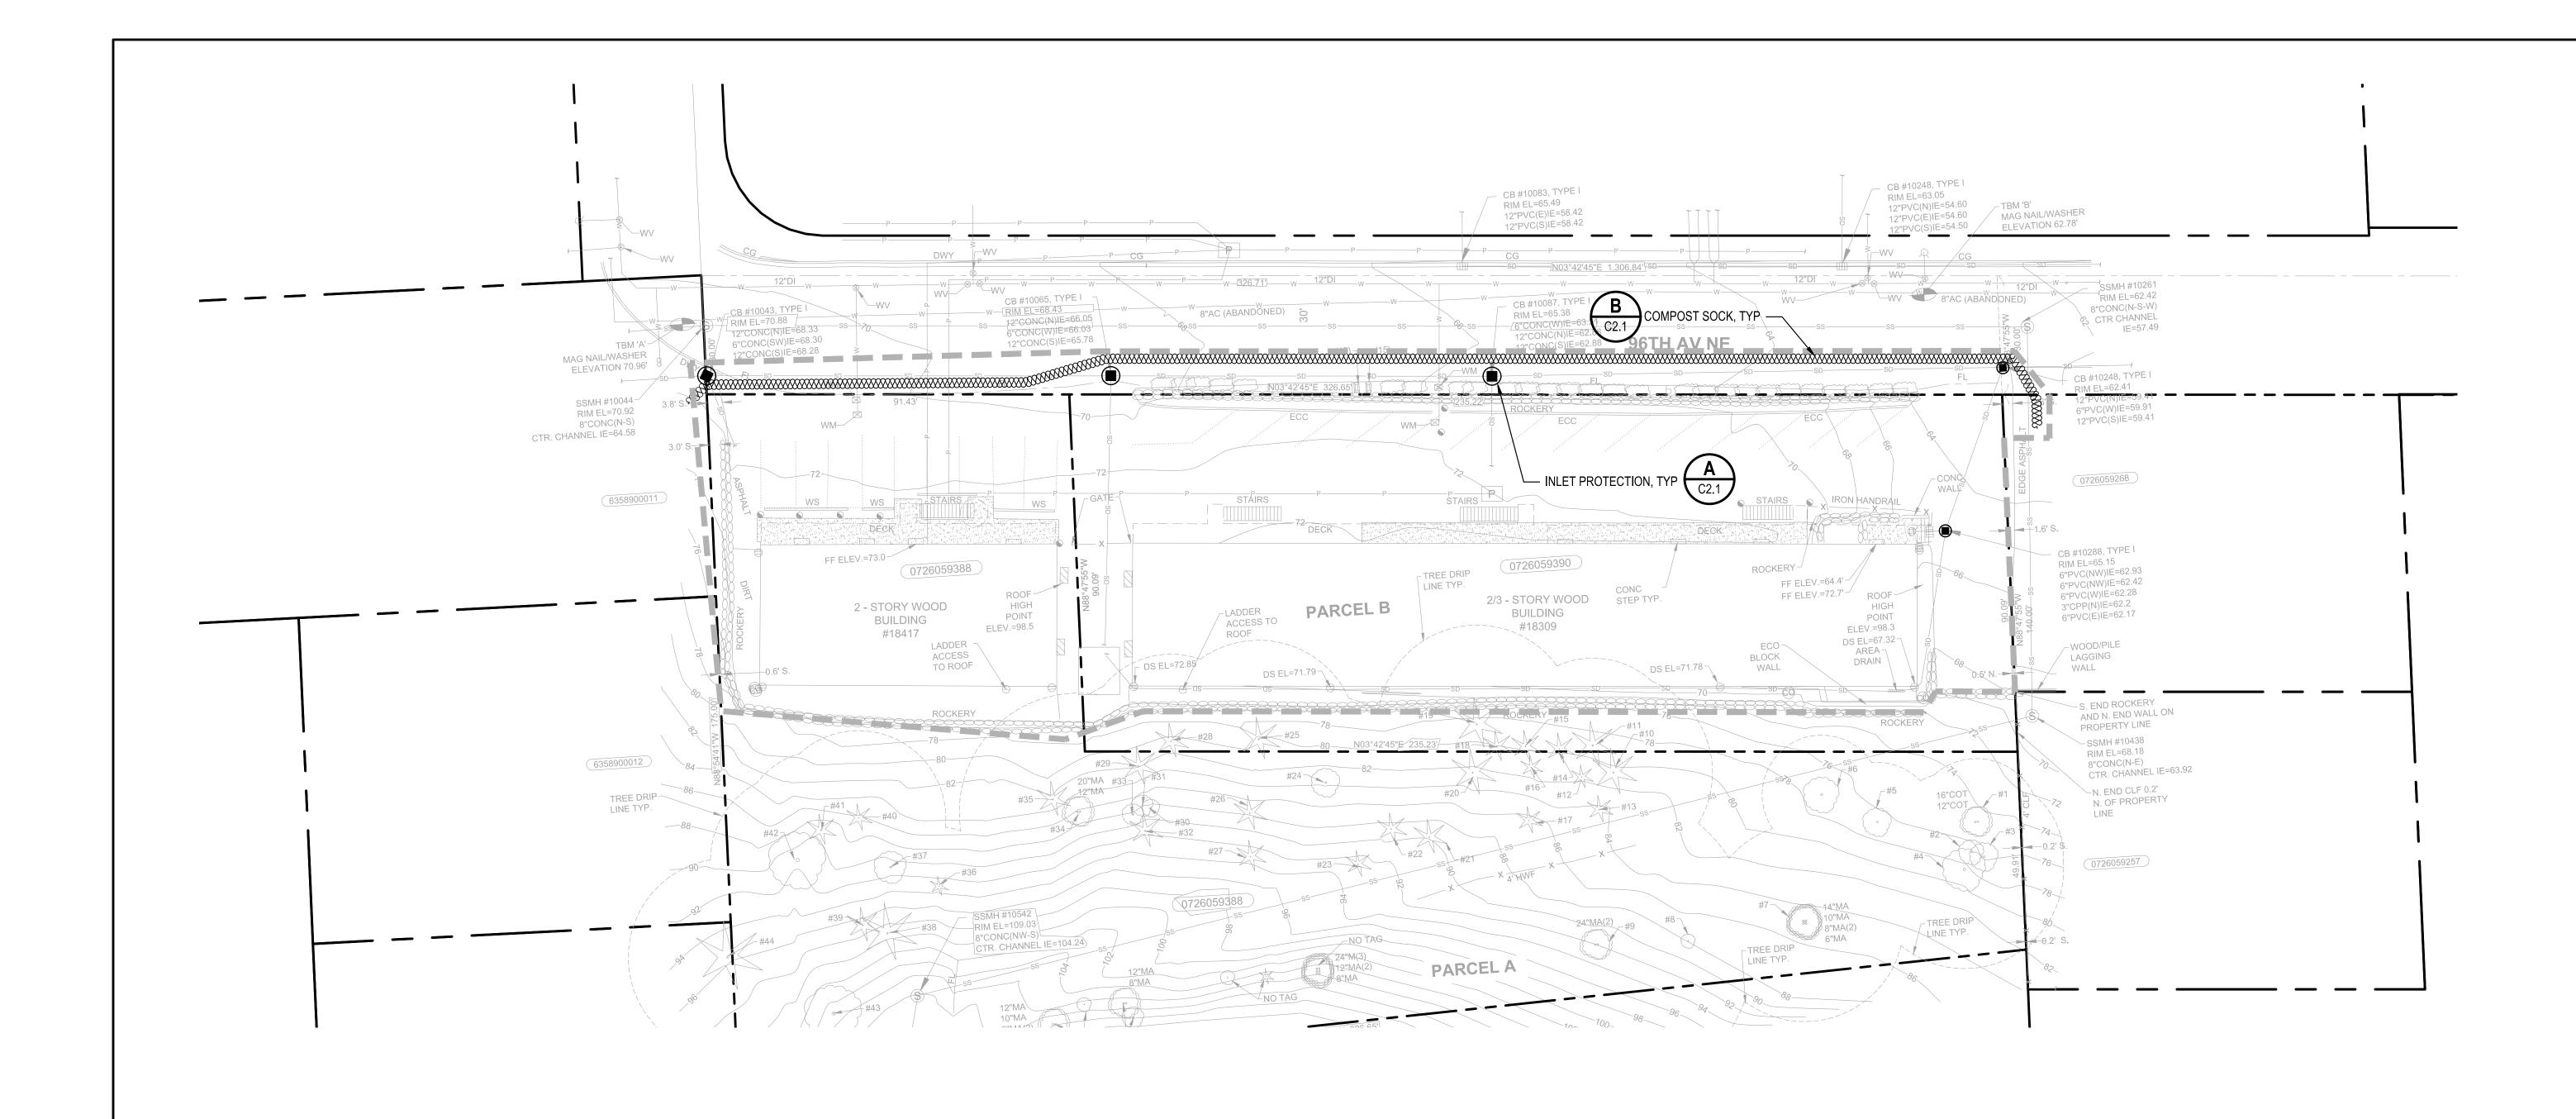




INLET PROTECTION

LIMITS OF WORK


NOTES

- 1. REFER TO CITY OF BOTHELL TESC NOTES ON C1.1
- 2. THIS PLAN IS INTENDED TO REFLECT THE MINIMUM EROSION AND SEDIMENT CONTROL MEASURES REQUIRED FOR THE SITE. THE CONTRACTOR IS RESPONSIBLE FOR UPGRADING THESE MEASURES TO ACCOMODATE SITE CONDITIONS, STORM EVENTS, AND PREVENT SEDIMENT AND SEDIMENT LADEN RUNOFF FROM LEAVING THE SITE.
- 3. CONTRACTOR SHALL COORDINATE ALL CLOSURES AND ENCROACHMENTS INTO CITY OF BOTHELL RIGHT-OF-WAY WITH THE CITY INSPECTOR AND/OR PREPARE AND PROVIDE A TEMPORARY TRAFFIC CONTROL PLAN TO THE CITY OF BOTHELL PUBLIC WORKS DEPARTMENT FOR REVIEW AND APPROVAL IN A TIMELY MANNER TO NOT AFFECT THE PROJECT SCHEDULE.



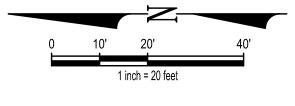

						DRAWN BY	DESIGNED BY	
						CEP	SRJ	(CALL
						CHECKED BY	APPROVED BY	l pyve i
						AGC	AGC	
						DA		
						07/25	/2023	
NO.	DATE	BY	CHD.	APPR.	REVISION	JOB No.:	2200224	

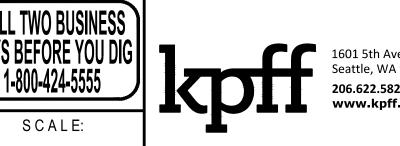

SCALE:






PARK ROYAL SITE
BOTHELL, WASHINGTON

SHEET


TESC PLAN

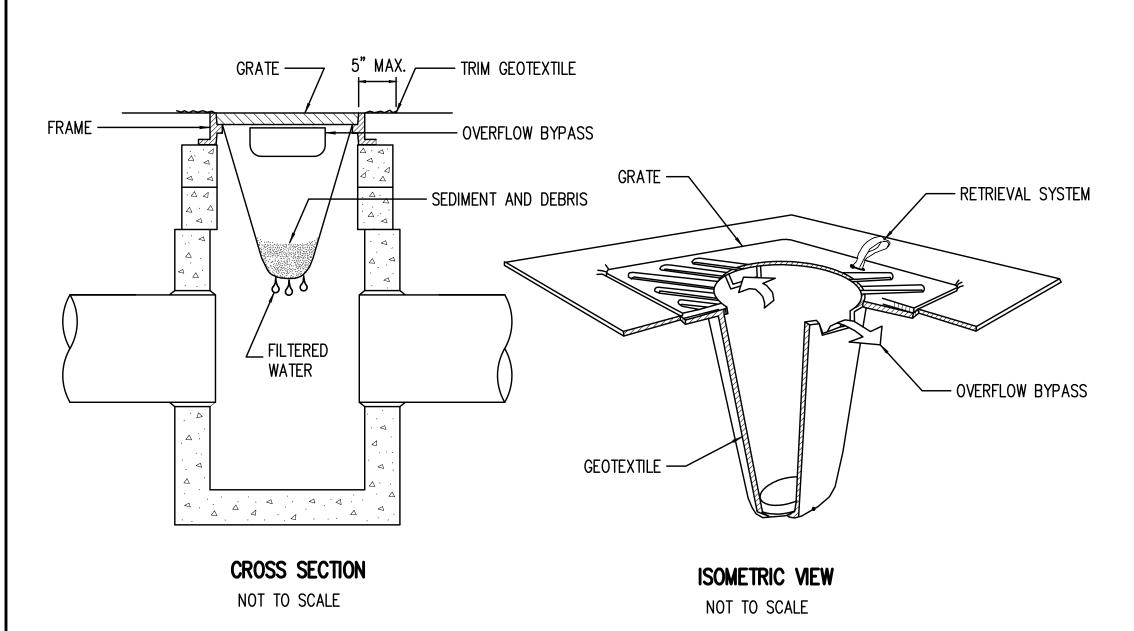

NOTES:

- 1. REMOVE INLET PROTECTION AT THE END OF THE JOB.
- 2. INLET PROTECTION IS TO BE SIZED AND INSTALLED IN DRAINAGE DEVICES PER THE MANUFACTURER'S RECOMMENDATIONS. CATCH BASIN INSERTS ARE NOT TO BE INSTALLED IN CURB INLETS.
- 3. INSERTS SHALL BE INSPECTED AND MAINTAINED WHEN A 1/2 INCH RAIN ACCUMULATES WITHIN A 24 HOUR PERIOD. CLEAN AND/OR REPLACE INSERT WHEN HALF OF THE TRAP IS FILLED WITH SEDIMENTS.




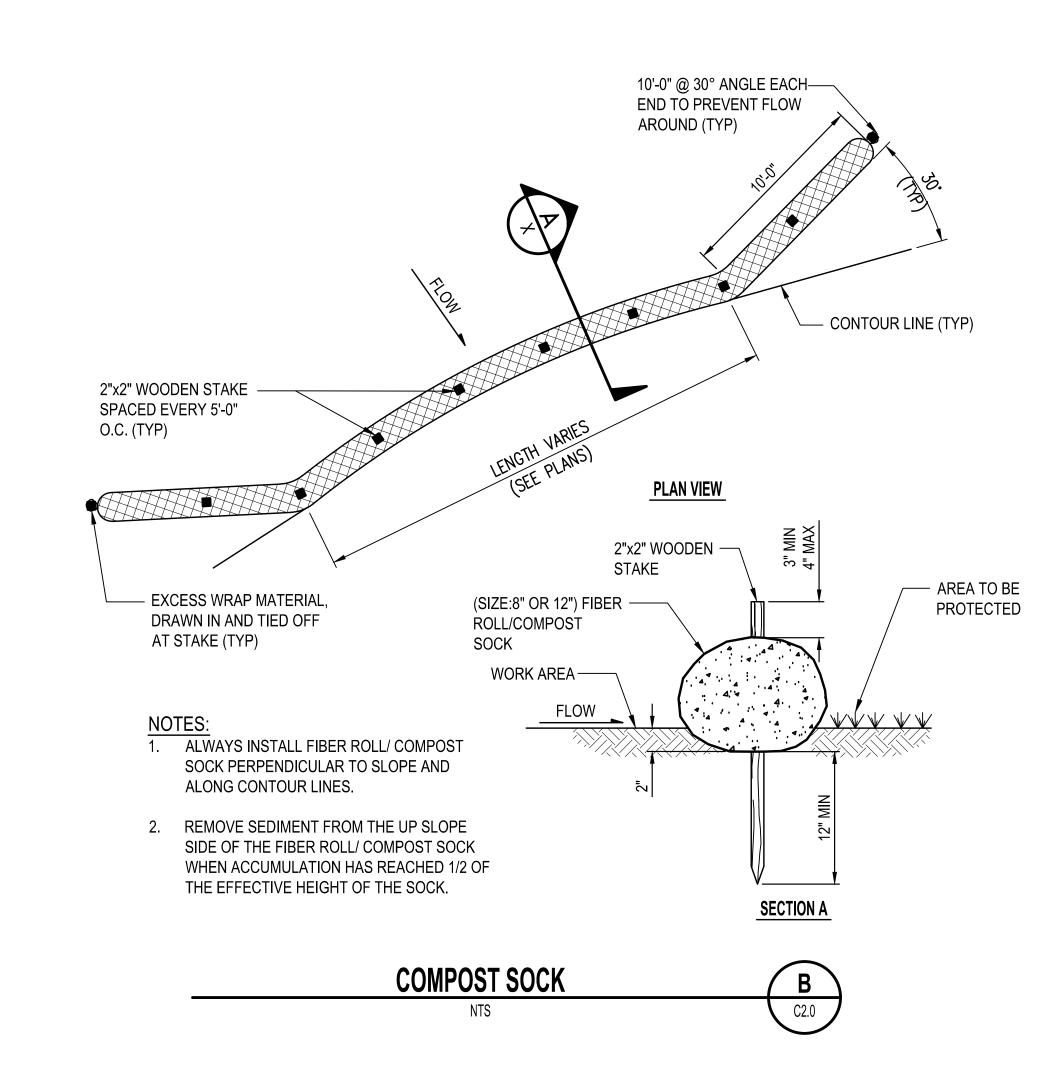


BID SET

CALL TWO BUSINESS DAYS BEFORE YOU DIG 1-800-424-5555 SCALE:



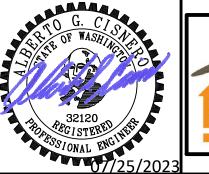



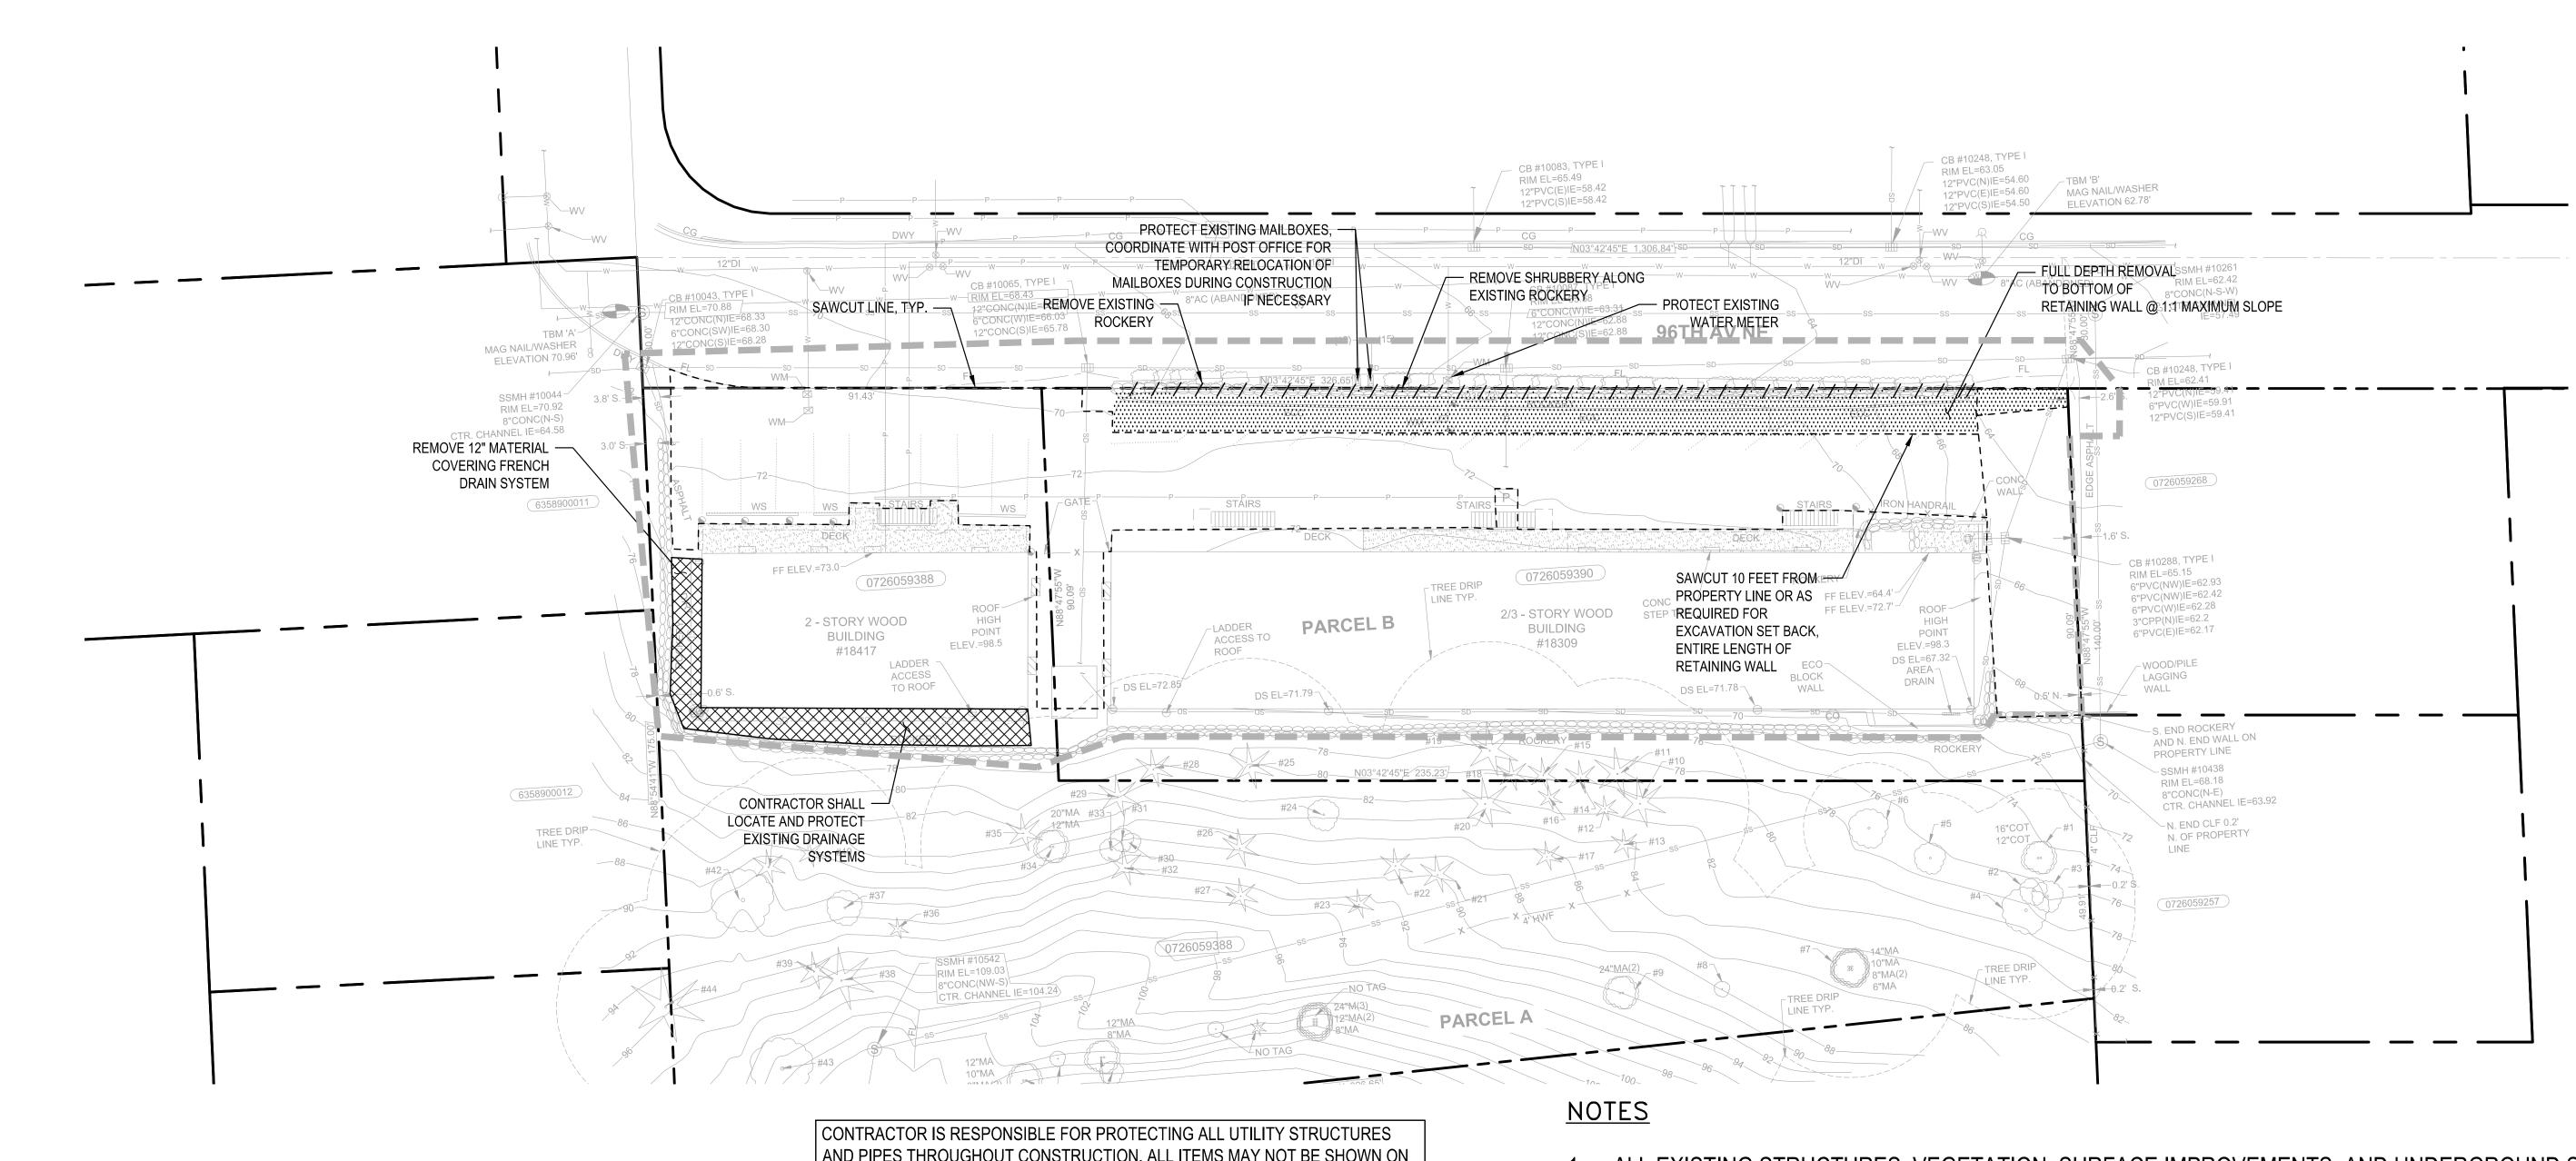

LEGEND

LIMITS OF WORK

REMOVE EXISTING ROCKERY

REMOVE EXISTING MATERIAL

FULL DEPTH REMOVAL


SAWCUT LINE

CONTRACTOR IS RESPONSIBLE FOR PROTECTING ALL UTILITY STRUCTURES AND PIPES THROUGHOUT CONSTRUCTION. ALL ITEMS MAY NOT BE SHOWN ON THE SURVEY, CONTRACTOR IS RESPONSIBLE FOR POTHOLING AND LOCATING ALL UTILITIES PRIOR TO BEGINNING DEMOLITION WORK. CONTRACTOR TO NOTIFY THE ENGINEER OF ANY CONFLICTS WITH PROPOSED IMPROVEMENTS.

CONTRACTOR TO NOTE EXISTING TYPE OF LANDSCAPING IN THE RIGHT-OF-WAY FOR REPLACEMENT AT END OF PROJECT AS NOTED IN SHEET C6.0.

- 1. ALL EXISTING STRUCTURES, VEGETATION, SURFACE IMPROVEMENTS, AND UNDERGROUND STRUCTURES/UTILITIES WITHIN THE DEMOLITION LIMITS SHALL BE PROTECTED UNLESS NOTED OTHERWISE.
- 2. DEMOLITION SHALL BE IN CONFORMANCE WITH APPLICABLE REGULATION, CODES, AND DEMOLITION PERMIT REQUIREMENTS.
- 3. CONTRACTOR SHALL PROVIDE TRAFFIC AND PEDESTRIAN REROUTES AS NECESSARY TO COMPLETE THE WORK, AND OBTAIN APPROVAL FROM THE CITY PRIOR TO BEGINNING WORK. MAINTAIN PEDESTRIAN AND VEHICULAR ACCESS FOR ADJACENT PROPERTIES THROUGHOUT CONSTRUCTION.
- 4. PROTECT AND MAINTAIN UNINTERRUPTED UTILITY SERVICE TO EXISTING NEIGHBORING BUILDINGS DURING DEMOLITION AND CONSTRUCTION.
- 5. ALL DISTURBED PAVEMENT IN THE PUBLIC RIGHT OF WAY SHALL BE REPLACED PER CITY OF BOTHELL STANDARD DETAIL 310.
- 6. ANY DAMAGE RESULTING FROM PROJECT ACTIVITIES TO EXISTING IMPROVEMENTS OR VEGETATION OUTSIDE OF WORK INDICATED ON PLAN SHALL BE REPAIRED/REPLACED IN KIND AT CONTRACTOR'S EXPENSE. CONTRACTOR SHALL CONSIDER DOCUMENTING EXISTING IMPROVEMENTS PRIOR TO BEGINNING CONSTRUCTION.
- 7. CONTRACTOR SHALL OBTAIN NECESSARY PERMITS TO EXECUTE DEMOLITION, INCLUDING PERMIT TO USE PUBLIC WATER SUPPLY IF NEEDED FOR CONSTRUCTION.

BID SET

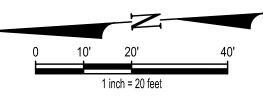

						DRAWN BY	DESIGNED BY	
						CEP	SRJ	CAL
						CHECKED BY	APPROVED BY	אח 🏿
						AGC	AGC	UAY
						DA [*]		
						07/25	2023	
						LOD No.	2200224	
NO.	DATE	BY	CHD.	APPR.	REVISION	JOB No.:	2200224	










PARK ROYAL SITE BOTHELL, WASHINGTON

C2 0

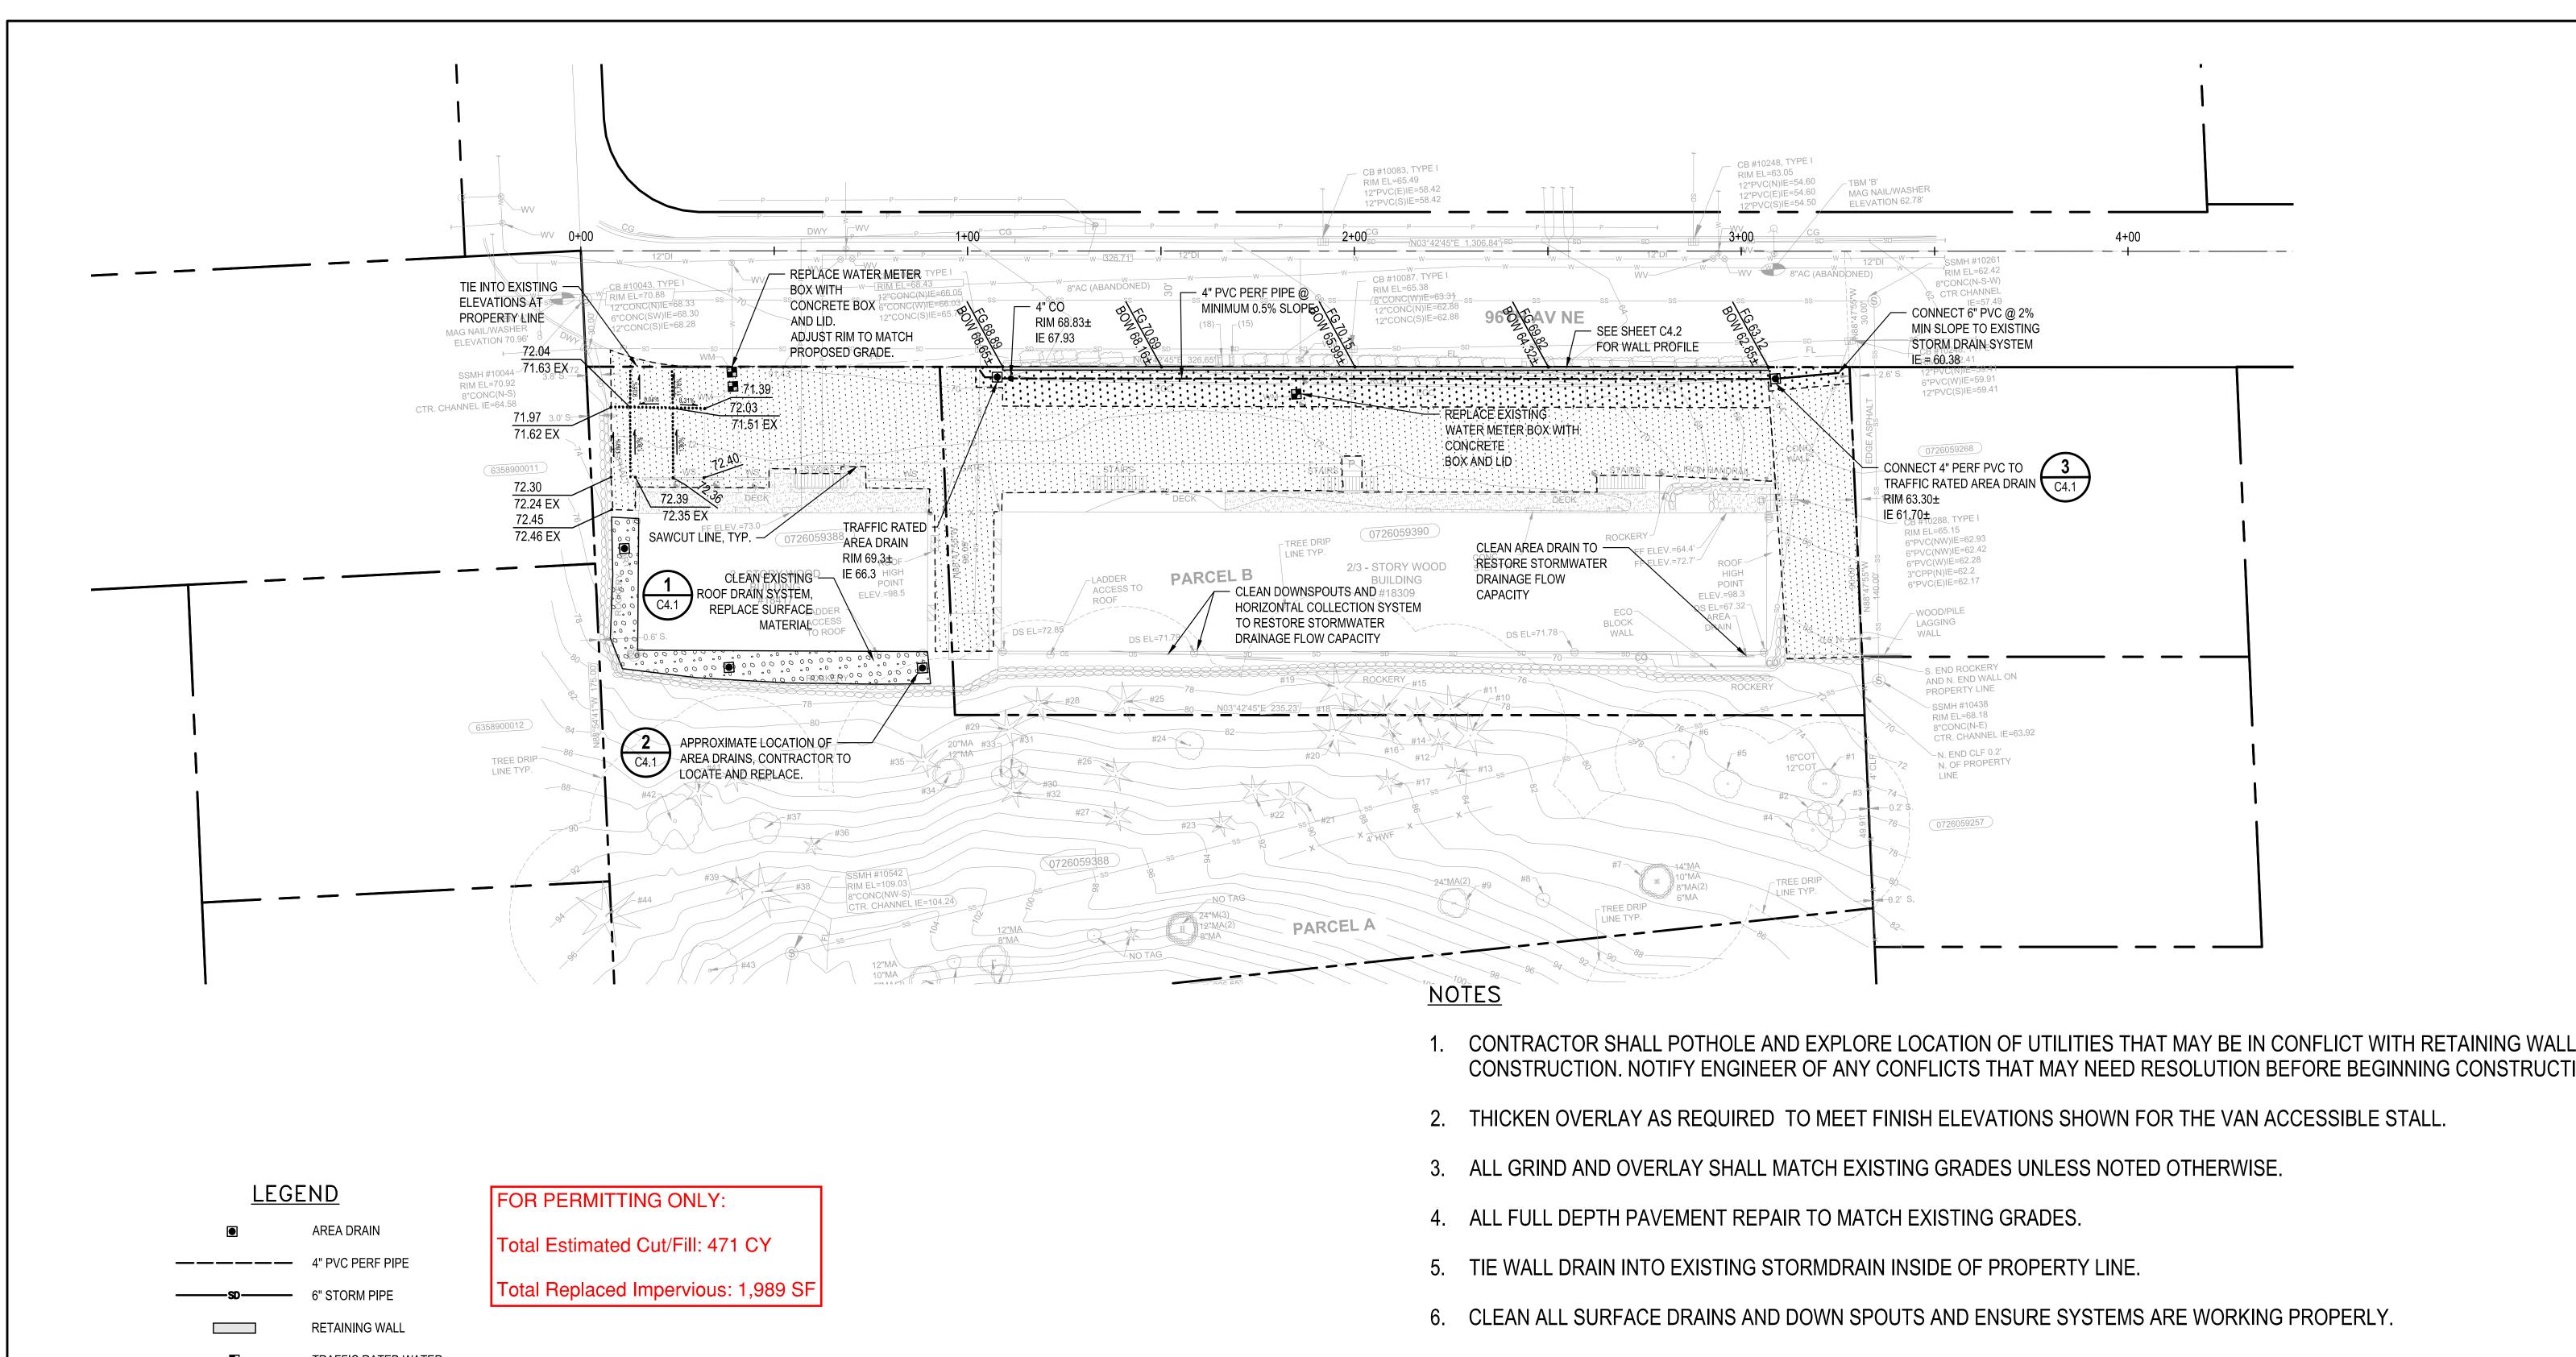

TRAFFIC RATED WATER METER STRUCTURE

ASPHALT GRIND AND OVERLAY FULL DEPTH ASPHALT PAVING

BID SET

CONSTRUCTION. NOTIFY ENGINEER OF ANY CONFLICTS THAT MAY NEED RESOLUTION BEFORE BEGINNING CONSTRUCTION.

6. CLEAN ALL SURFACE DRAINS AND DOWN SPOUTS AND ENSURE SYSTEMS ARE WORKING PROPERLY.


7. BOTTOM OF WALL (BOW) ELEVATIONS ARE NOTED WHERE THE FACE OF BLOCK WALL MEETS THE EXISTING ROAD SURFACE. FINISH GRADE (FG) ELEVATIONS ARE WHERE THE ASPHALT PAVING MEETS THE CONCRETE WALL. REFER TO THE GEOTECHNICAL LETTER DATED MAY 10, 2023 FOR THE EMBEDMENT REQUIREMENTS OF THE BLOCK WALL. REFER TO C4.2 AND S4.01 FOR THE WALL PROFILE AND DETAILS FOR WALL COVERAGES, WALL HEIGHT ABOVE THE PAVEMENT SURFACE, AND HANDRAIL REQUIREMENTS.

PROTECT ALL EXISTING UTILITIES IN THE AREA. CONTRACTOR IS RESPONSIBLE FOR REPLACING ALL DAMAGED UTILITIES.

9. PRIOR TO BEGINNING CONSTRUCTION, THE CONTRACTOR IS RESPONSIBLE FOR COORDINATING WITH WATER PROVIDER WITH AT MINIMUM 1 WEEK ADVANCE NOTICE FOR ANY SERVICE DISRUPTION TO THE WATER METER, INCLUDING ANY MODIFICATIONS TO THE SYSTEM TO ACCOMMODATE THE NEW WALL AND IMPROVEMENTS. CONTRACTOR IS RESPONSIBLE FOR ALL COSTS AND INSPECTION FEES ASSOCIATED WITH THE WATER METER MODIFICATIONS.


						DRAWN BY	DESIGNED BY	
						CEP	SRJ	CALL TWO B
						CHECKED BY	APPROVED BY	DAYS BEFOR
						AGC	AGC	
						DA		1-800-424
						07/25	/2023	SCAI
						I LODNA.	2200224	SCAL
NO.	DATE	BY	CHD.	APPR.	REVISION	JOB No.:	2200224	



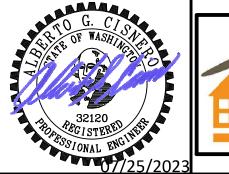





PARK ROYAL SITE **BOTHELL, WASHINGTON**

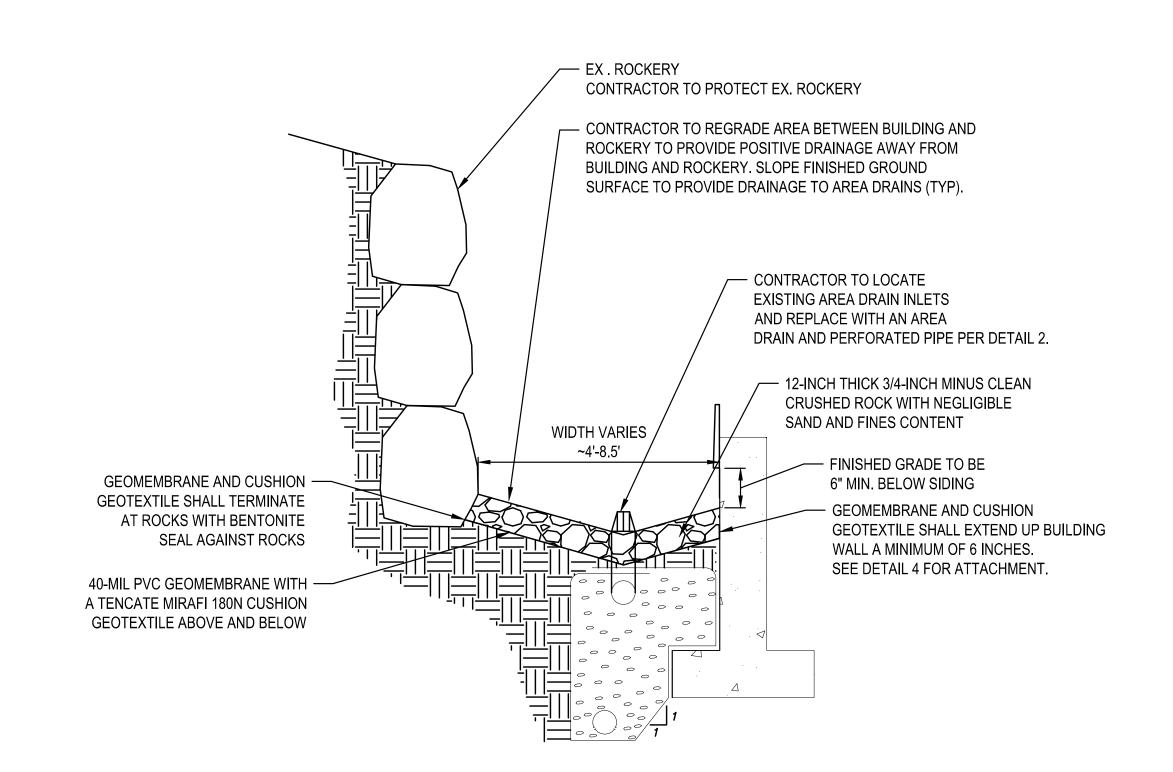


TYPICAL TRENCH SECTION

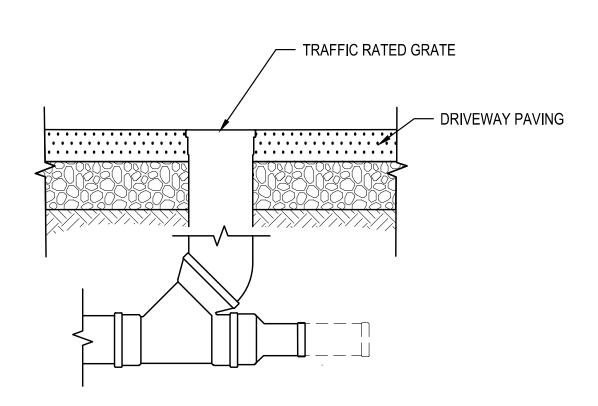

TRAFFIC RATED AREA DRAIN

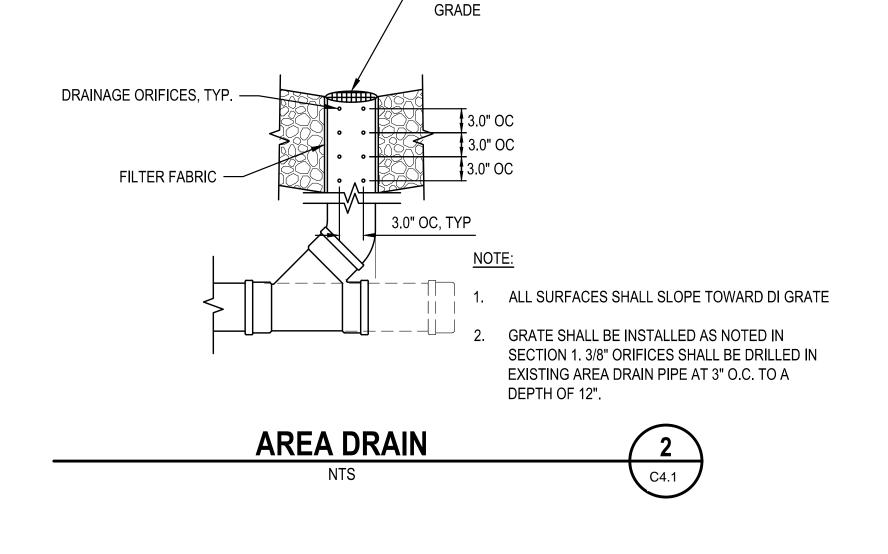

— DI GRATE AT

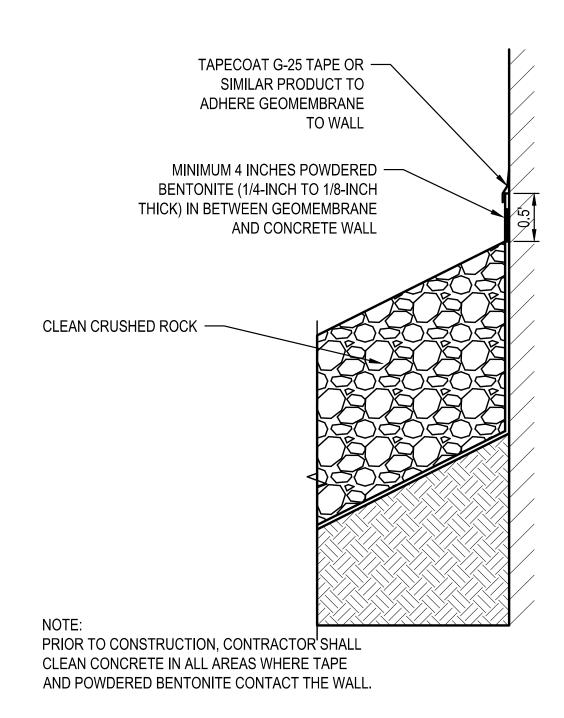


GEOMEMBRANE WALL ATTACHMENT




BID SET

PARK ROYAL SITE SHEET **BOTHELL, WASHINGTON**

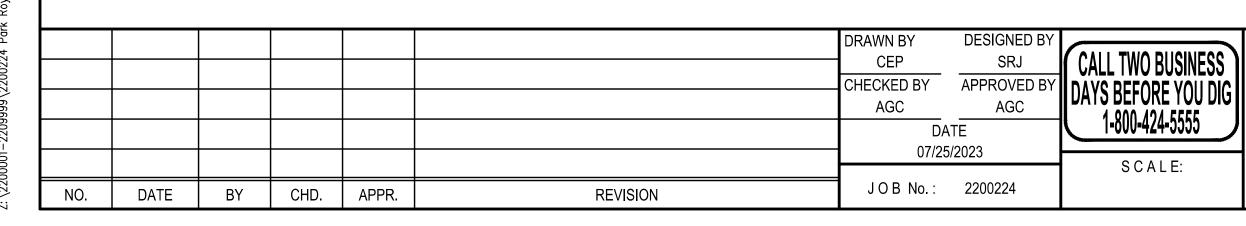




C4.1

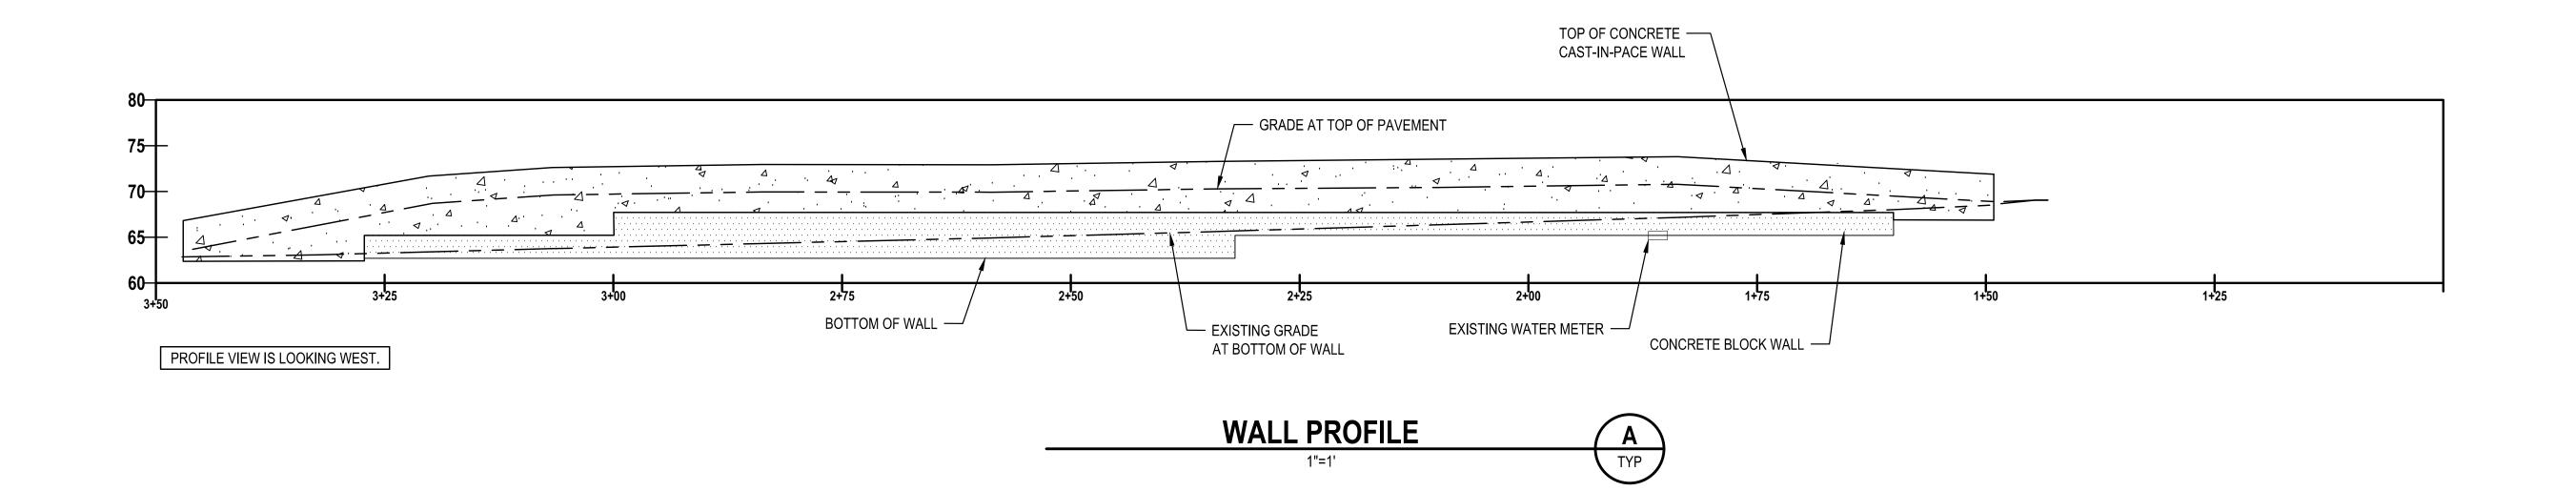

<u>LEGEND</u>

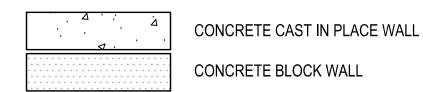

<u>NOTES</u>

- 1. HYBRID WALL TO BE CONSTRUCTED WITH CONCRETE BLOCK AND CONCRETE CAST IN PLACE MATERIALS.
- 2. CONCRETE BLOCK WALL CONSTRUCTION SHALL BE IN ACCORDANCE WITH MANUFACTURER REQUIREMENTS.
- 3. CONCRETE CAST IN PLACE WALL TO BE CONSTRUCTED IN ACCORDANCE WITH STRUCTURAL SHEET S4.01.
- 4. AREAS NOTED IN THE PROFILE FOR CONCRETE CAST-IN-PLACE WALL AND CONCRETE BLOCK WALL IS ONLY A GENERAL REPRESENTATION OF DIFFERENT WALL COVERAGES. CONTRACTOR SHALL PREPARE HIS/HER OWN WALL COVERAGE TO ENSURE GEOTECHNICAL RECOMMENDATIONS AND STRUCTURAL WALL DETAILS ARE INCLUDED AND FOLLOWED.
- 5. WALL FACE TO BE ALIGNED WITH PROPERTY LINE.

BID SET

PARK ROYAL SITE

BOTHELL, WASHINGTON

WALL PROFILE

DRAWN BY CEP SRJ APPROVED BY AGC AGC 1-800-424-5555 DAYS BEFORE YOU DIG 1-800-424-5555

Jul 25, 2023 — 10:41am Z:\2200001—220999\2200224 Park Roval Abartments\CADD\Desian\C4

C4.2

SUBMITTALS
SHOP DRAWINGS SHALL BE SUBMITTED TO THE ENGINEER PRIOR TO ANY FABRICATION OR CONSTRUCTION FOR ALL STRUCTURAL ITEMS, INCLUDING THE FOLLOWING: CONCRETE OR MASONRY REINFORCEMENT, PRECAST OR PRESTRESSED CONCRETE ITEMS, EMBEDDED STEEL ITEMS, STRUCTURAL STEEL, STEEL JOISTS, STEEL DECK, SHEAR STUD LAYOUT, METAL GRATING, GLUED-LAMINATED MEMBERS, CLADDING PANELS AND STAIRS.

IF THE SHOP DRAWINGS DIFFER FROM OR ADD TO THE DESIGN OF THE STRUCTURAL DRAWINGS, THEY SHALL BEAR THE SEAL AND SIGNATURE OF THE WASHINGTON STATE REGISTERED PROFESSIONAL ENGINEER WHO IS RESPONSIBLE FOR THE DESIGN.

SPECIAL INSPECTION PER IBC CHAPTER 17 SHALL BE PERFORMED BY AN APPROVED TESTING AGENCY. ALL PREPARED SOIL-BEARING SURFACES SHALL BE INSPECTED BY THE GEOTECHNICAL ENGINEER PRIOR TO PLACEMENT OF ULTRA BLOCK WALL OR REINFORCING STEEL. SOIL COMPACTION SHALL BE SUPERVISED BY AN APPROVED TESTING AGENCY OR GEOTECHNICAL ENGINEER.

SPECIAL CONDITIONS
CONTRACTOR SHALL VERIFY ALL LEVELS, DIMENSIONS, AND EXISTING CONDITIONS IN THE FIELD BEFORE PROCEEDING.

CONTRACTOR SHALL VERIFY ALL EXISTING CONDITIONS BEFORE COMMENCING ANY DEMOLITION. CONTRACTOR SHALL PROVIDE ADEQUATE SHORING AND BRACING OF ALL STRUCTURAL MEMBERS, EXISTING CONSTRUCTION AND SOIL EXCAVATIONS, AS REQUIRED. AND IN A MANNER SUITABLE TO THE WORK SEQUENCE. TEMPORARY SHORING AND BRACING SHALL NOT BE REMOVED UNTIL ALL FINAL CONNECTIONS HAVE BEEN COMPLETED IN ACCORDANCE WITH THE DRAWINGS AND MATERIALS HAVE ACHIEVED DESIGN STRENGTH.

CONTRACTOR SHALL BE RESPONSIBLE FOR ALL SAFETY PRECAUTIONS AND THE METHODS, TECHNIQUES, SEQUENCES OR PROCEDURES REQUIRED TO PERFORM THE WORK.

SEE THE GEOTECHNICAL RECOMMENDATIONS BY GEOENGINEERS, DATED 5/10/2023, FOR MORE COMPLETE INFORMATION. EARTHWORK MATERIAL, BACKFILL AND COMPACTION SHALL BE IN ACCORDANCE WITH THE RECOMMENDATIONS OF THE GEOTECHNICAL RECOMMENDATIONS. BACKFILL BEHIND WALLS SHALL NOT BE PLACED BEFORE THE WALLS AND SUPPORTING SLABS ACHIEVE 28 DAY CONCRETE STRENGTH OR THE WALLS ARE TEMPORARILY BRACED. ALL TOPSOIL ORGANICS AND LOOSE SURFACE SOIL SHALL BE REMOVED FROM BENEATH FILL SUPPORTING CONCRETE SLABS OR PAVING.

CONCRETE

CONCRETE WORK SHALL CONFORM TO ALL REQUIREMENTS OF IBC CHAPTER 19.

CONCRETE MIXTURES SHALL CONFORM TO THE FOLLOWING REQUIREMENTS:

F'c=4,500 PSI @ 28 DAYS MAX AGGREGATE SIZE=1"

MAX W/C RATIO=0.45

EXPOSURE CLASS= F2, S0, W0, C0

CONCRETE MIXTURES SHALL CONFORM TO THE MOST STRINGENT REQUIREMENTS FOR EXPOSURE CLASSES SPECIFIED IN THE TABLE ABOVE AND ACI 318 TABLE 19.3.2.1.

WATER-REDUCING ADMIXTURES MAY BE INCORPORATED IN CONCRETE MIX DESIGNS, BUT SHALL CONFORM TO ASTM C 494, AND BE USED IN STRICT ACCORDANCE WITH THE MANUFACTURER'S RECOMMENDATIONS. CaCl2 OR OTHER WATER-SOLUBLE CHLORIDE ADMIXTURES SHALL NOT BE USED.

WATER/CEMENTITIOUS MATERIALS RATIO SHALL BE MEASURED BY WEIGHT AND SHALL BE BASED ON THE TOTAL CEMENTITIOUS MATERIAL. WATER/CEMENTITIOUS MATERIALS RATIO AND WATER CONTENT SHALL BE DETERMINED BY THE SUPPLIER BASED ON STRENGTH REQUIREMENTS AND SHALL NOT EXCEED THE MAXIMUM WATER/CEMENTITIOUS MATERIAL RATIO AND/OR WATER CONTENT IF SHOWN ABOVE OR IN ACI 318 TABLE 19.3.2.1 FOR THE EXPOSURE CLASSES LISTED.

FIELD-MEASURED SLUMP SHALL CONFORM TO THE SUBMITTED CONCRETE MIX DESIGN. TOLERANCE OF SLUMP SHALL CONFORM TO ASTM C 94.

ALL CONCRETE SUBJECT TO EXPOSURE CLASSES F1, F2 OR F3 SHALL BE AIR ENTRAINED. AIR-ENTRAINING AGENTS SHALL CONFORM TO ASTM C 260. THE PERCENTAGE OF TOTAL AIR SHALL BE ACCORDING TO ACI 318 TABLE 19.3.3.1 WITH A FIELD TOLERANCE OF ±1.5 PERCENT BY VOLUME. THE PERCENTAGE OF TOTAL AIR SHALL BE MEASURED IN THE FIELD AT THE DISCHARGE FROM THE TRUCK.

THE CONTRACTOR SHALL SUBMIT CONCRETE MIX DESIGNS OR A SDCI CONTINUOUSLY APPROVED CONCRETE MIX FOR APPROVAL 2 WEEKS PRIOR TO PLACING ANY CONCRETE. THE MIX DESIGN SHALL BE IN CONFORMANCE WITH ACI 318, CHAPTER 19. CONTINUOUS APPROVED MIXTURES SHALL CONFORM TO SDCI DIRECTOR'S RULE 13-2014. THE SUBMITTAL SHALL INDICATE WHERE EACH CONCRETE MIX IS TO BE USED ON THE PROJECT, AS WELL AS THE MAXIMUM AGGREGATE SIZE OF EACH MIX.

CURING

IF THE AIR TEMPERATURE WILL EXCEED 75 DEGREES F WITHIN 48 HOURS OF PLACING CONCRETE, A MOIST CURE SHALL BE APPLIED TO THE CONCRETE FOR A PERIOD OF 36 HOURS AFTER FINISHING CONCRETE SURFACES. REFER TO THE PROJECT SPECIFICATIONS FOR CURING REQUIREMENTS.

ASTM A 615, GRADE 60

REINFORCING SHALL BE SUPPORTED AS SPECIFIED BY THE CRSI MANUAL OF STANDARD PRACTICE. REINFORCING STEEL SHALL BE DETAILED IN ACCORDANCE WITH ACI STANDARD OF PRACTICE AS OUTLINED IN ACI 315, "GUIDE TO PRESENTING REINFORCING STEEL DESIGN DETAILS".

LAP ALL REINFORCING BARS AS NOTED ON THE DRAWINGS. WHERE SPLICE LENGTH IS NOT SHOWN, PROVIDE A 2'-0" SPLICE.

ANCHORS


PROVIDE POST-INSTALLED ANCHORS AS SPECIFIED

ANCHOR EMBEDMENT DEPTHS LISTED SHALL BE CONSIDERED EFFECTIVE EMBEDMENT DEPTHS AS DEFINED IN THE ICC-ES OR IAPMO UES EVALUATION REPORTS. PROVIDE ANCHOR LENGTH AND HOLE PER EVALUATION REPORT TO ACCOMMODATE THE EFFECTIVE EMBEDMENT SPECIFIED IN THESE DRAWINGS.

MECHANICAL AND ADHESIVE ANCHORS SHALL BE ZINC PLATED CARBON STEEL UNLESS NOTED OTHERWISE. MECHANICAL AND ADHESIVE ANCHORS EXPOSED TO WEATHER SHALL

DO NOT DAMAGE EXISTING REINFORCEMENT. IF LOCATION OF REINFORCEMENT IS UNKNOWN, SCAN FOR EXISTING REINFORCING STEEL PRIOR TO DRILLING.

USE OF ALTERNATE PRODUCTS, OR OF POST-INSTALLED ANCHORS AT LOCATIONS NOT SHOWN IN THESE DRAWINGS, IS SUBJECT TO THE APPROVAL OF THE ARCHITECT. SUBMIT PROPOSED ANCHORS TO THE ARCHITECT WITH AN ICC-ES OR IAPMO UES REPORT VALID FOR THE 2018 IBC AND DOCUMENTATION SHOWING THAT THE ALTERNATE PRODUCTS PROVIDE EQUIVALENT CAPACITY FOR ALL CONDITIONS IN THIS PROJECT. DOCUMENTATION OF CAPACITY FOR ALTERNATE PRODUCTS MUST BE INCLUDED AS A DEFERRED SUBMITTAL

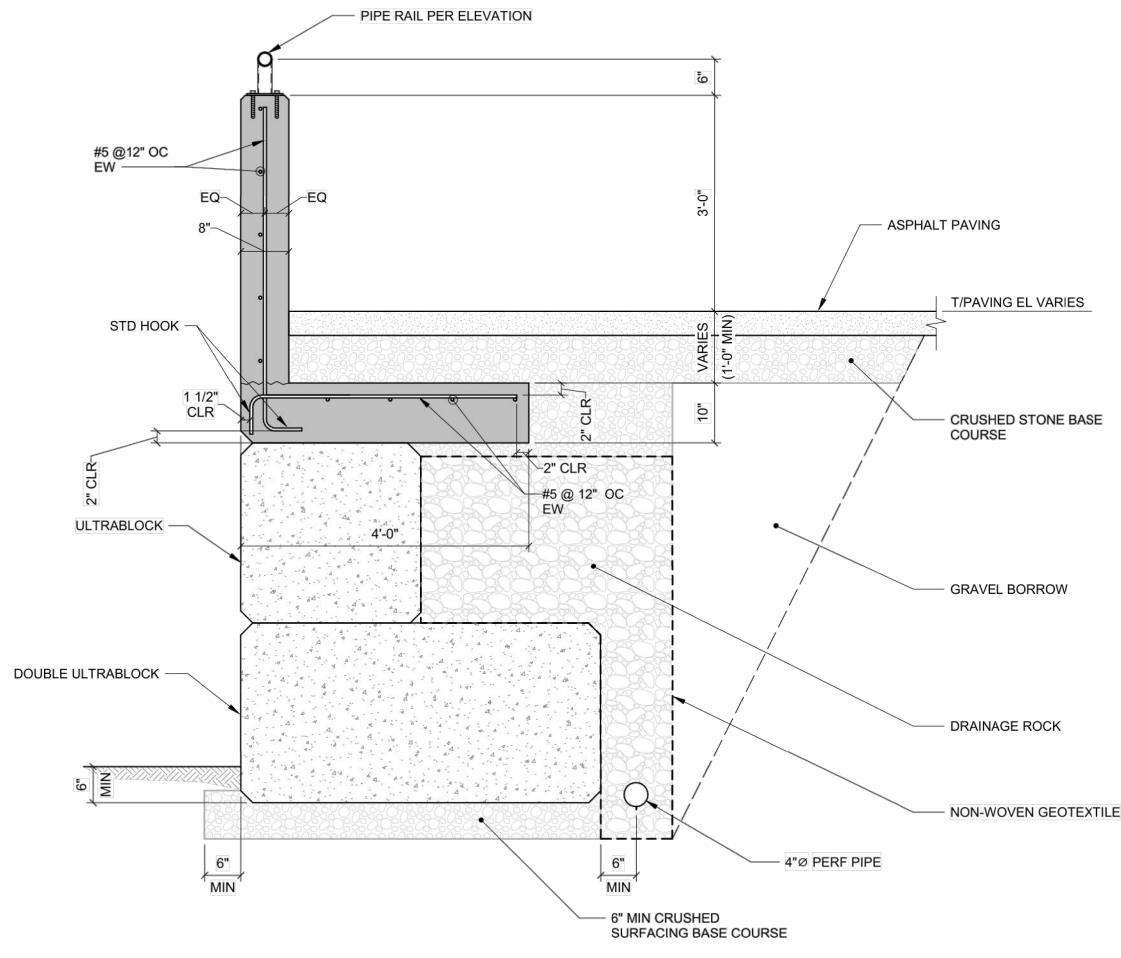


1. DESIGN OF ULTABLOCK WALL IS BY THE GEOTECHNICAL ENGINEER. SEE GEOTECHNICAL

RECOMMENDATIONS FOR ADDITIONAL INFORMATION. 2. PROVIDE SLIP JOINT IN PIPE RAIL @ 10'-0" OC. LOCATE 1/2 DISTANCE BETWEEN EVERY

OTHER POST AND ALIGN WITH VERTICAL CONTROL JOINTS IN WALL. 3. WALL VERTICAL CONTROL JOINTS, WITH 1/2" PREMOLDED JOINT FILLER, SHALL BE SPACED AT 30'-0" OC MAXIMUM. ALIGN WITH JOINTS IN ULTRABLOCK WALL.

CANTILEVERED HYBRID WALL DETAIL 3/4" = 1'-0"

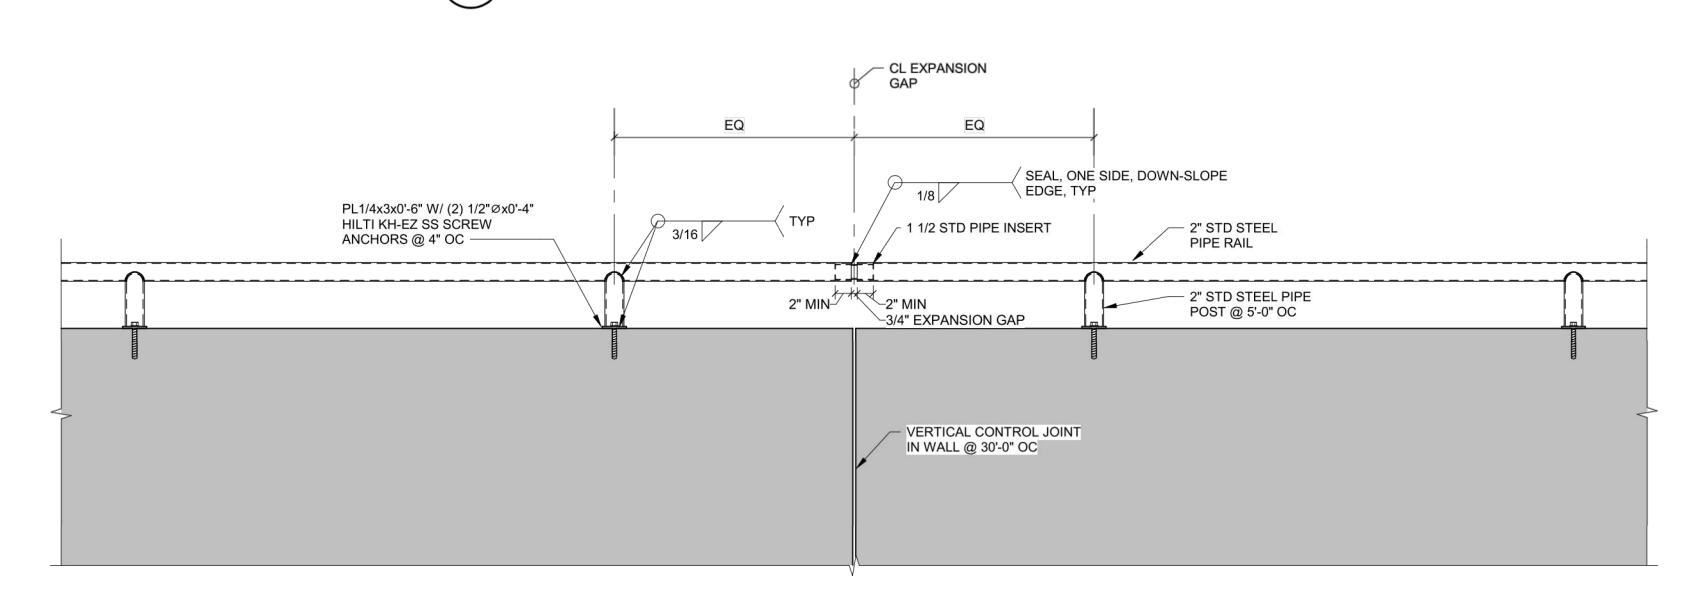

RAILING MUST BE HOT DIP GALVANIZED AFTER FABRICATION. 2. ALL POSTS MUST BE PLUMB AND RAILS PARALLEL TO GRADE.

PIPE MEATERIAL MUST CONFORM TO ASTM A53. 4. PLACE EXPANSION GAP AT EVERY OTHER PANEL (10'-0" MAX SPACING - BETWEEN EVERY OTHER POST). ALIGN WITH VERTICAL CONTROL JOINT WHERE THEY OCCUR.

BID SET

STRUCTURAL DETAILS

PARK ROYAL SITE SHEET **BOTHELL, WASHINGTON**

BY

CHD.

DESIGNED E DRAWN BY NAS CHECKED BY APPROVED B NAS NAS DATE 07/21/2023

REVISION

J O B No.: 2200224





AS NOTED


1601 5th Avenue, Suite 1600 Seattle, WA 98101 206.622.5822 www.kpff.com





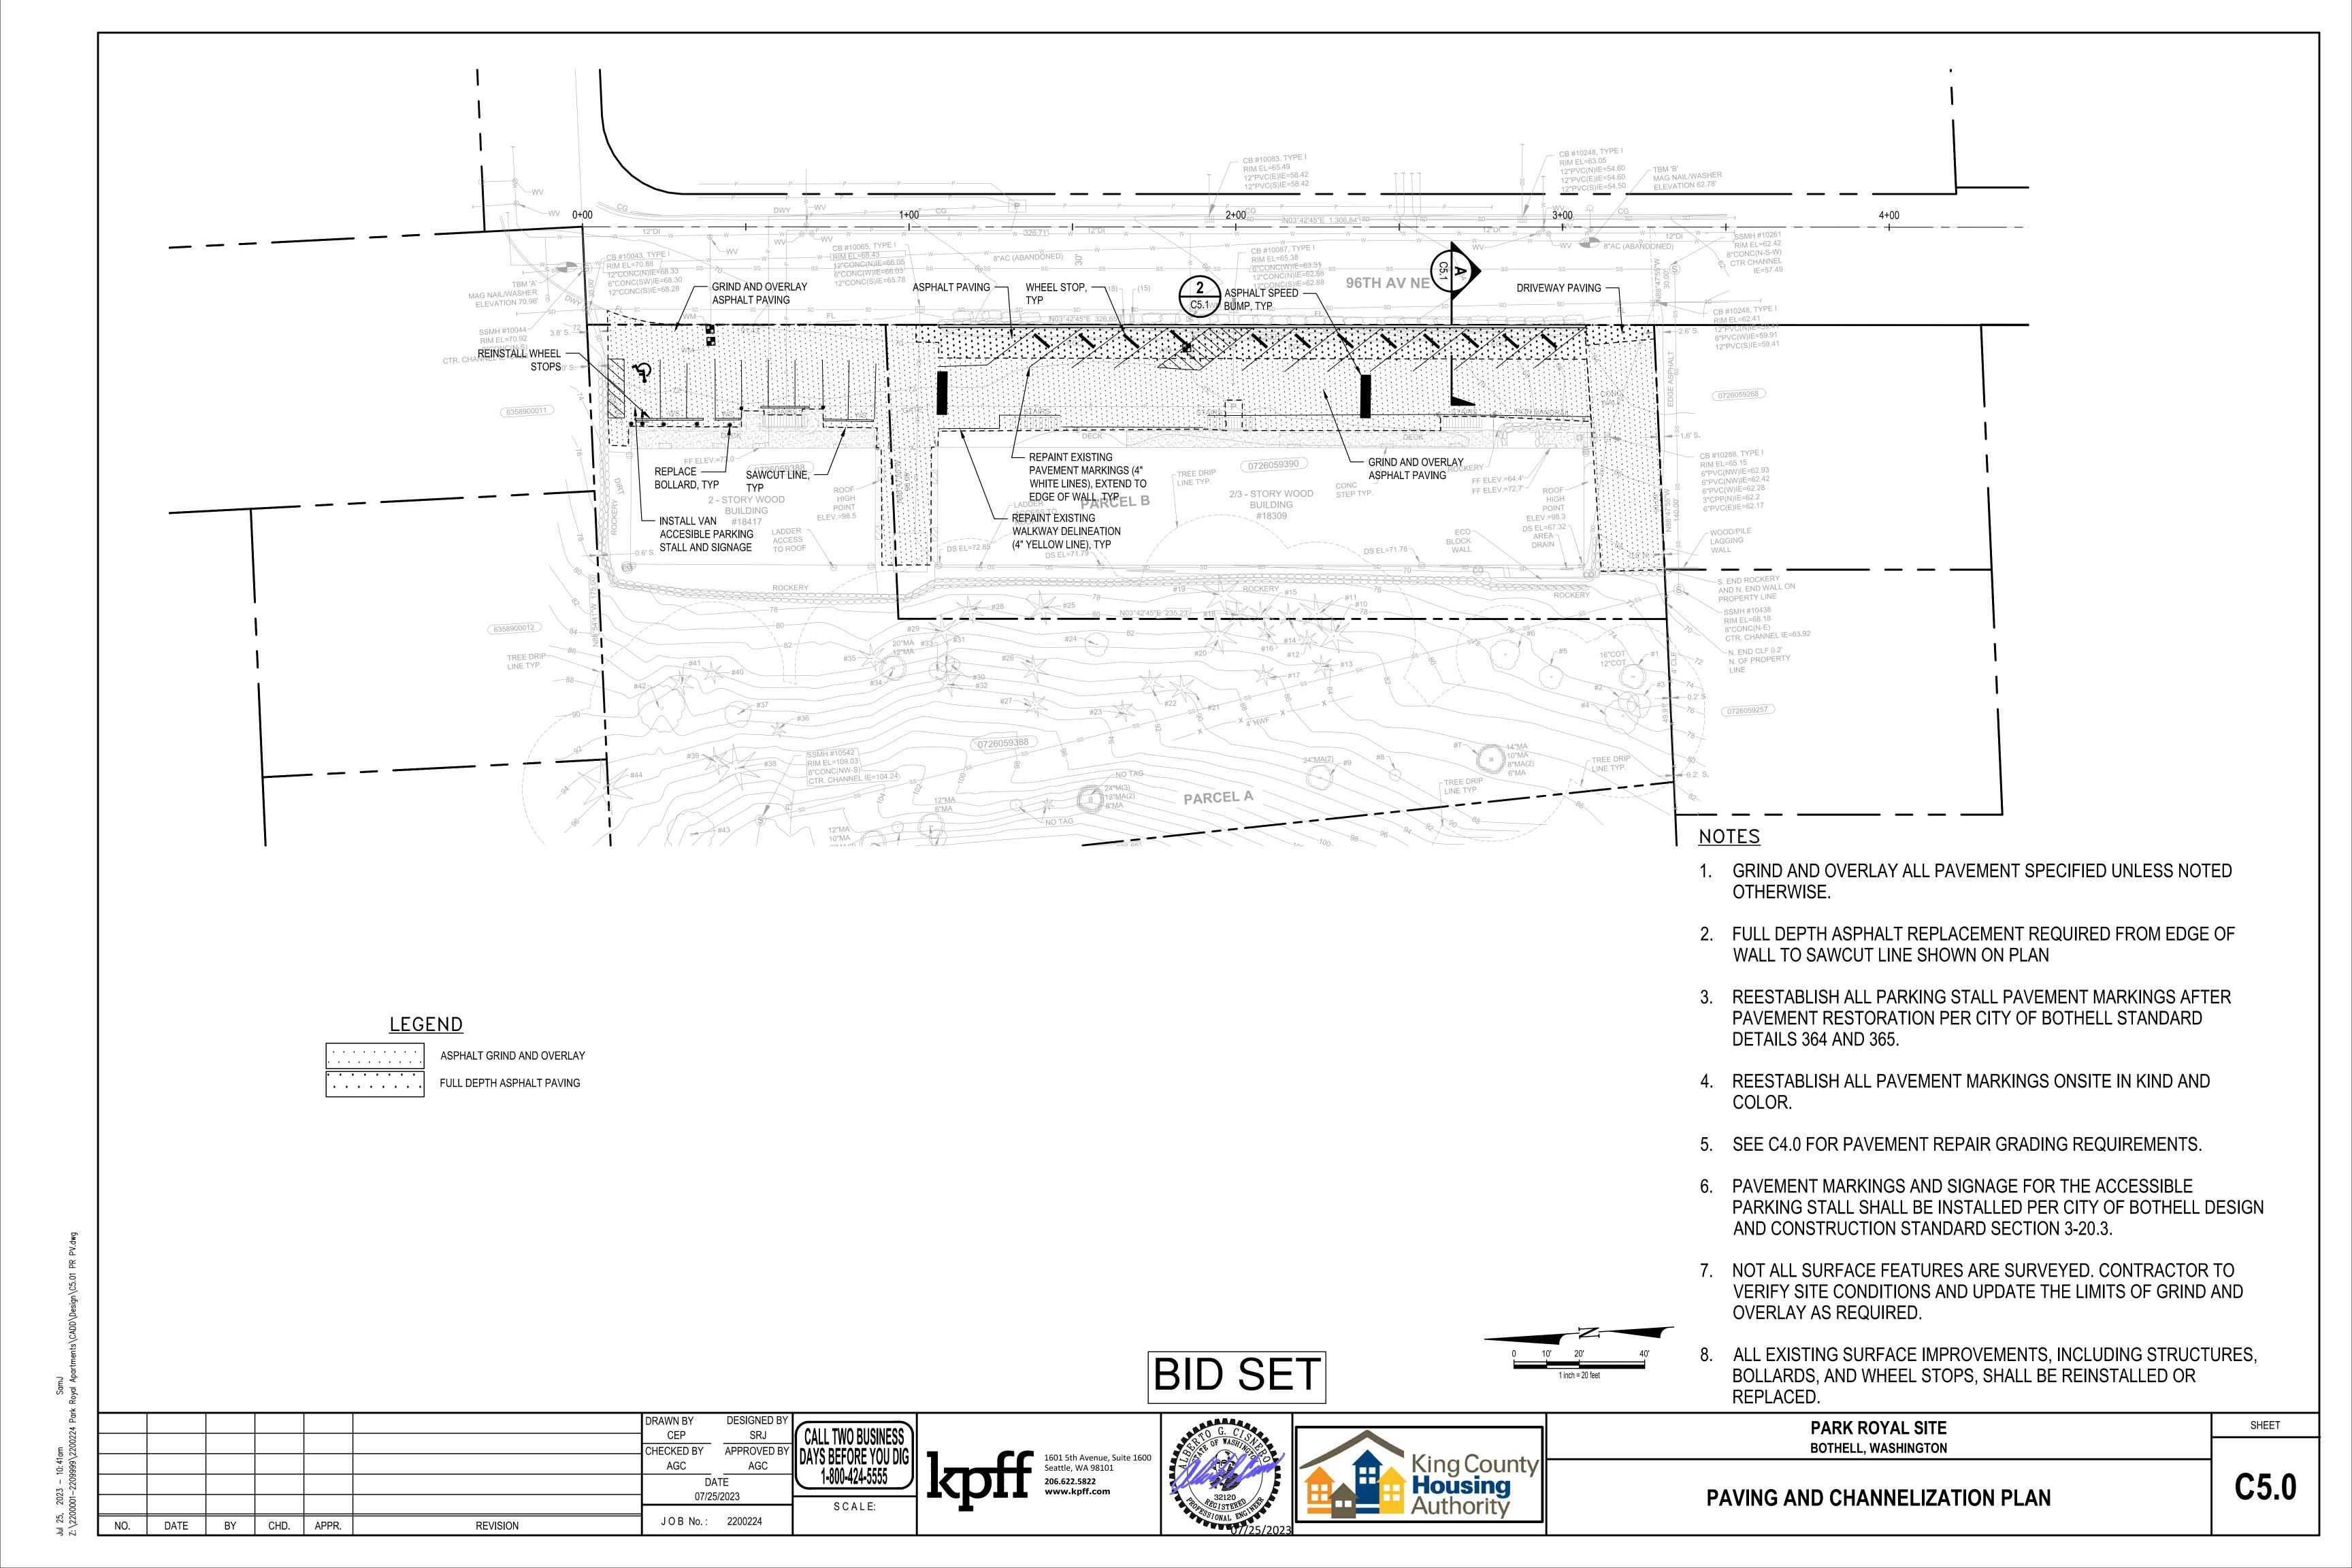

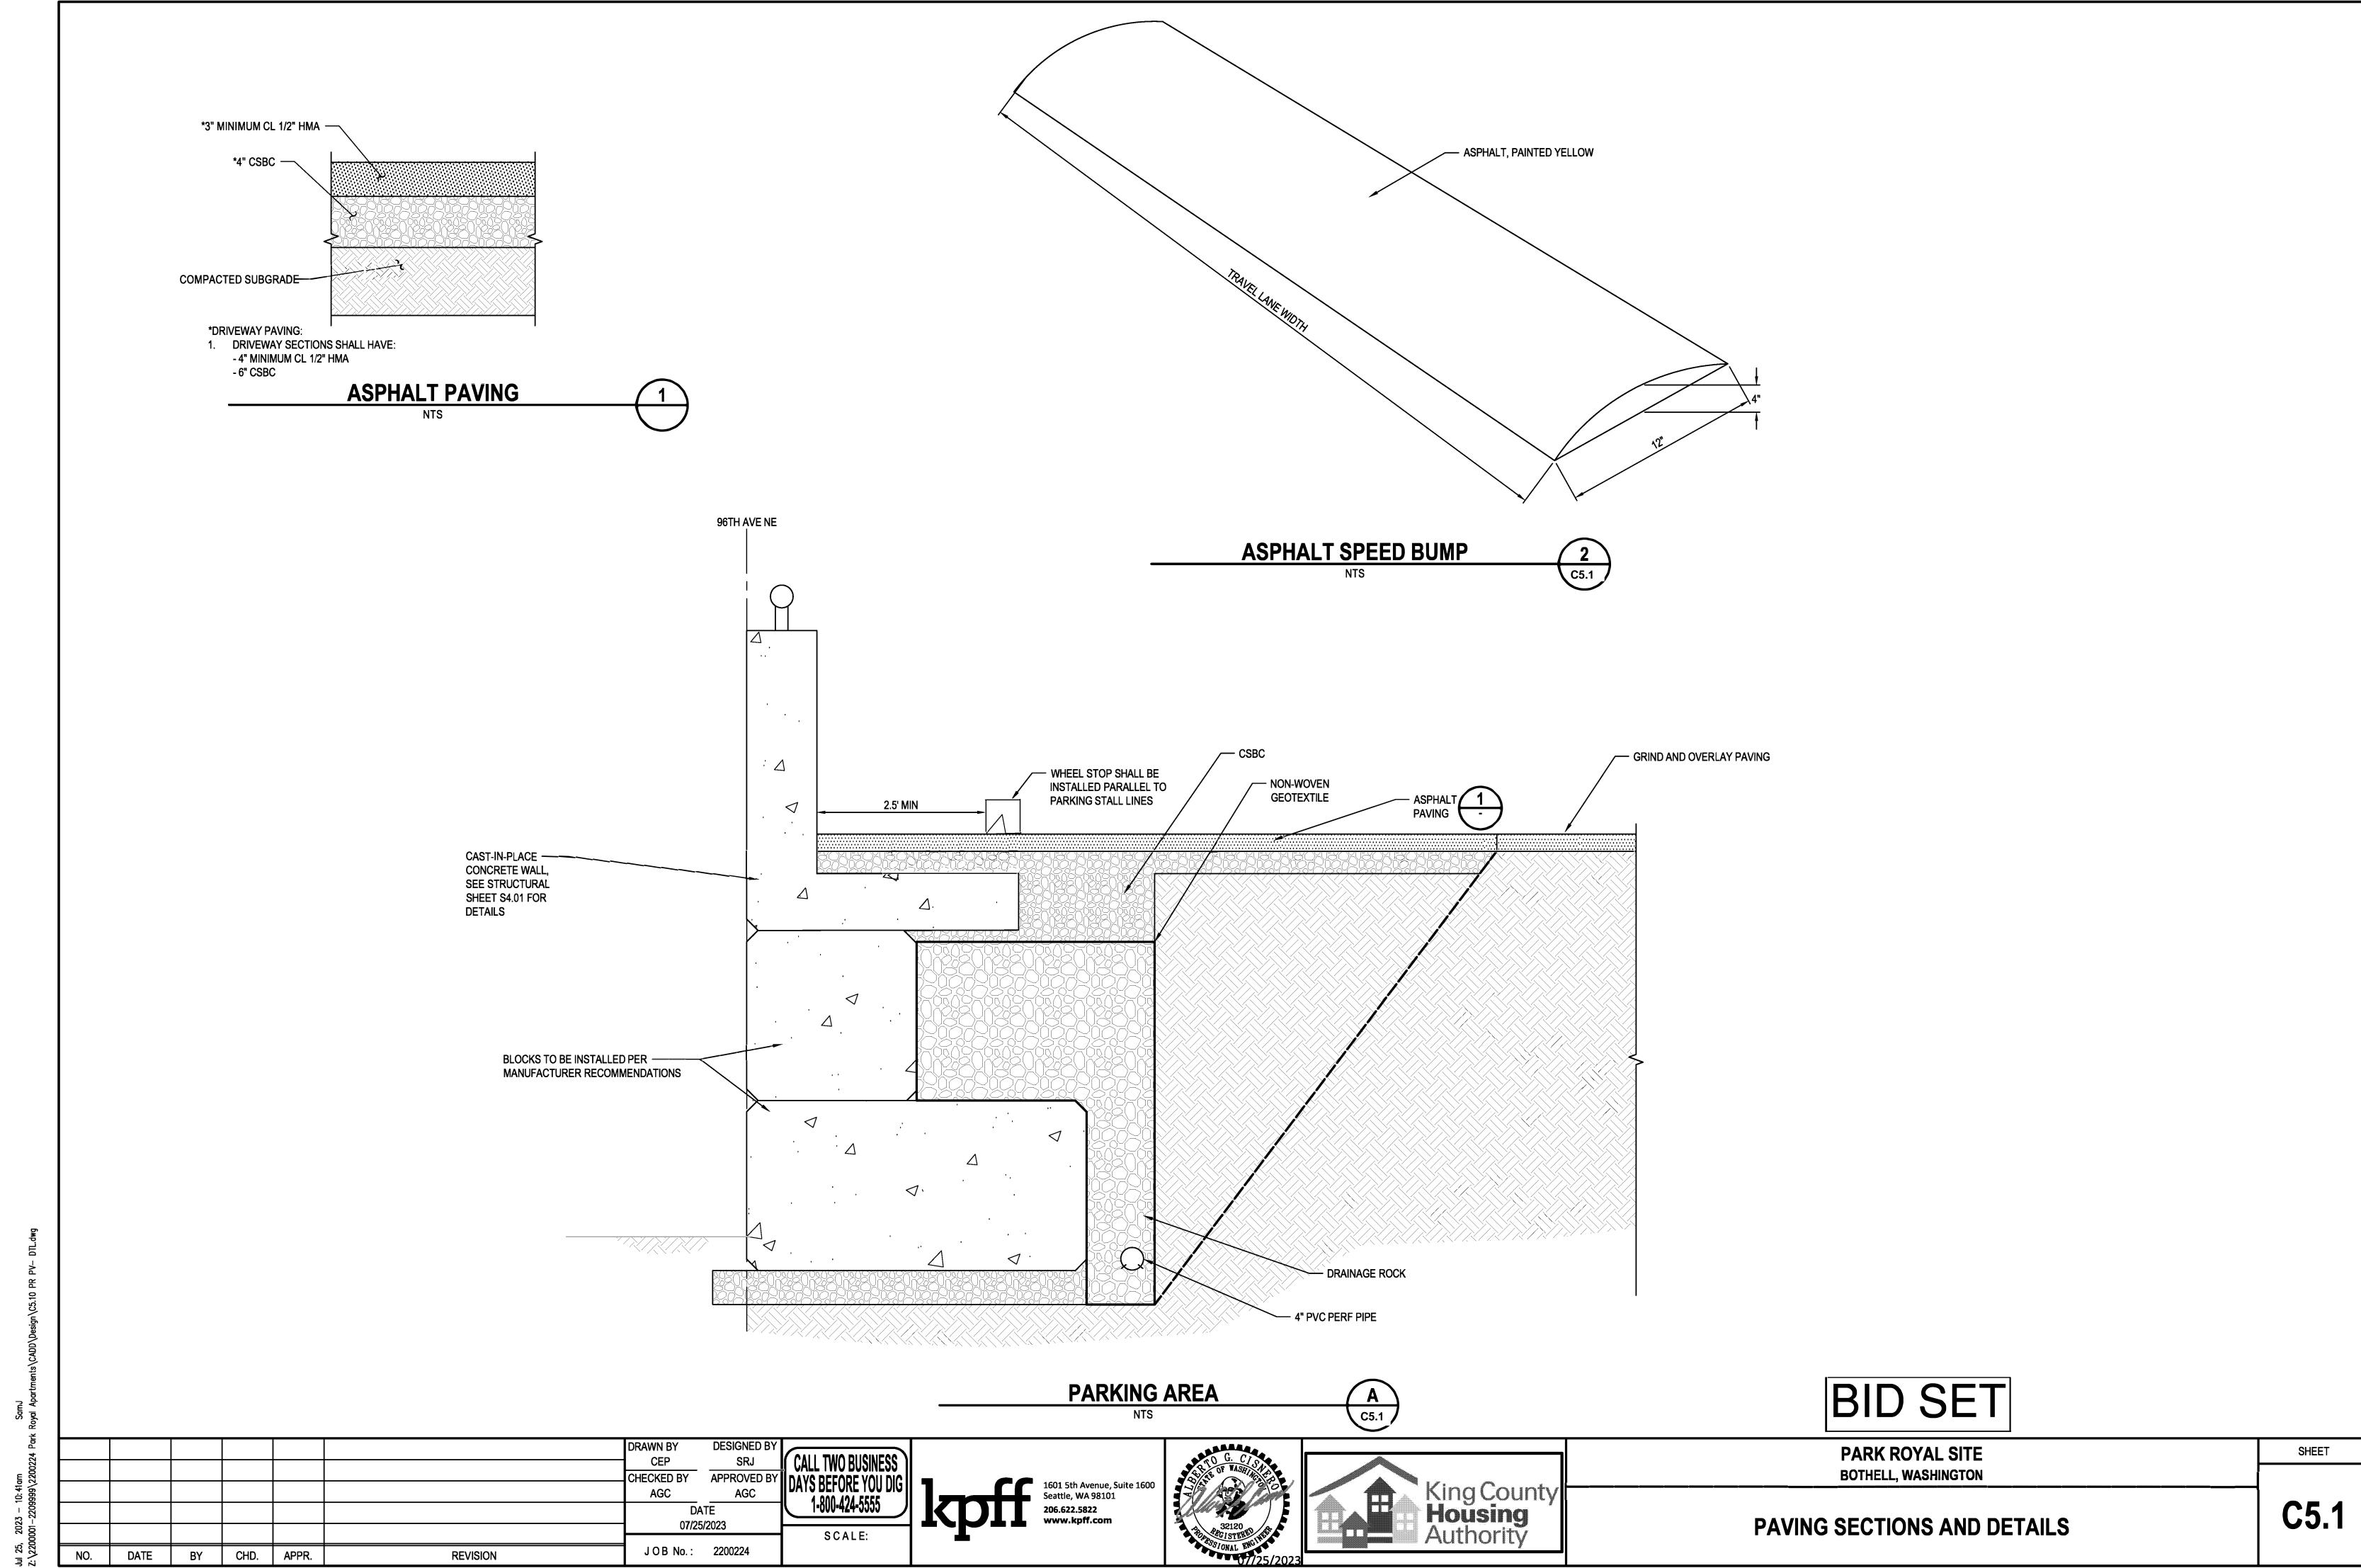


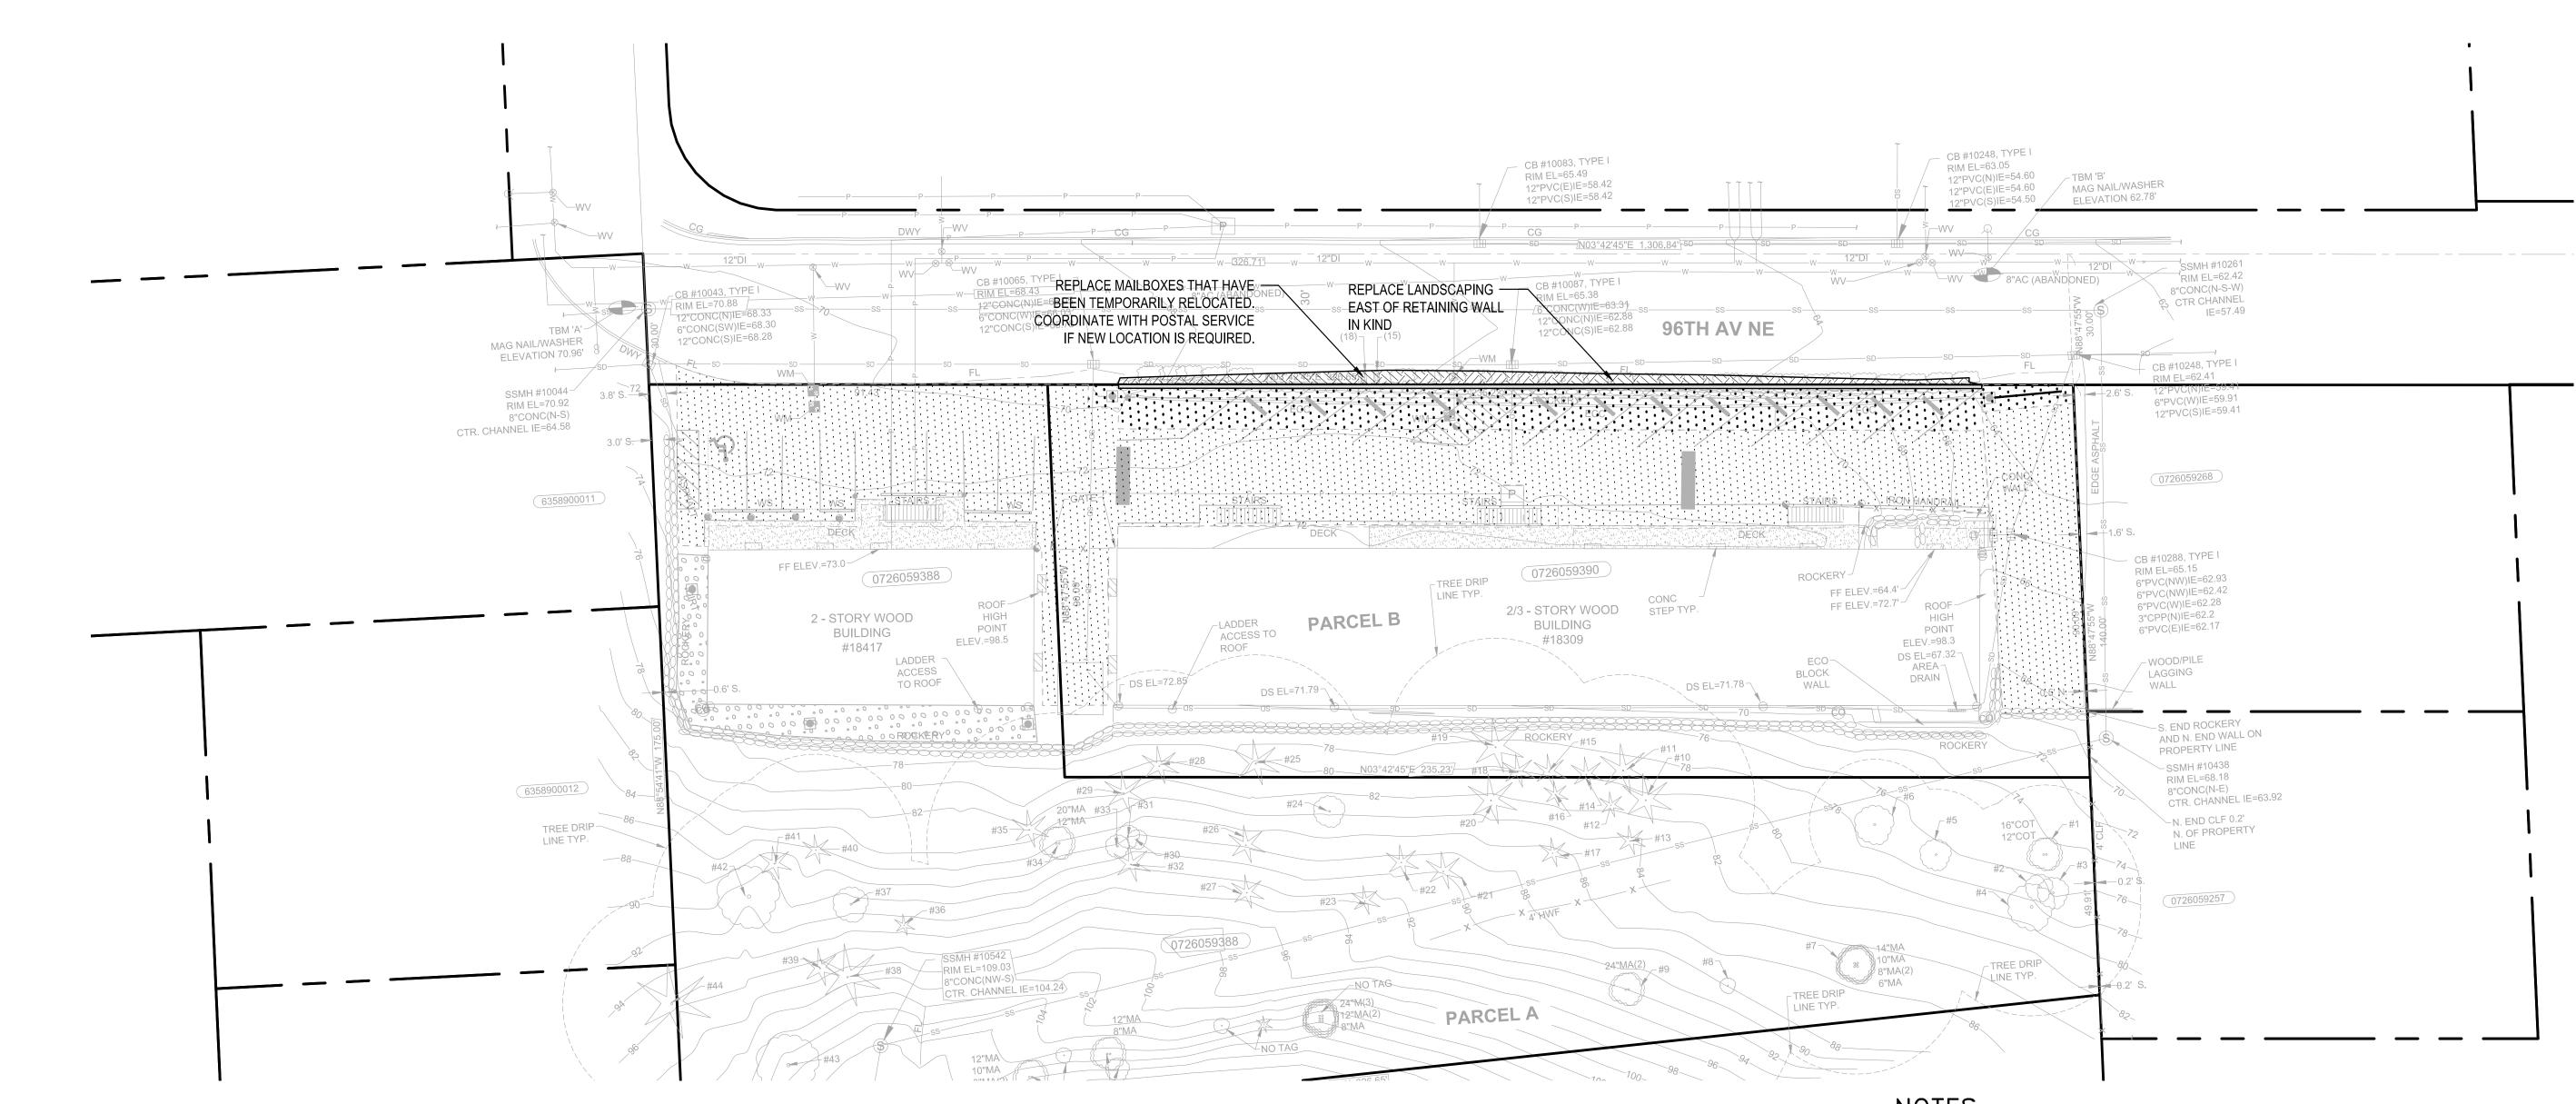

NOTES

- 1. ALL LANDSCAPING DISTURBED OR DAMAGED DURING CONSTRUCTION TO BE REPLACED IN KIND.
- 2. REPLACE ANY SIGNS DISTURBED DURING CONSTRUCTION.
- 3. CONTRACTOR RESPONSIBLE FOR TRAFFIC CONTROL PLAN AND IMPLEMENTATION DURING CONSTRUCTION.



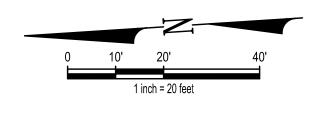

						DRAWN BY	DESIGNED BY	CALL TW
						CEP	SRJ	CALL TWO
						CHECKED BY	APPROVED BY	DAYS BEF
						AGC	AGC	1 000
						DA	TE	1-800-
						07/25	5/2023	0.0
								SC
NO.	DATE	BY	CHD.	APPR.	REVISION	JOB No.:	2200224	







PARK ROYAL SITE	
BOTHELL, WASHINGTON	

C6.0