KCHA - 600 BUILDING - BATHROOM REMODEL

PROJECT TEAM

OWNER:

KING COUNTY HOUSING AUTHORITY 700 ANDOVER PARK WEST SUITE C

PARTIAL INTERIOR

ELEVATIONS

1 A1.1

PROJECT DESCRIPTION

SEATTLE, WA 98188 (206) 826-5348 PATRICK KAAPANA <PatrickK@kcha.org>

ARCHITECT:


LAWHEAD ARCHITECTS P.S. 1239 120TH AVENUE NORTHEAST SUITE D BELLEVUE, WA 98005 (425) 556-1220 FRANK LAWHEAD <FLawhead@Lawhead.com>

MECHANICAL/ ELECTRICAL:

HULTZ BHU ENGINEERS INC. 1111 FAWCETT AVE. SUITE 100 **TACOMA, WA 98402** (253) 383-3257 RICK HULTZ <RHultz@HultzBHU.com>

THE PROPOSED PROJECT CONSISTS OF INTERIOR RENOVATIONS TO MALE AND FEMALE RESTROOM FACILITIES WITH MATCHING PLAN LAYOUTS ON THE 1ST AND 2ND FLOORS IN THE PUBLIC CORE OF THE KING COUNTY HOUSING AUTHORITY CENTRAL OFFICE 600 BUILDING. THE BUILDING AND RESTROOMS WERE CONSTRUCTED IN 1980 AND ORIGINAL DRAWINGS PERMITTED UNDER THE 1976 EDITION OF THE UNIFORM BUILDING CODE. THE INTENDED SCOPE OF THE PROPOSED PROJECT IS LIMITED TO THESE RESTROOMS AND WOULD INCLUDE REPLACING EXISTING WALL AND FLOOR FINISHES. MODIFYING EXISTING LIGHTING, REPLACING PLUMBING FIXTURES, REPLACING TOILET PARTITIONS, REPLACING LAVATORY CASEWORK, REPLACING TOILET ACCESSORIES, MAKING MODIFICATIONS TO THE CEILING ARCHITECTURE TO INSTALL A COFFERED CEILING DESIGN, AND RELATED MECHANICAL AND ELECTRICAL MODIFICATIONS TO ACCOMMODATE THE AFOREMENTIONED WORK.

ARCHITECTURAL ABBREVIATIONS

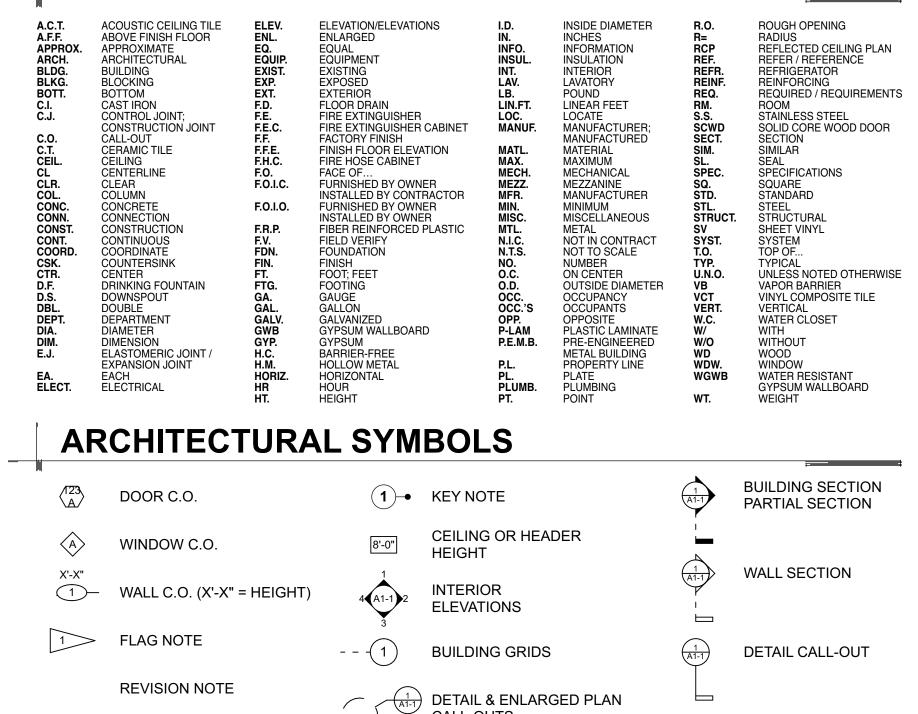

CALL-OUTS

VICINITY MAP.... 600 ANDOVER PARK W, TUKWILA, WA 98188 **— ||** SCALE: 1" = 1000' -SITE 🎢 S 166th St S 167th St Tukwila Pond Park Wig Blvd Minkler Blvc S 172nd Pl Minkler Blvd S 175th St

WOMEN'S RESTROOM - SOUTHEAST PERSPECTIVE VIEW...



MEN'S RESTROOM - SOUTHWEST PERSPECTIVE VIEW..



| 1 | PROJECT DATA | | | DEX | |
|---|----------------------------------------------|--------------------------------------------------------------------------------------|------|----------------------------------|----------------------------------------------|
| ļ | SITE ADDRESS: | 600 ANDOVER PARK W TUKWILA, WA 98188 | | COVER S | |
| | PARCEL: LOT AREA: | #262304-9123 54,000 SQ. FT. (1.24 ACRES) | ARCI | HITECTUR AD-1 A2-1 A2-2 | AL DEMO EN FLOOR PI ENLARGE |
| | ZONING: | TUC-WP – TUKWILA URBAN CENTER - WORKPLACE DISTRICT | | A2-3 | ENLARGE PLANS |
| | BUILDING AREA: | 1ST FLOOR= $9,474$ SQ. FT.2ND FLOOR= $\pm 10,412$ SQ. FT.COMBINED AREA=19,886 SQ. FT | | A3-1 A3-2 A4-1 A5-1 | INTERIOR FINISH SE ENLARGE INTERIOR |
| | BUILDING HEIGHT: (PER IBC 202 DEFINITION) | ± 29'-0" MAXIMUM HEIGHT. TWO-STORY BUILDING | MEC | HANICAL M0-1 | MECHANI |
| | CONSTRUCTION TYPE: (IBC 601) | V-B ASSUMED (V-N PER 1976 U.B.C.), FULLY SPRINKLERED. | | M0-2 M1-1 M3-1 | MECHANI ENLARGE ENLARGE |
| | OCCUPANCY: | B (B-2 PER 1976 U.B.C.) – BUSINESS: 19,886 SQ. FT. | | M4-1 | ENLARGE |
| | | | | | |







Construction Documents

JOB NO...

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9/23/24

SHEET TITLE ...

Cover Sheet

SHEET NO...



ELECTRICAL

E5-1

ABBREVIATIONS, LEGEND,

ENLARGED FLOOR PLAN PLAN (KEY PLANS) GED FLOOR PLANS GED REFLECTED CEILING

OR ELEVATIONS SELECTIONS GED BUILDING SECTIONS OR DETAILS

NICAL LEGEND AND NOTES NICAL SCHEDULES GED DEMOLITION PLANS GED PLUMBING PLANS GED HVAC PLANS

& NOTES

ELECTRICAL DEMOLITION PLANS ELECTRICAL POWER AND LIGHTING PLANS **ONE-LINE DIAGRAM AND SCHEDULES**

E0-1 E1-1 E2-1

- 1. SEE MECHANICAL & ELECTRICAL DRAWINGS FOR MORE INFORMATION NOT SHOWN HERE.
- 2. ALL NOTES ARE TYPICAL FOR BOTH MEN'S AND WOMEN'S RESTROOMS AT BOTH FLOORS. SURVEY EXISTING RESTROOMS FOR A COMPLETE ACCOUNTING OF EXISTING FIXTURES, EQUIPMENT, RECEPTACLES, SIGNAGE, ETC. WITHIN PROJECT SCOPE OF WORK.
- 3. PROVIDE ADDITIONAL DEMOLITION NOT SHOWN HERE IN ORDER TO MAKE WAY FOR NEW CONSTRUCTION. REFER TO ALL DRAWINGS & SPECIFICATIONS.





WOMEN'S RESTROOM -SOUTH PERSPECTIVE





WOMEN'S RESTROOM -NORTHEAST PERSPECTIVE





3

WOMEN'S RESTROOM -NORTH PERSPECTIVE

REMOVE / SALVAGE FIRE ALARM EQUIPMENT FOR REUSE AT ORIGINAL LOCATIONS.

REMOVE / TEMPORARILY PROTECT FIRE SPRINKLER SYSTEM WHERE NECESSARY TO MAKE WAY FOR NEW SOFFITS AND COFFERED CEILINGS.

DEMO. LIGHTING. SALVAGE LIGHTING WHERE BEING REUSED. SEE ELEC. FOR MORE INFO.

DEMO. TOILET PARTITIONS.

- REMOVE ALL TOILET ACCESSORIES. RETURN TO OWNER.

DEMO EXISTING CEILING FINISHES AND SUPPORTING CONSTRUCTION TO MAKE WAY FOR NEW SOFFITS AND COFFERED CEILINGS.

- DEMO. ALL CERAMIC TILE WALL AND FLOOR FINISHES. DEMO. UNDERLYING WALL SHEATHING MATERIALS, AND FLOOR UNDERLAYMENTS DOWN TO SUBSTRATE — CONCRETE SLAB ON GRADE AT THE 1ST FLOOR & CONCRETE TOPPING AT THE 2ND FLOOR. COORDINATE WITH OWNER TO ASSESS QUALITY OF SUBSTRATE AFTER DEMOLITION. ENSURE SURFACES ARE CLEAN AND LEVEL AND READY TO RECEIVE NEW WORK.

PROTECT DOORS DURING DEMOLITION.

- DEMO. LIGHTING. SALVAGE LIGHTING WHERE BEING REUSED. SEE ELEC. FOR MORE INFO.

- REMOVE ALL TOILET ACCESSORIES. RETURN TO OWNER.

DEMO. MIRRORS.

- DEMO. PLUMBING FIXTURES (U.N.O.). SEE MECH. FOR MORE INFO.

DEMO. CASEWORK

- DEMO EXISTING CEILING FINISHES AND SUPPORTING CONSTRUCTION TO MAKE WAY FOR NEW SOFFITS AND COFFERED CEILINGS.

DEMO. LIGHTING. SALVAGE LIGHTING WHERE BEING REUSED. SEE ELEC. FOR MORE INFO.

- DEMO. MIRRORS.

REMOVE / TEMPORARILY PROTECT FIRE SPRINKLER SYSTEM WHERE NECESSARY TO MAKE WAY FOR NEW SOFFITS AND COFFERED CEILINGS.

DEMO. ALL CERAMIC TILE WALL AND FLOOR FINISHES. DEMO. UNDERLYING WALL SHEATHING MATERIALS, AND FLOOR UNDERLAYMENTS DOWN TO SUBSTRATE — CONCRETE SLAB ON GRADE AT THE 1ST FLOOR & CONCRETE TOPPING AT THE 2ND FLOOR. COORDINATE WITH OWNER TO ASSESS QUALITY OF SUBSTRATE AFTER DEMOLITION. ENSURE SURFACES ARE CLEAN AND LEVEL AND READY TO RECEIVE NEW WORK.

REMOVE ALL TOILET ACCESSORIES. RETURN TO OWNER.





MEN'S RESTROOM -NORTHWEST PERSPECTIVE





MEN'S RESTROOM -SOUTH PERSPECTIVE





MEN'S RESTROOM -NORTH PERSPECTIVE

DEMO. LIGHTING. SALVAGE LIGHTING WHERE BEING REUSED. SEE ELEC. FOR MORE INFO.

REMOVE / SALVAGE SWITCH & RECEPTACLE PLATES FOR REINSTALLATION AT ORIGINAL LOCATIONS. SEE ELEC.

REMOVE / SALVAGE SIGNAGE FOR REINSTALLATION AT ORIGINAL LOCATIONS.

REMOVE / SALVAGE DOOR HARDWARE FOR REINSTALLATION AT ORIGINAL LOCATIONS WHERE AFFECTED BY WORK.

DEMO EXISTING CEILING FINISHES AND SUPPORTING CONSTRUCTION TO MAKE WAY FOR NEW SOFFITS AND COFFERED CEILINGS.

DEMO. TOILET PARTITIONS.

REMOVE / SALVAGE FIRE ALARM EQUIPMENT FOR REUSE AT ORIGINAL LOCATIONS.

TO ASSESS QUALITY OF SUBSTRATE AFTER DEMOLITION. ENSURE SURFACES ARE CLEAN AND LEVEL AND READY TO RECEIVE NEW WORK.

DEMO. ALL CERAMIC TILE WALL AND FLOOR FINISHES. DEMO. UNDERLYING WALL SHEATHING MATERIALS, AND FLOOR UNDERLAYMENTS

DOWN TO SUBSTRATE - CONCRETE SLAB ON GRADE AT THE 1ST FLOOR & CONCRETE TOPPING AT THE 2ND FLOOR. COORDINATE WITH OWNER

DEMO. PLUMBING FIXTURES (U.N.O.). SEE MECH. FOR MORE INFO.

- DEMO EXISTING CEILING FINISHES AND SUPPORTING CONSTRUCTION TO

MAKE WAY FOR NEW SOFFITS AND COFFERED CEILINGS.



- DEMO. TOILET PARTITIONS.

FOR MORE INFO. - DEMO GRILLES. SEE MECH.

PROTECT DOORS DURING DEMOLITION. DEMO. LIGHTING. SALVAGE LIGHTING WHERE BEING REUSED. SEE ELEC.

NECESSARY TO MAKE WAY FOR NEW SOFFITS AND COFFERED CEILINGS.

REMOVE / TEMPORARILY PROTECT FIRE SPRINKLER SYSTEM WHERE

EXISTING URINAL TO REMAIN. PROTECT. MODIFY VALVES PER MECH.



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King

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JOB NO...

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9/23/24

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SHEET NO...

Demo Plan

AD-1

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Construction

Documents

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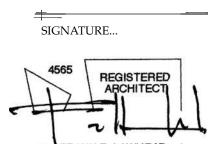
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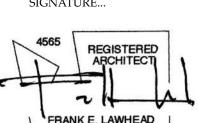
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9

Remode

Bathroom





STATE OF WASHINGTON

1239 120TH AVE. N.E., STE. D BELLEVUE, WA 98005 (425) 556-1220

LAWHEAD ARCHITECTS P.S.

DEMO. PLUMBING FIXTURES (U.N.O.). SEE MECH. FOR MORE INFO. REMOVE ALL TOILET ACCESSORIES. RETURN TO OWNER

REMOVE ALL TOILET ACCESSORIES. RETURN TO OWNER.

- DEMO. CASEWORK.

DEMO. TOILET PARTITIONS.









1. FIELD VERIFY ALL EXISTING DIMENSIONS.

LAWHEAD

- 2. FIELD VERIFY ALL EXISTING DIMENSIONS.

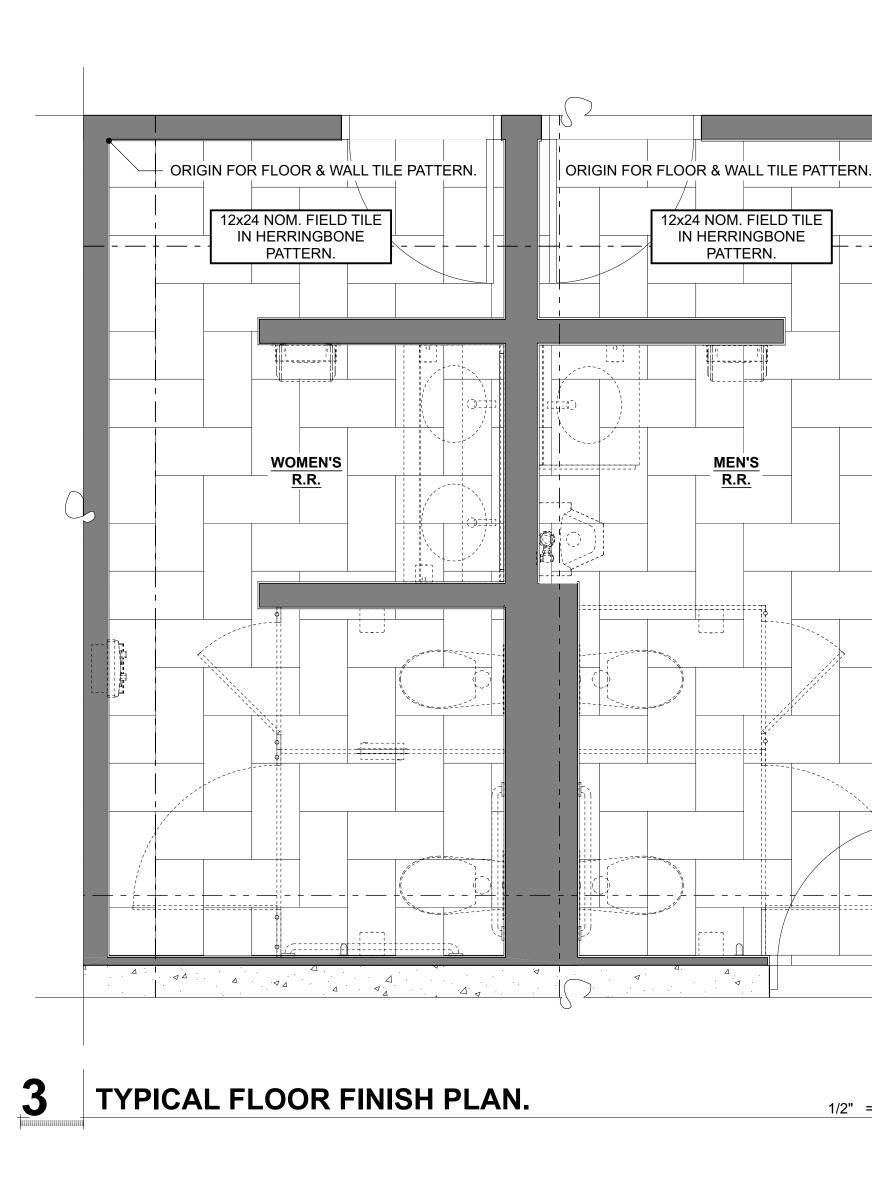


SEE MECHANICAL & ELECTRICAL FOR ADDITIONAL INFORMATION NOT SHOWN HERE.

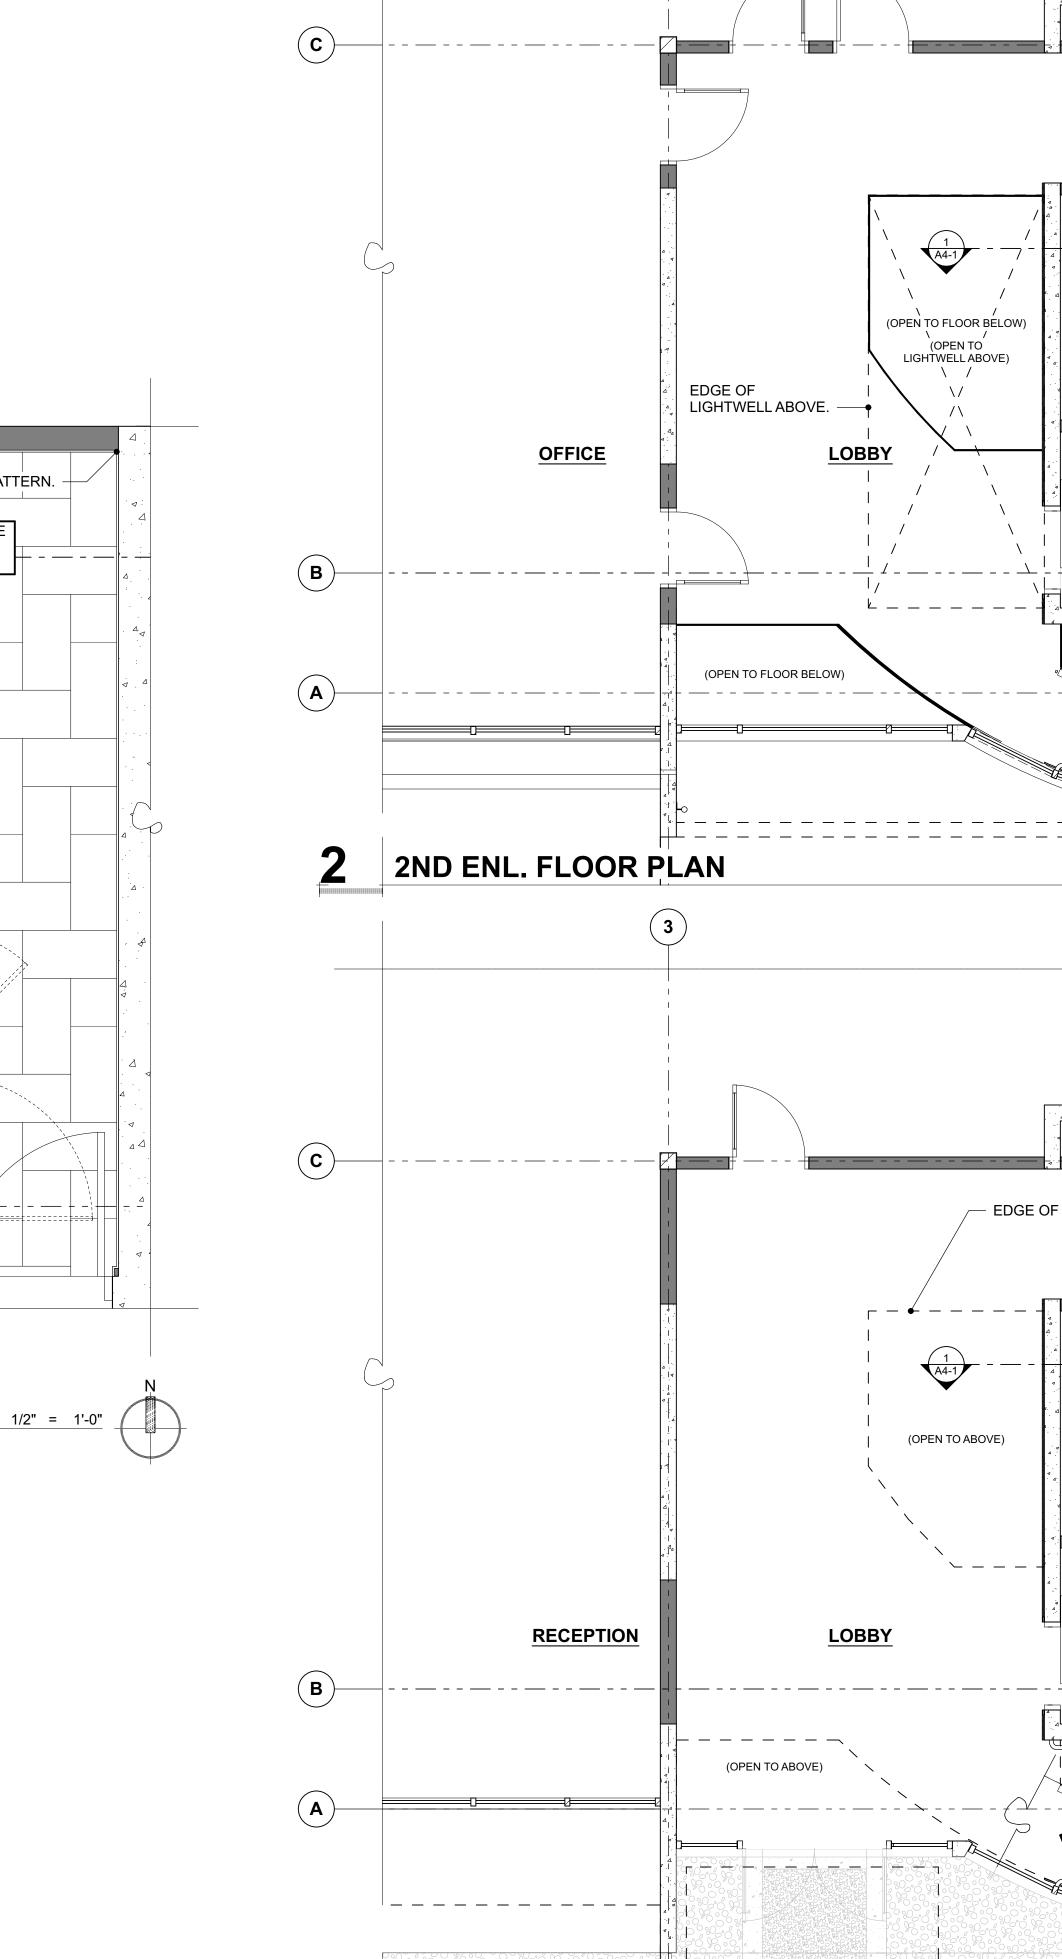

(3)

1ST ENL. FLOOR PLAN

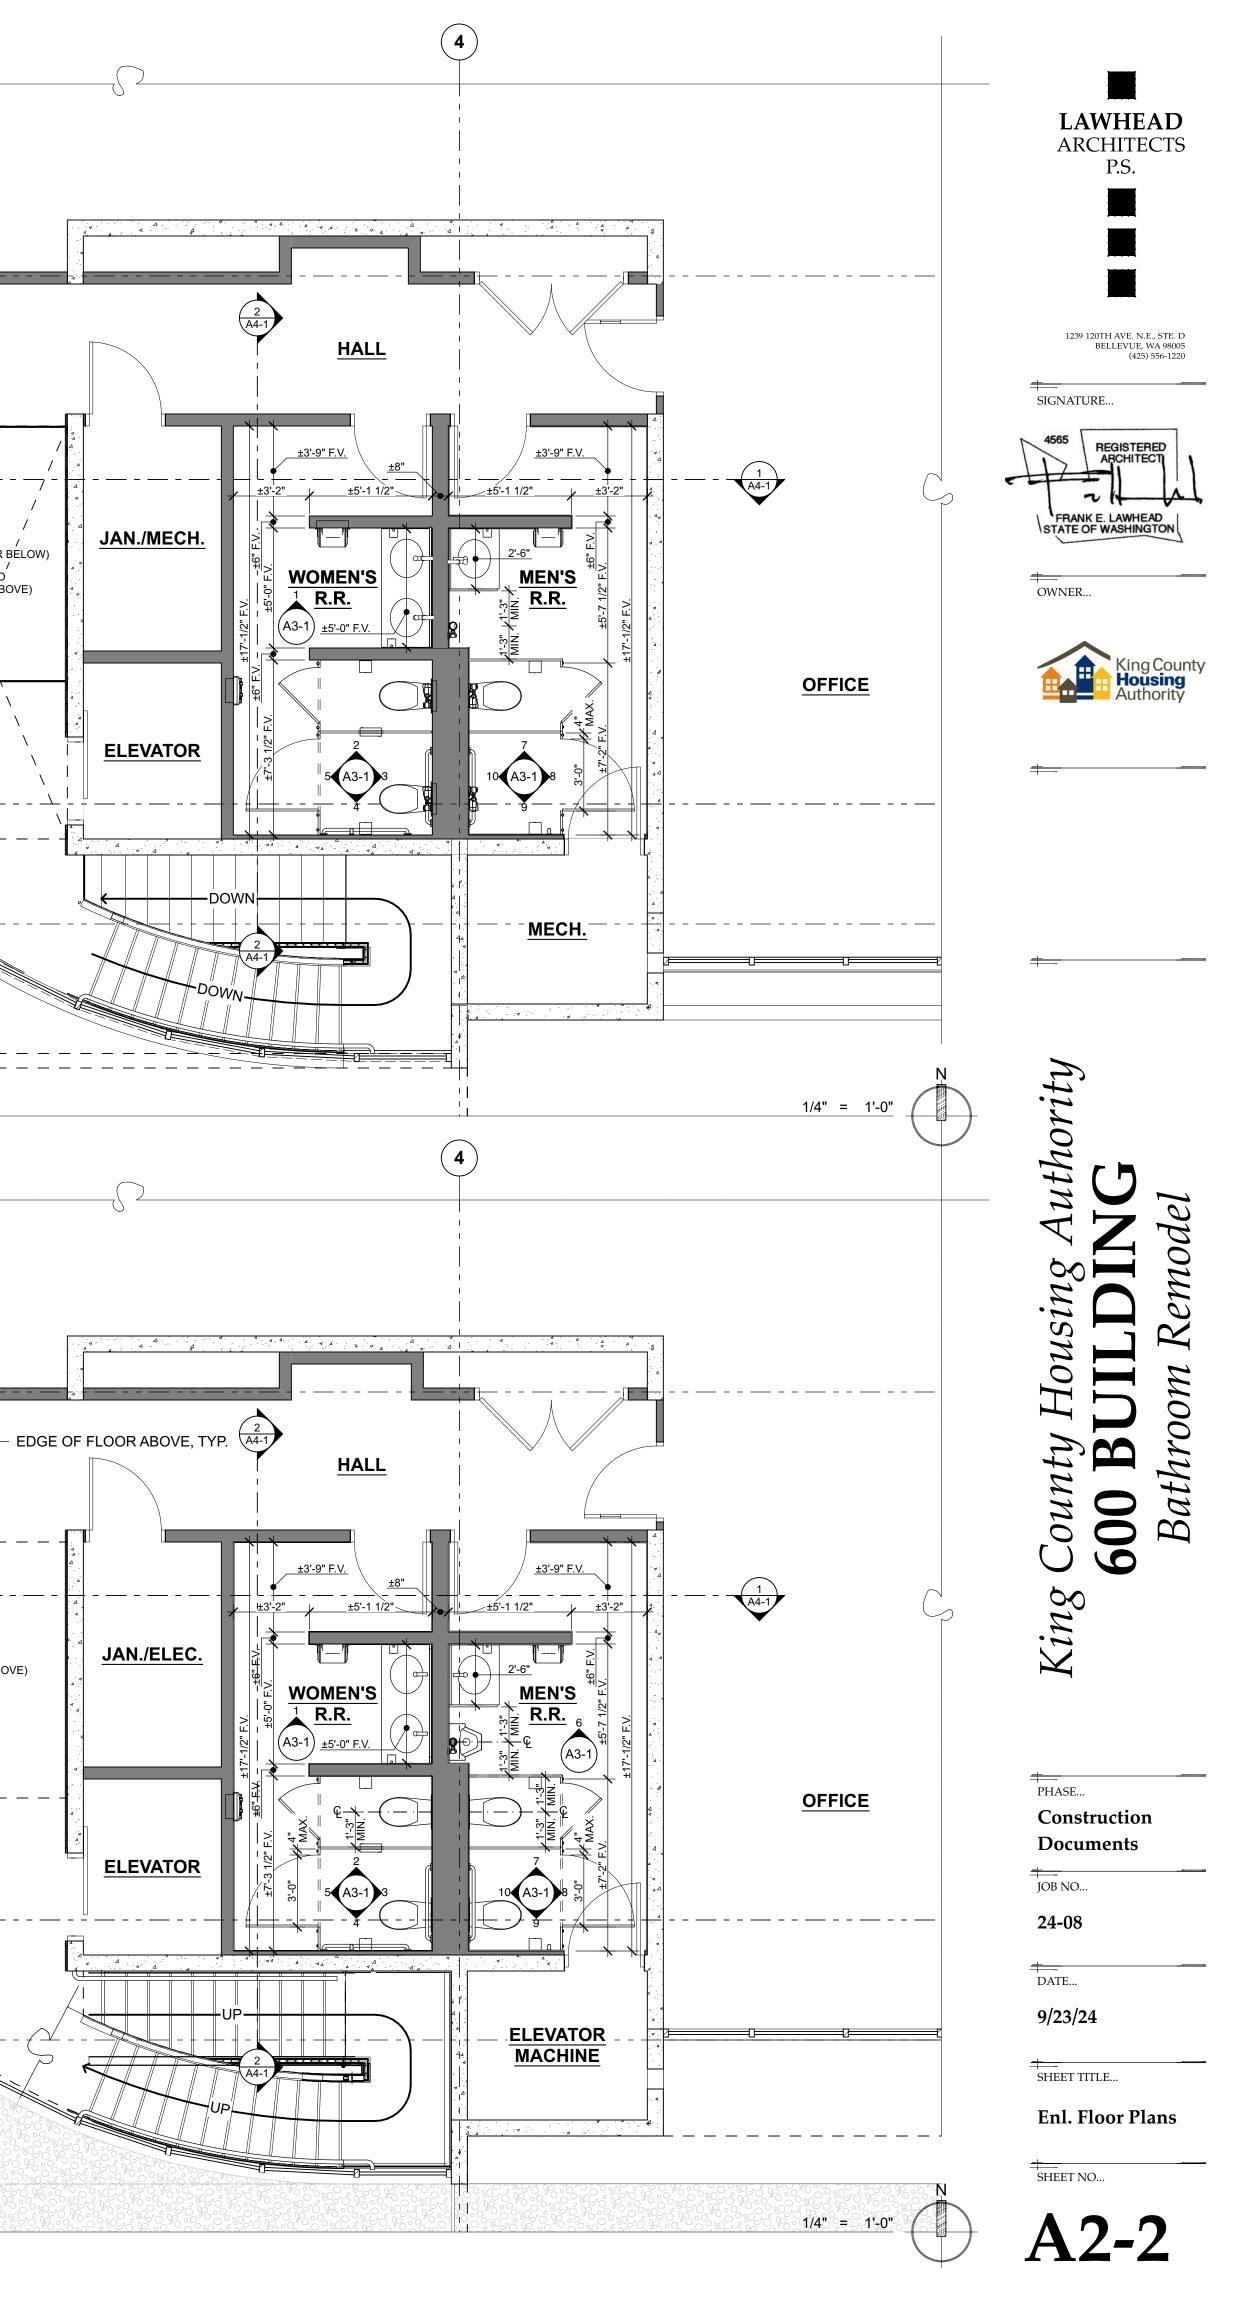



- 1. SEE MECHANICAL & ELECTRICAL FOR ADDITIONAL INFORMATION NOT SHOWN HERE.
- 2. FIELD VERIFY ALL EXISTING DIMENSIONS.
- 3. MODIFY EXISTING SPRINKLER SYSTEM TO ACCOMMODATE NEW COFFERED CEILINGS.


- 6. REINSTALL EXISTING LIGHTING WHERE BEING SALVAGED FOR REUSE.


| RCP LEGEND | | | | | | | |
|------------|-------------------------------------------------------|--|--|--|--|--|--|
| | GWB (GYPSUM WALL BOARD) | | | | | | |
| | ACT (ACOUSTIC CEILING TILE) | | | | | | |
| | PERFORATED WOOD VENEER ACT (ACOUSTIC CEILING TILE) | | | | | | |
| | EXPOSED TO STRUCTURE ABOVE | | | | | | |



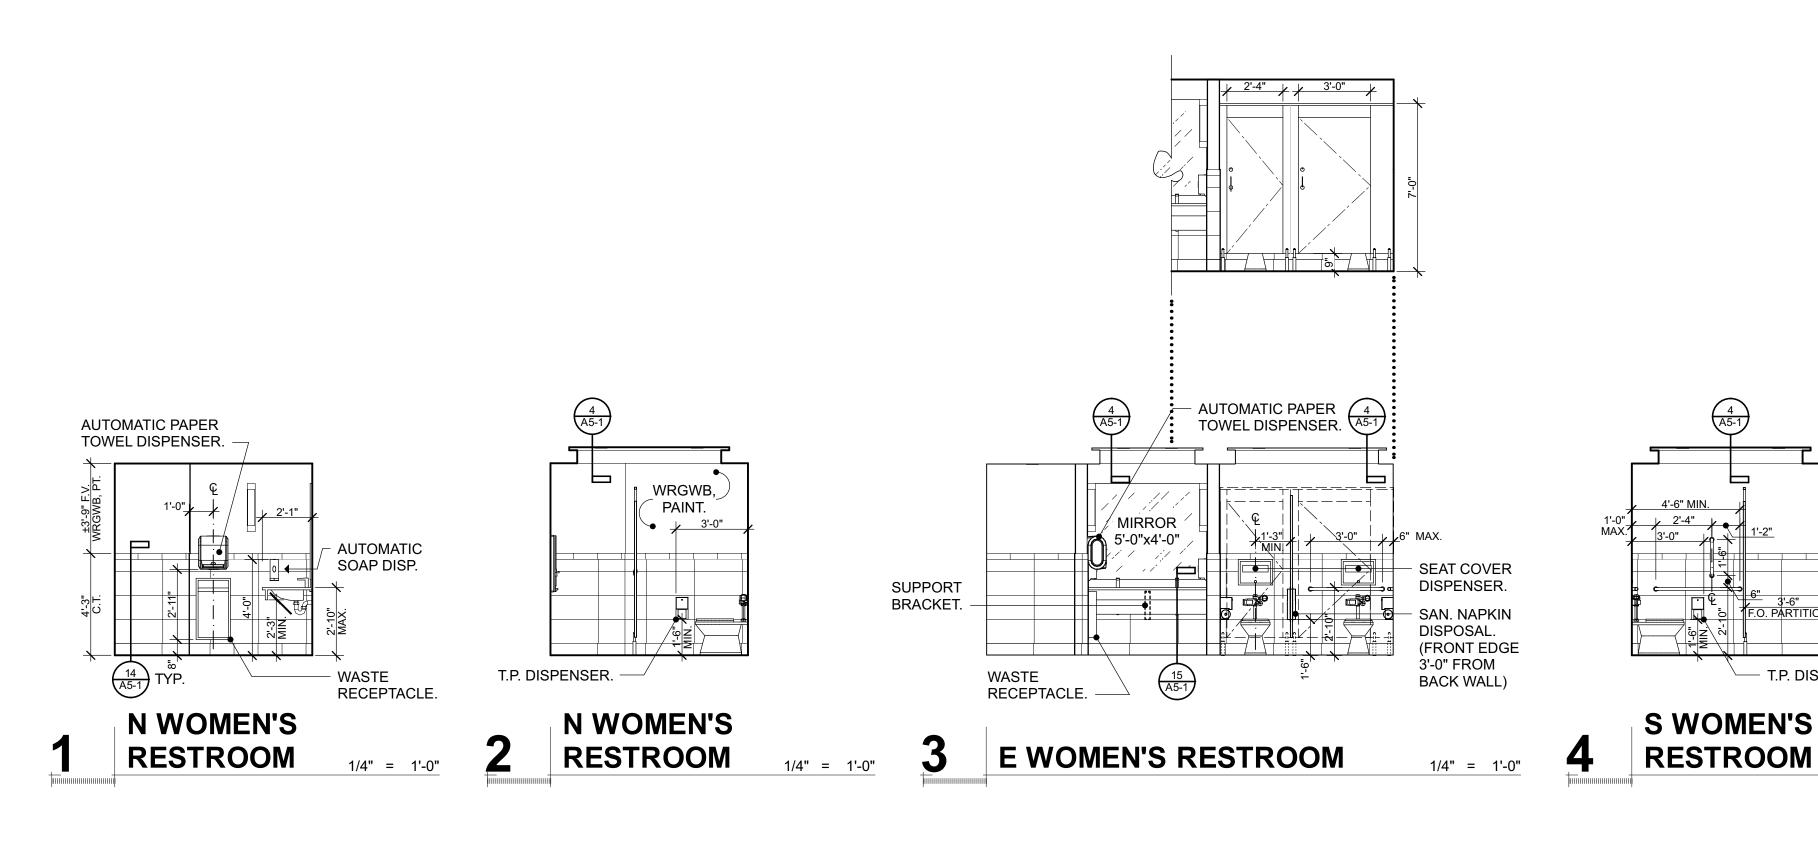

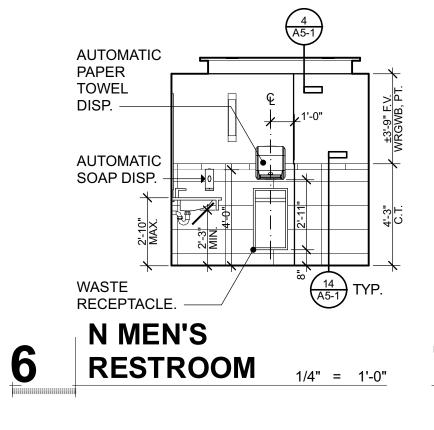

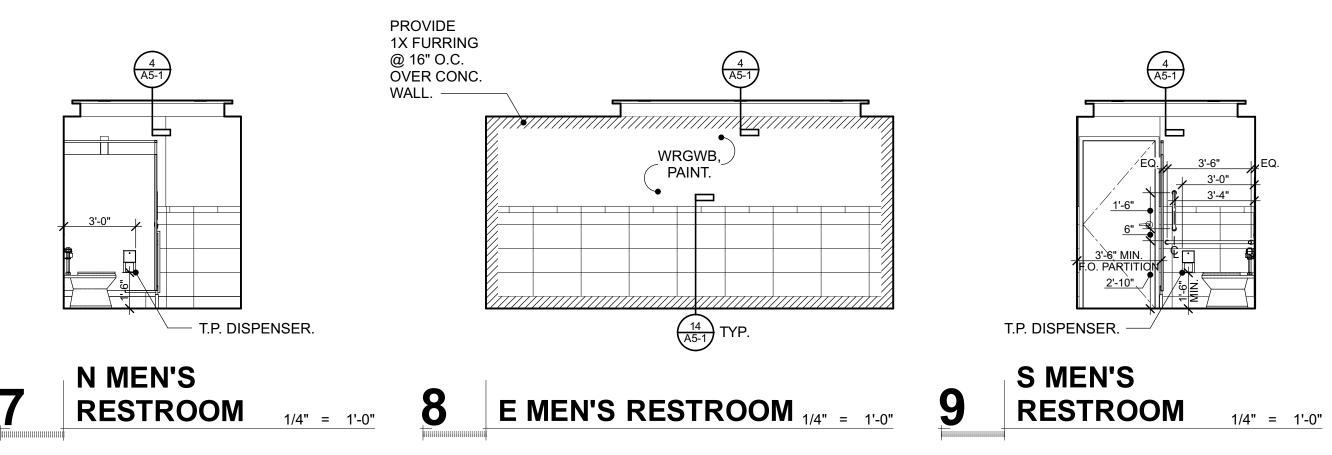

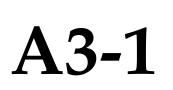

SHEET NO...

Interior Elevations

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Construction

Documents


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PHASE ...

JOB NO...

King

Remode Bathroom **D** 600

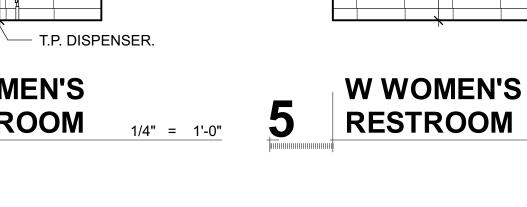

SEAT COVER DISPENSER.

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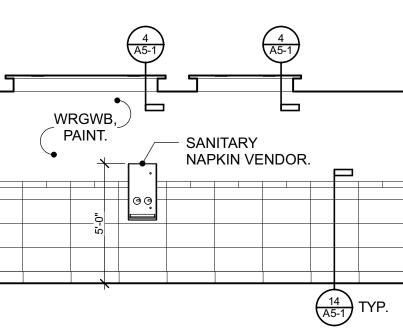
AUTOMATIC PAPER TOWEL DISPENSER.

1/

URINAL PARTITION. EXTEND TO MIN. 5'-0" HT. A.F.F. EXTEND HORIZ. THE GREATER OF EITHER 1-6" FROM WALL OR 6" BEYOND FRONT LIP OF URINAL ———

10 W MEN'S RESTROOM

PART



4 A5-1

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15 A5-1

- MIRROR 2'-6"x4'-0"

WRGWB,

PAINT.


SUPPORT


BRACKET.


1/4" = 1'-0"

- WASTE RECEPTACLE.

1/4" = 1'-0"

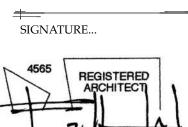


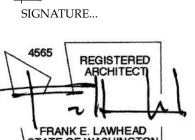

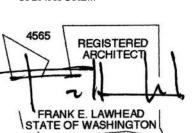

King County Housing

Authority

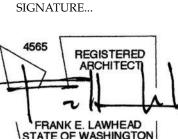


OWNER...

uthority

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County



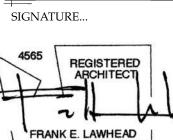


LAWHEAD


ARCHITECTS

P.S.

- 1. SEE MECHANICAL & ELECTRICAL DRAWINGS FOR ADDITIONAL INFORMATION NOT SHOWN HERE.
- 2. FIELD VERIFY ALL EXISTING DIMENSIONS.
- 3. MODIFY EXISTING WALL FRAMING AS REQUIRED TO MAKE WAY FOR RECESSED FIXTURES, & TO PROVIDE ADDITIONAL SUPPORT BLOCKING FOR SURFACE-MOUNTED FIXTURES.
- REMOVE / REPLACE EXISTING INSULATION DISTURBED DURING WORK.
- 4. REINSTALL DOOR HARDWARE, SWITCH & RECEPTACLE PLATES, SIGNAGE, AND OTHER EQUIPMENT SALVAGED FOR REUSE AT ORIGINAL LOCATIONS.



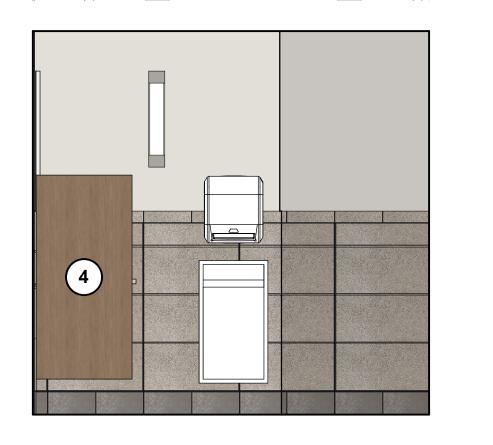

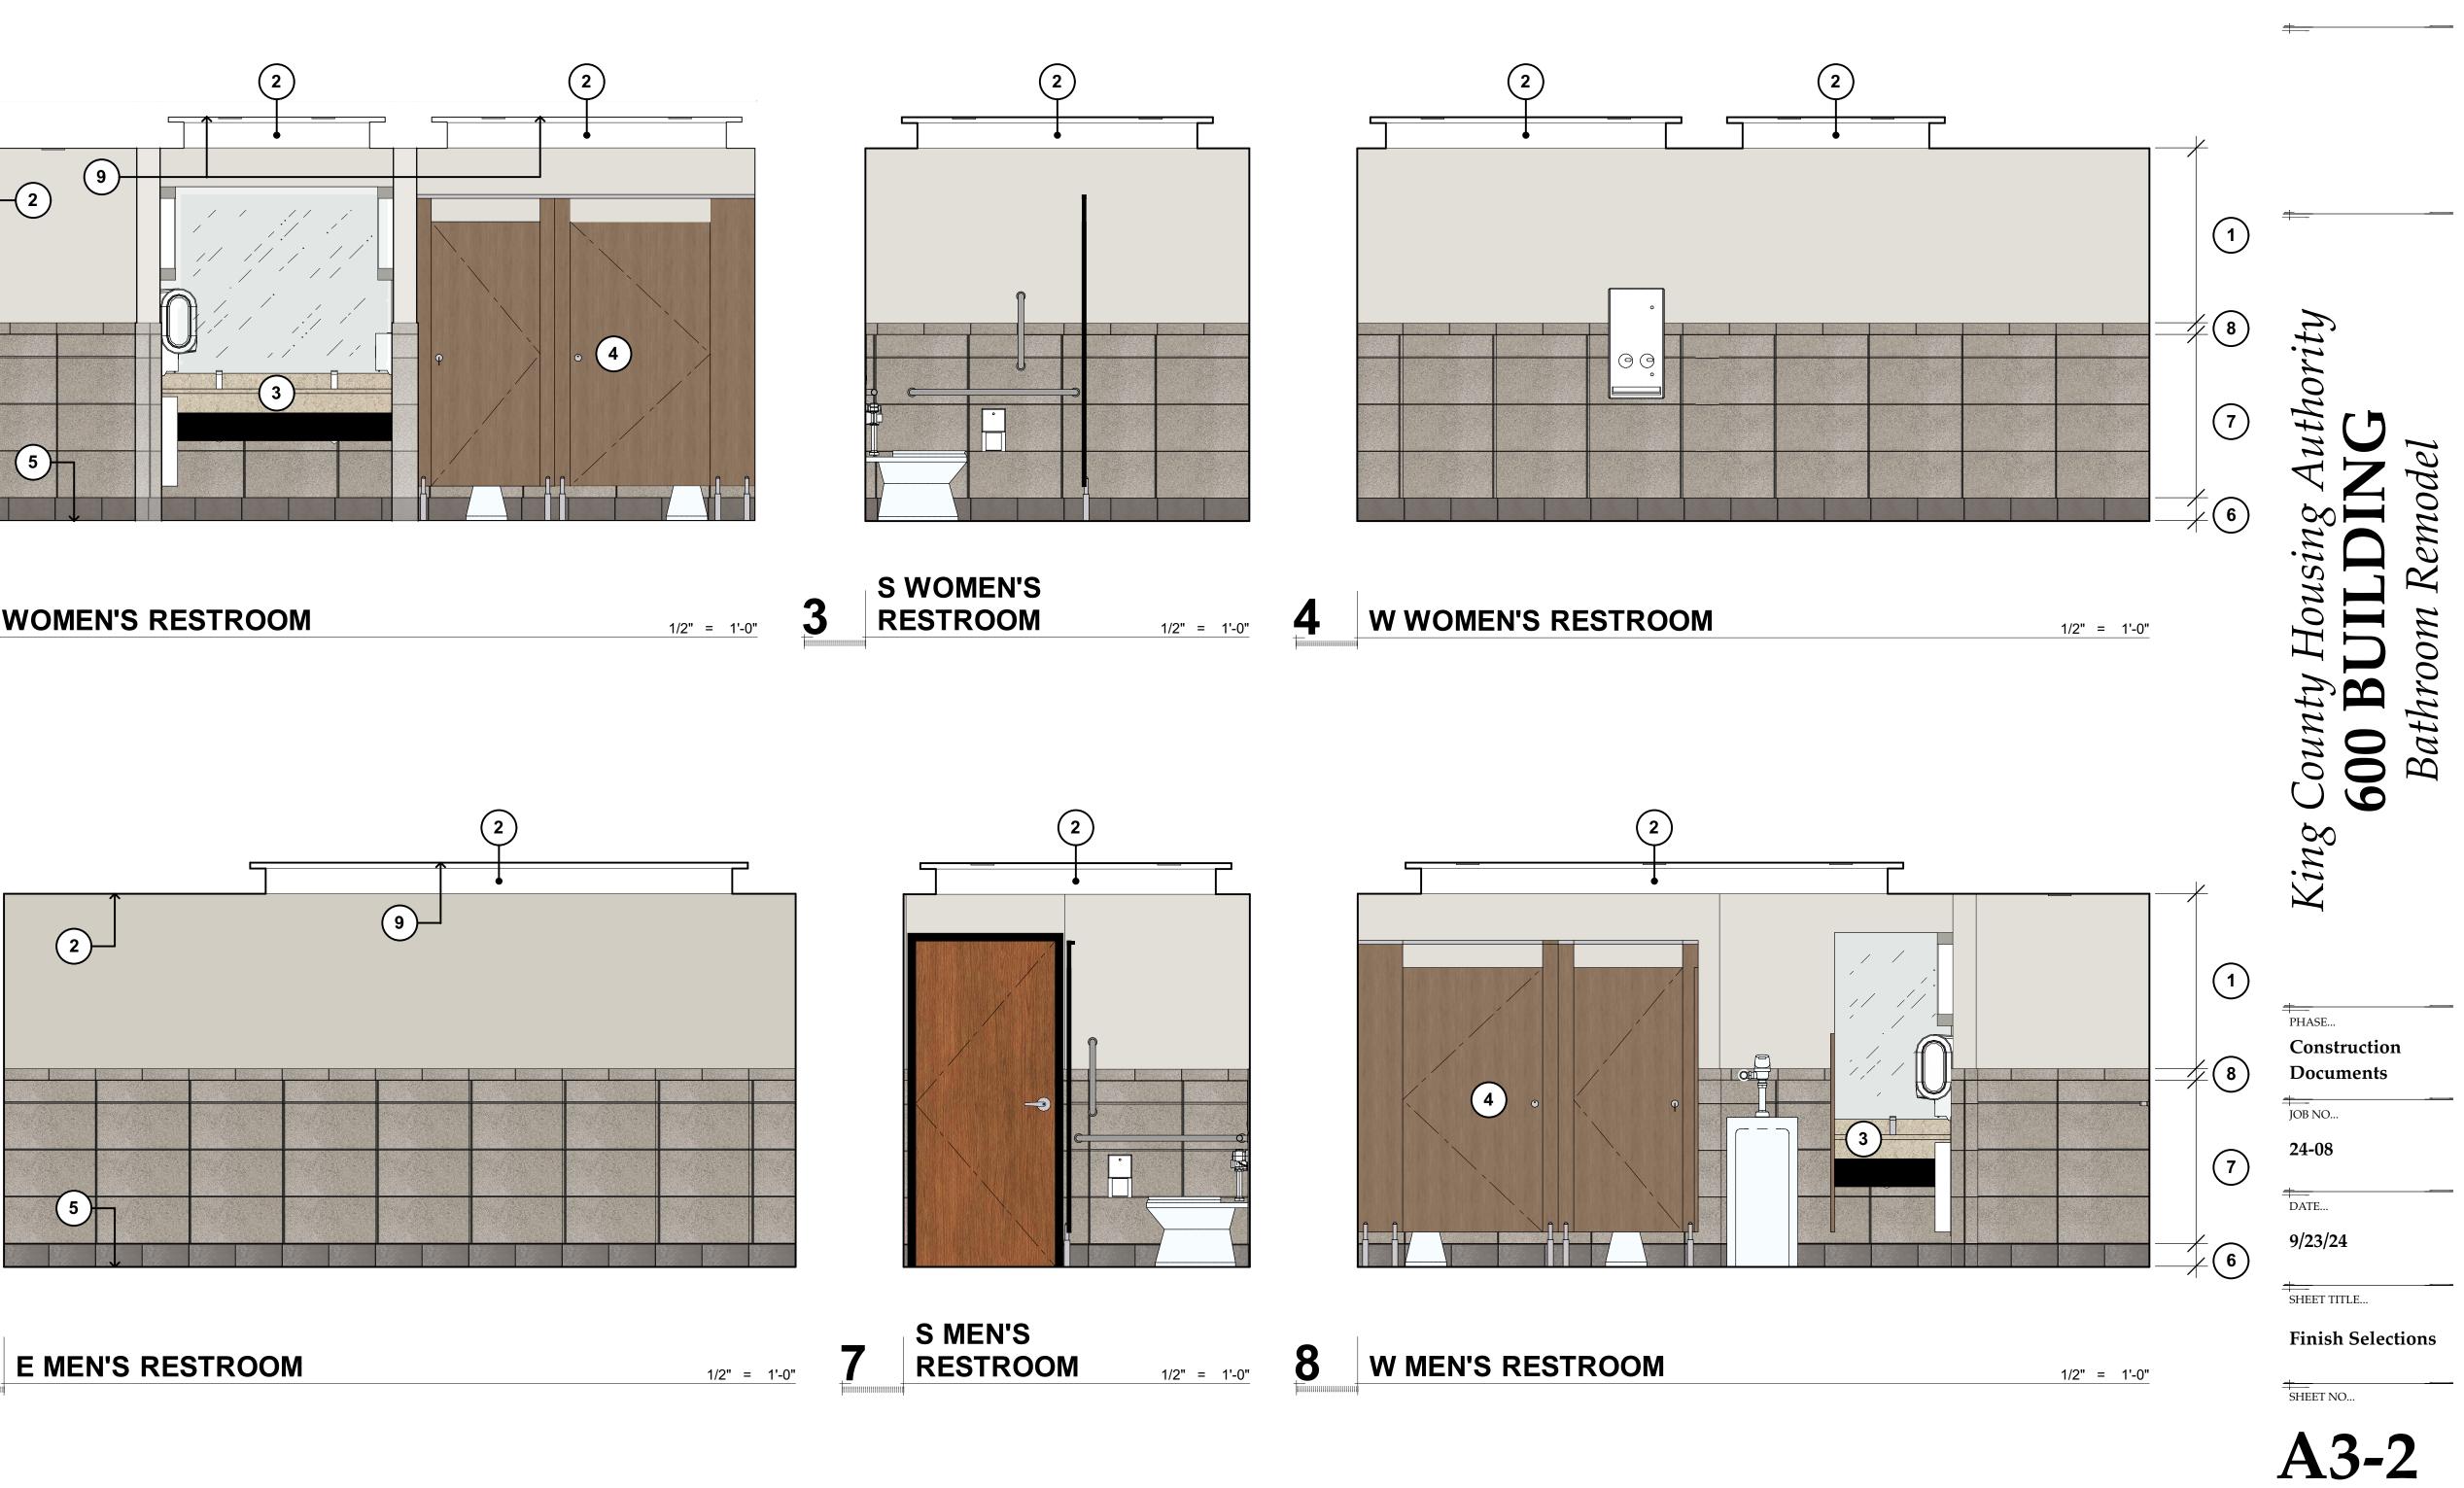



1

1/2" = 1'-0"

6

| | | | FINISH L |
|------------|---------------------------------|--------------------|------------------------------------------------------|
| NO. | MATERIAL | MANUFACTURER | PRODUCT SPEC. GROUP |
| 1- | PAINT | 'SHERWIN-WILLIAMS' | INTERIOR ACRYLIC LATEX |
| 2- | PAINT | 'SHERWIN-WILLIAMS' | INTERIOR ACRYLIC LATEX |
| 3- | QUARTZ RESIN | 'CORIAN' | QUARTZ PORTFOLIO |
| ④ - | PLASTIC LAMINATE | 'WILSONART' | PREMIUM LAMINATE (HW107) |
| ⑤ – | CERAMIC TILE | 'DALTILE' | COLORBODY PORCELAIN 'STO 'DIGNITARY' SERIES |
| 6 – | CERAMIC TILE | 'DALTILE' | COLORBODY PORCELAIN 'STO 'HAUTE MONDE' SERIES |
| 7- | CERAMIC TILE | 'DALTILE' | COLORBODY PORCELAIN 'STO 'DIGNITARY' SERIES |
| 8 – | CERAMIC TILE | 'DALTILE' | COLORBODY PORCELAIN 'STO 'DIGNITARY' SERIES |
| 9 – | PERFORATED WOOD CEILING TILE | 'ARMSTRONG' | WOODWORKS VENEER |

LEGEND

TONE ATTACHÉ' COLLECTION SUPERIOR TAUPE (DR08)

STONE ATTACHÉ' COLLECTION GLITTERATI GRANITE (HM03)

- TONE ATTACHÉ' COLLECTION SUPERIOR TAUPE (DR08)
- STONE ATTACHÉ' COLLECTION
- NATURAL VARIATIONS MAPLE (NMP)

SUPERIOR TAUPE (DR08)

COLOR SELECTION | FINISH


EIDER WHITE (SW 7014) | HIGH GLOSS


VENETIA CREAM | SINGLE POLISHED


HIGH REFLECTIVE WHITE (SW 7757) | HIGH GLOSS

DAINTREE (8235K-05) TIMBERGRAIN FINISH WITH 'AEON' | #60 MATTE FINISH



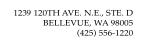


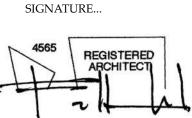


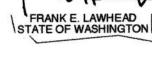

+---OWNER...



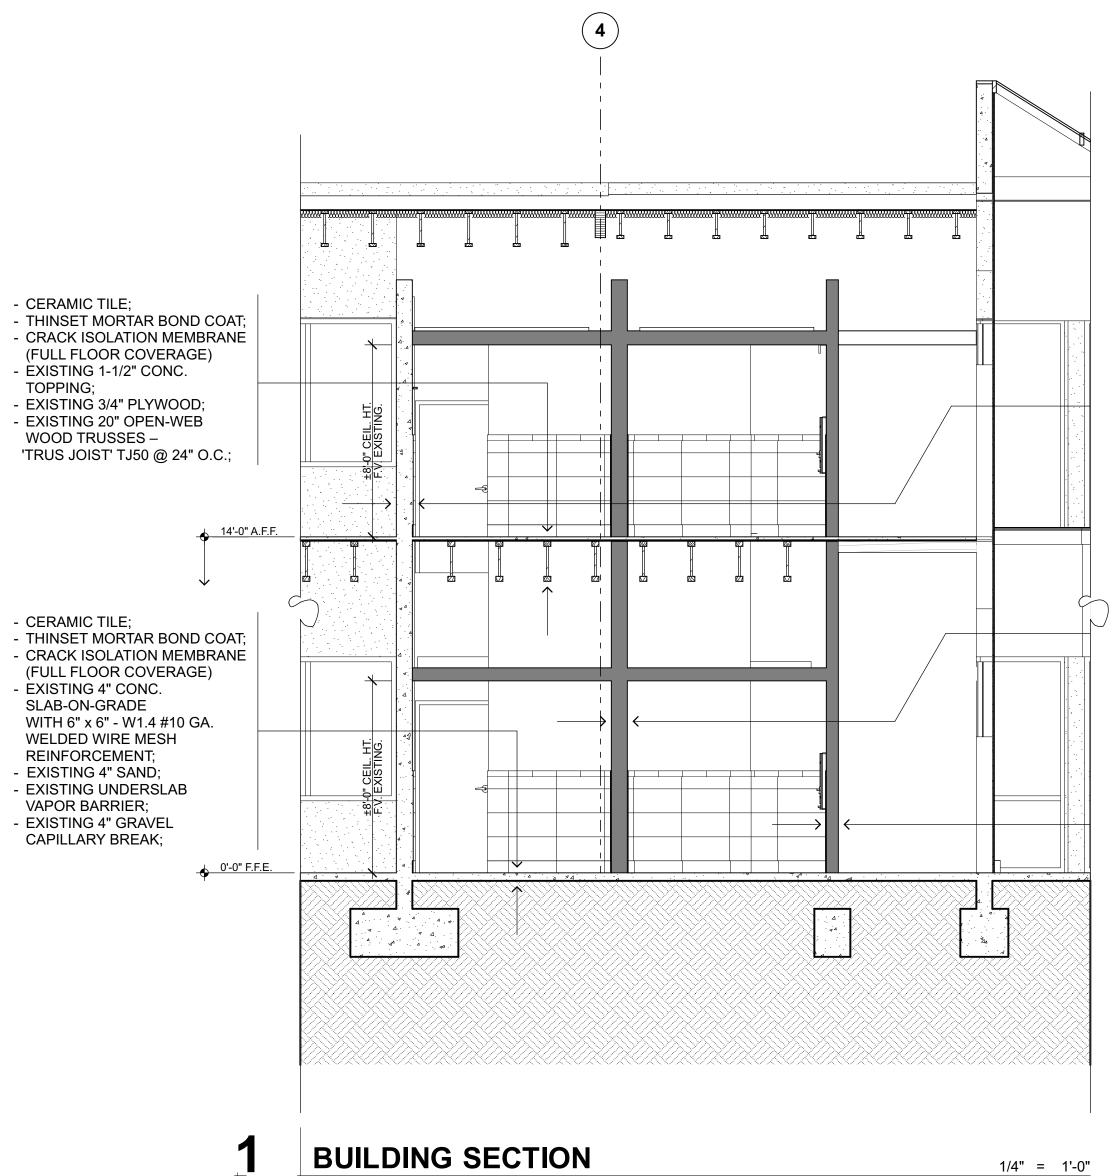


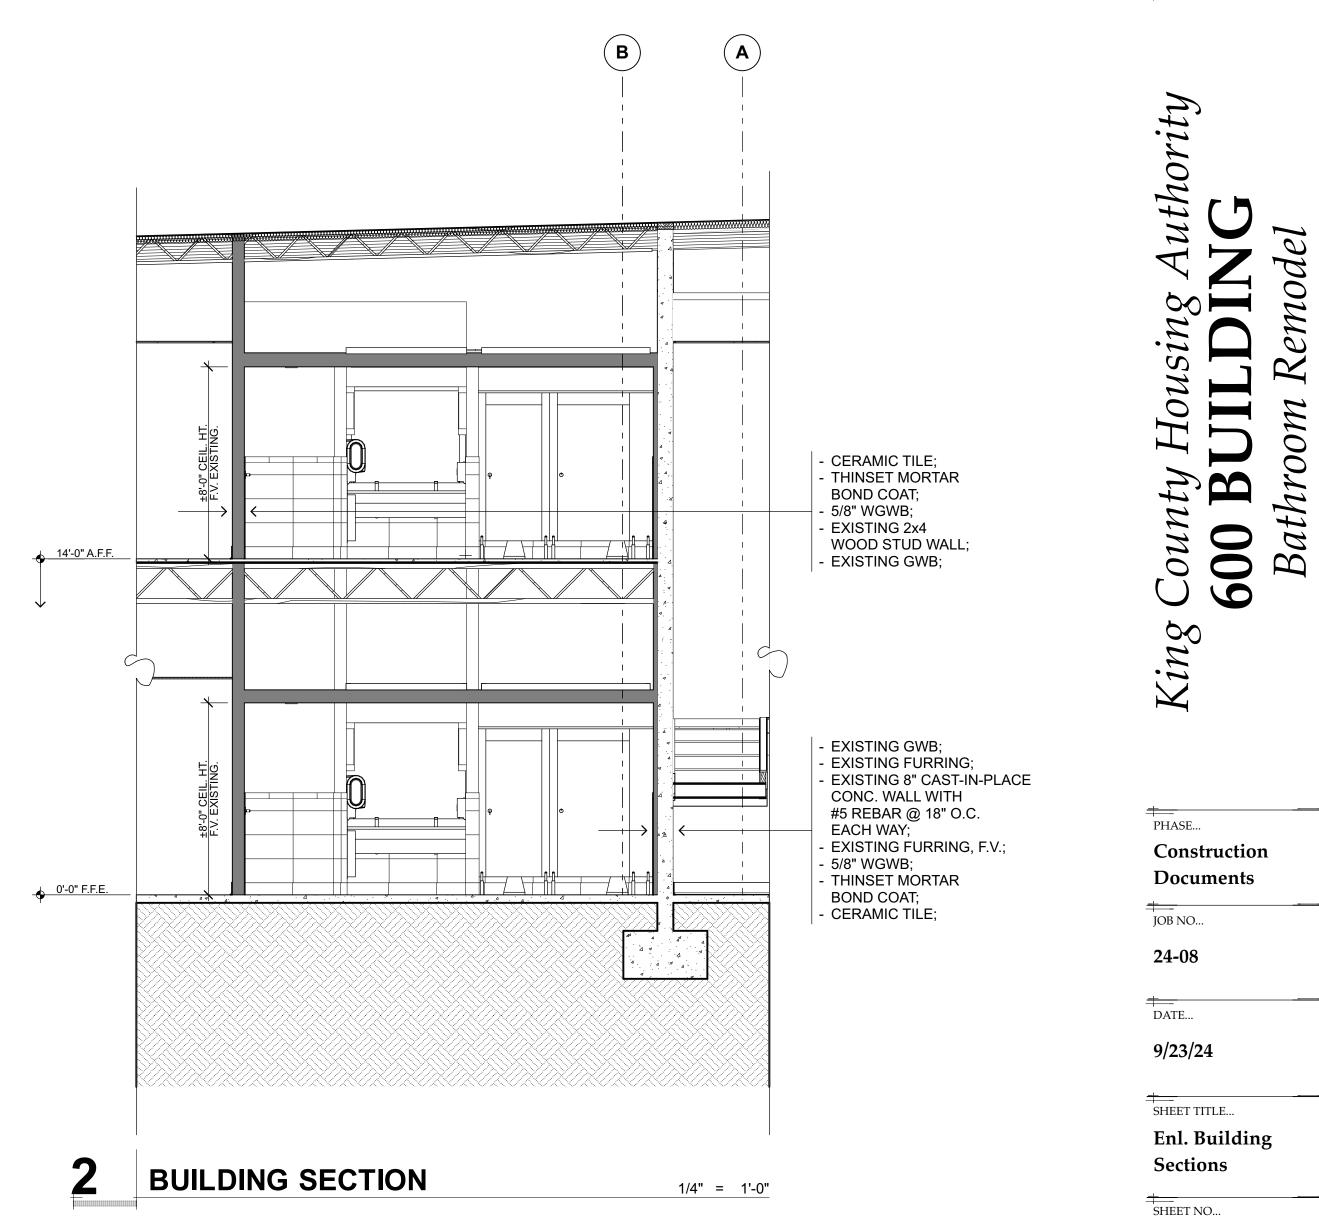


1/4" = 1'-0"

GENERAL NOTES:

- 1. SEE MECHANICAL & ELECTRICAL FOR ADDITIONAL INFORMATION NOT SHOWN HERE.
- 2. FIELD VERIFY ALL EXISTING DIMENSIONS.
- FIELD VERIFY ALL EXISTING CONSTRUCTION. IMMEDIATELY REPORT ANY DISCREPANCIES FOUND TO ARCHITECT OR OWNER'S REPRESENTATIVE.

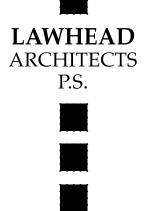





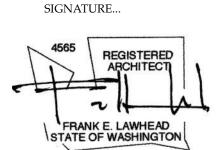








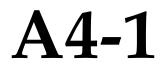

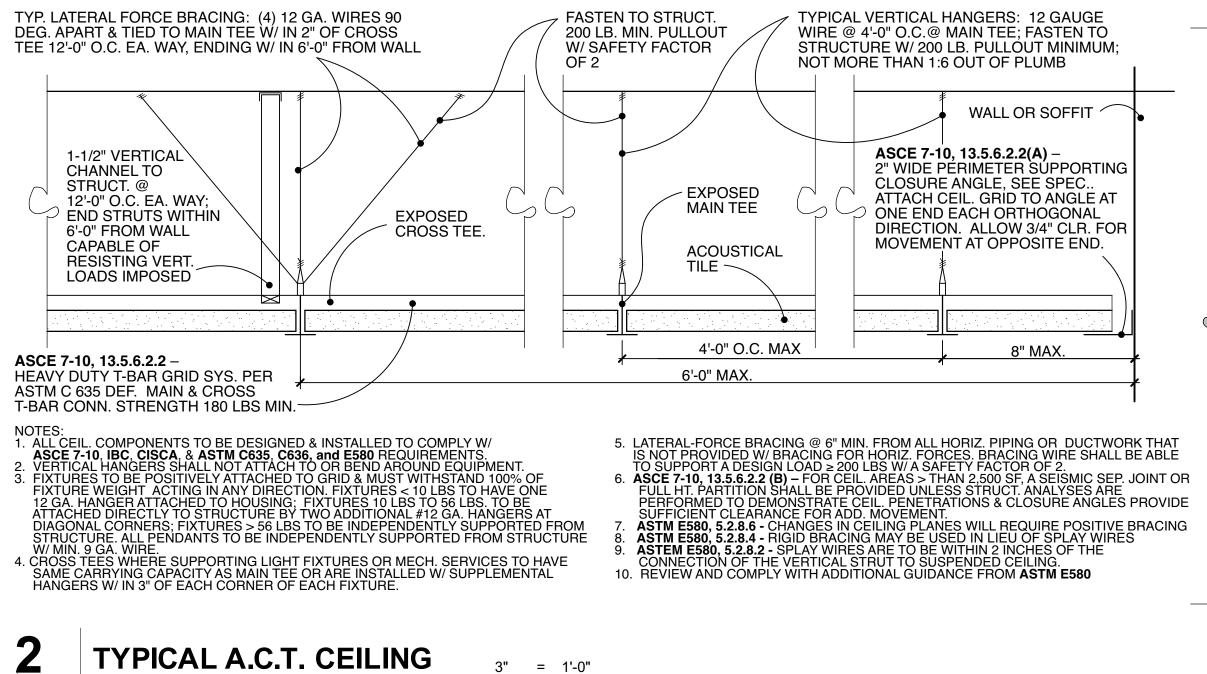

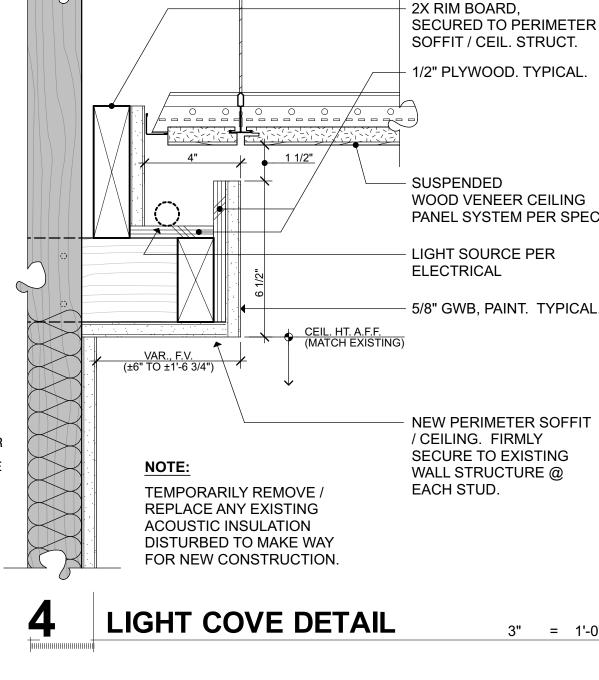

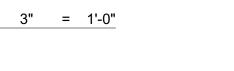

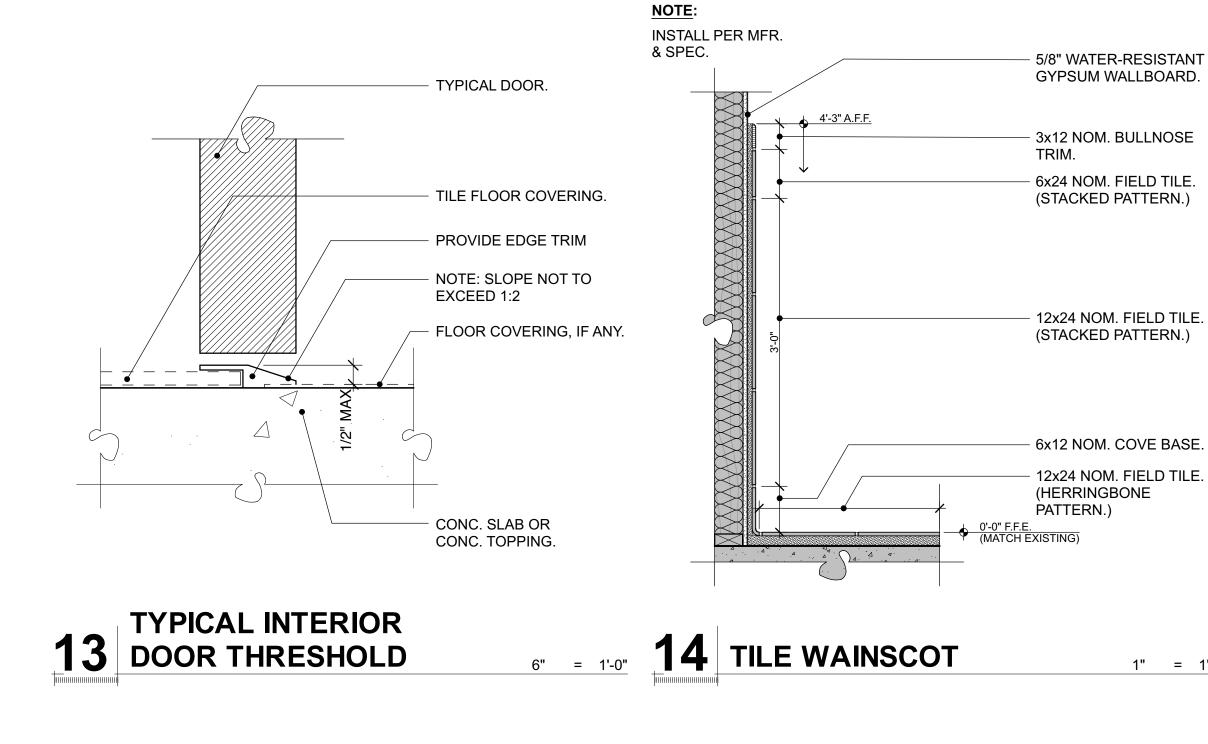

- 1. SEE MECHANICAL & ELECTRICAL DRAWINGS FOR ADDITIONAL INFORMATION NOT SHOWN HERE.
- 2. FIELD VERIFY ALL EXISTING DIMENSIONS.

1/2" PLYWOOD. TYPICAL.

WOOD VENEER CEILING PANEL SYSTEM PER SPEC.


- LIGHT SOURCE PER

- 5/8" GWB, PAINT. TYPICAL

NEW PERIMETER SOFFIT / CEILING. FIRMLY SECURE TO EXISTING WALL STRUCTURE @

3" = 1'-0"

- EXISTING CONSTRUCTION SHOWN SHADED

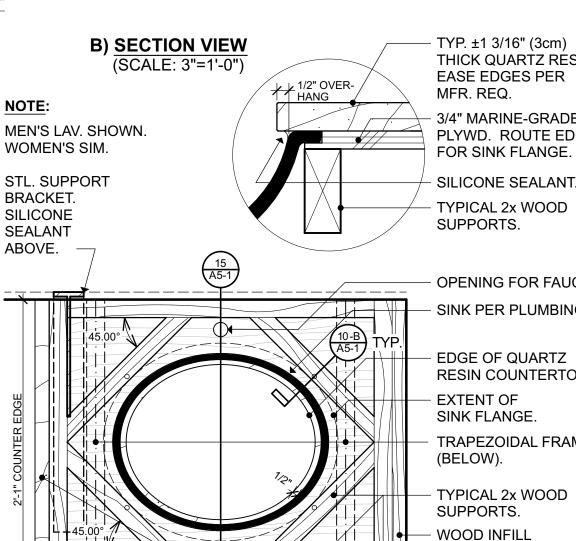

2'-0" O.C. MAX. A) RCP VIEW

1 1/2" OVER-HANG

- TYP. ±1 3/16" (3cm) THICK QUARTZ RESIN. EASE EDGES PER MFR. REQ. 3/4" MARINE-GRADE PLYWD. ROUTE EDGE

SILICONE SEALANT. TYPICAL 2x WOOD SUPPORTS.


OPENING FOR FAUCET. SINK PER PLUMBING

EDGE OF QUARTZ RESIN COUNTERTOP. EXTENT OF SINK FLANGE.


TRAPEZOIDAL FRAME (BELOW).

TYPICAL 2x WOOD SUPPORTS. WOOD INFILL AT WALL LEDGER. 5" HIGH QUARTZ RESIN SKIRT ON EXP. EDGES. MECH. SECURED.

10 LAVATORY SINK PLAN 1 1/2"= 1'-0" OPENING FOR FAUCET (NOT SHOWN).

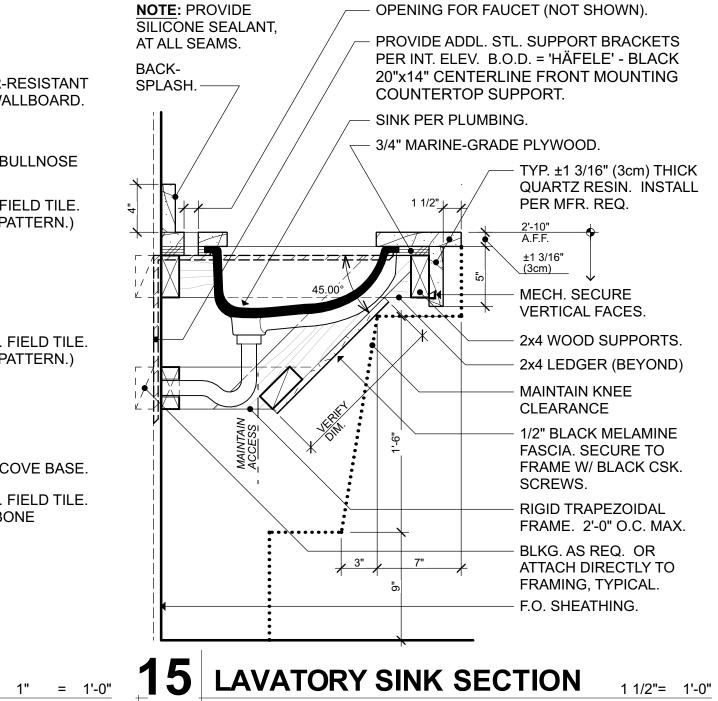



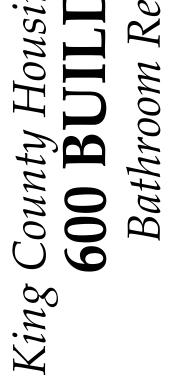

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24-08


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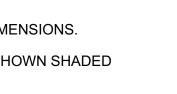
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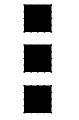
Interior Details

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LAWHEAD ARCHITECTS P.S.



1239 120TH AVE. N.E., STE. D

REGISTERE
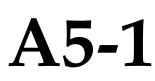
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FRANK E. LAWHEAD

STATE OF WASHINGTON

ABCHITEC

SIGNATURE ...

4565

+

OWNER...

BELLEVUE, WA 98005

(425) 556-1220

King County

Housing

Authorit





GENERAL MECHANICAL DEMOLITION NOTES

- DEMOLITION DRAWINGS ARE INTENDED TO ONLY GIVE A GENERAL REPRESENTATION OF THE 1. DEMOLITION INVOLVED, AND DO NOT CONSTITUTE A FULL LISTING OF ALL ITEMS REQUIRING REMOVAL. SEE SPECIFICATIONS & THESE GENERAL NOTES FOR REQUIREMENTS.
- 2. IT IS THE CONTRACTOR'S RESPONSIBILITY TO REVIEW SITE CONDITIONS AND TO IDENTIFY ALL DEMOLITION WORK, AND INCLUDE IN HIS BID ALL COSTS FOR DEMOLITION & DISPOSAL.
- EXISTING DUCTS, EQUIPMENT, PIPING, AIR INLETS/OUTLETS, PLUMBING FIXTURES SHOWN DASHED REPRESENT MAJOR MECHANICAL ITEMS TO BE REMOVED. SEE GENERAL NOTES, DRAWING NOTES & KEYED NOTES WHICH COVER ALL OTHER MISC. MECHANICAL ITEMS TO BE REMOVED.
- 4. ALL EXISTING ITEMS NOT BEING REUSED SHALL BE REMOVED. THIS INCLUDES SUCH ITEMS AS THERMOSTATS, CONTROL DEVICES, DUCTS, FANS, PIPING, GRILLES, SUPPORTS, VALVES, CURBS, AND RELATED ACCESSORIES.
- 5. PATCH ALL WALL/FLOOR/CEILING OPENINGS LEFT BY REMOVAL OF EXISTING ITEMS. PATCH SO AS TO MATCH FINISH OF ADJACENT UNDISTURBED AREA.
- REFERENCE ARCHITECTURAL DRAWINGS FOR WHERE CEILING/WALL AND OTHER GENERAL 6. DEMOLITION WORK IS BEING DONE.
- SEE MECHANICAL FLOOR PLANS FOR HVAC DUCTS THAT ARE BEING REUSED.
- WHERE EXISTING PLUMBING FIXTURES ARE REMOVED, CAP OFF CW, HW, VENT & WASTE PIPING AT A 8. CONCEALED LOCATION (I.E. ABOVE CEILING OR INSIDE WALL).
- 9. PROVIDE TEMPORARY CAP-OFF OF ALL EXIST. SYSTEMS TO ALLOW CONTINUED USE OF ALL SYSTEMS UNTIL THE FINAL SYSTEM COMPONENTS ARE INSTALLED AND CONNECTED (INCLUDE HWS/HWR AT EACH RHI, RHU; FIRE SPRINKLERING, ETC.).
- 10. VERIFY SIZE & LOCATION OF ALL EXISTING ITEMS SHOWN TO BE DEMO'D. LOCATIONS SHOWN ARE APPROXIMATE AND ARE BASED ON OWNER'S AS-BUILTS.


MECHANICAL GENERAL NOTES

- 1. ALL ITEMS ARE NEW UNLESS SPECIFICALLY NOTED AS EXISTING.
- 2. FIXTURE LOCATIONS: VERIFY LOCATION OF PLUMBING FIXTURES WITH ARCHITECTURAL DRAWINGS BEFORE BEGINNING WORK. ARCHITECTURAL DRAWINGS GOVERN. PLUMBING FIXTURE HEIGHTS SHALL BE AS SHOWN ON ARCHITECTURAL DRAWINGS.
- 3. ALL PIPING & DUCTWORK SHOWN IS SCHEMATIC, CONTRACTOR SHALL PROVIDE ALL OFFSETS/ELBOWS AS REQ'D TO ALLOW ROUTING AROUND STRUCTURE, ELECTRICAL, & OTHER INTERFERENCES.
- 4. BUILDING FEATURES AND PIPING LOCATIONS & SIZES SHOWN ON PLANS ARE APPROXIMATE & ARE BASED ON AS-BUILT DATA PROVIDED BY THE OWNER, A COMPLETE REVIEW IS REQUIRED TO BE MADE BY THE CONTRACTOR. VERIFY SIZES PRIOR TO BIDDING AND BEGINNING WORK.
- 5. CONTRACTOR SHALL VERIFY LOCATIONS OF ALL EXISTING EQUIPMENT, PIPING, WALLS, SUPPORTS, ELECTRICAL AND RELATED BUILDING FEATURES AND RELOCATE/REVISE SUCH EXISTING ITEMS AS NECESSARY TO ALLOW FOR THE WORK INDICATED.
- 6. CONTRACTOR SHALL FIELD VERIFY THE SIZES AND LOCATIONS OF ALL EXISTING ITEMS SHOWN BEING CONNECTED TO. VERIFICATION SHALL OCCUR PRIOR TO MATERIALS BEING ORDERED OR FABRICATED.
- 7. CONTRACTOR SHALL VISIT THE SITE PRIOR TO BIDDING TO REVIEW AND VERIFY EXISTING CONDITIONS AND CONSTRUCTION MATERIALS, INCLUDING, BUT NOT LIMITED TO, ALL WALLS, FLOORS, CEILINGS, AND OTHER AREAS THAT MAY BE DISTURBED DURING CONSTRUCTION IN ORDER TO ACCOMPLISH THE WORK IN THESE DOCUMENTS. THE CONTRACTOR SHALL ALSO VISIT THE SITE AGAIN PRIOR TO BEGINNING ANY WORK.
- 8. PROVIDE PIPING TRANSITIONS AS NECESSARY TO CONNECT TO EXISTING SYSTEMS. SUCH SYSTEMS SHALL BE FIELD REVIEWED FOR SIZE, DIRECTION OF FLOW, LOCATION AND TYPE PRIOR TO ORDERING/FABRICATING SUCH TRANSITIONS BECAUSE OWNER PROVIDED AS-BUILT DRAWINGS THAT SHOW SUCH INFORMATION ARE CONSIDERED APPROXIMATE. CONTRACTOR SHALL ASSUME IN HIS BID ONE TRANSITION FOR EACH CONNECTION TO EXISTING SYSTEMS. PIPING CONNECTIONS ON EXISTING ITEMS MAY BE ONE PIPE SIZE SMALLER OR LARGER THAN SHOWN.

FIRE SPRINKLER NOTES

- 1. FIRE SPRINKLER SYSTEM & WORK IS CONTRACTOR DESIGN/BUILD.
- 2. BUILDING HAS AN EXISTING FIRE SPRINKLER SYSTEM.
- 3. PROVIDE MODIFICATIONS TO (E) SYSTEM TO ACCOMMODATE REVISED CEILING AND OTHER WORK. SEE ARCHITECTURAL DRAWINGS.
- 4. REVIEW ARCHITECTURAL AND ALL OTHER DRAWINGS FOR BUILDING DETAILS AND LAYOUT.
- 5. COORDINATE WITH ALL TRADES IN ROUTING OF SPRINKLER PIPING TO AVOID CONFLICTS. FIRE PROTECTION SYSTEM HAS THE LOWEST PRIORITY OF ITEMS RAN IN THE CEILING. PROVIDE OFFSETS AS REQUIRED.
- 6. ALL FIRE SPRINKLER HEADS SERVING OCCUPIED AREAS OF THE BLDG SHALL BE QUICK RESPONSE TYPE.
- 7. ALL FIRE SPRINKLER HEADS SHALL BE LOCATED TO BE SYMMETRICAL WITHIN SPACES SERVED AND BUILDING ARCHITECTURAL FEATURES.
- 8. PIPING SHALL BE RAN CONCEALED.

| MECHANICAL LEGEND | | | | | | |
|----------------------|------------------------------------------------|---------------|-------------------------------------------------------|--|--|--|
| SYMBOL | DESCRIPTION | SYMBOL | DESCRIPTION | | | |
| | WASTE OR SOIL (W) | AFF AHJ | ABOVE FINISHED FLOOR AUTHORITY HAVING JURISDICTION | | | |
| | VENT (V) | APPROX | APPROXIMATELY | | | |
| | COLD WATER (CW) | ARCH ASSY | ARCHITECTURAL ASSEMBLY | | | |
| | HOT WATER (HW) | BDD | BACKDRAFT DAMPER | | | |
| | HOT WATER CIRCULATING (HWC) | B.O.D. BTU | BOTTOM OF DUCT BRITISH THERMAL UNIT | | | |
| | | BTUH BLDG | BRITISH THERMAL UNIT/HOUR BUILDING | | | |
| ۲ | FLOOR CLEANOUT (FCO) OR SURFACE CLEANOUT (SCO) | CAP | CAPACITY | | | |
| | ISOLATION VALVE | CLG CO | CEILING CLEANOUT | | | |
| O | PIPE UP | COP | COEFFICIENT OF PERFORMANCE | | | |
|) | PIPE DOWN | COMP CONN | COMPRESSOR CONNECTION | | | |
| | PIPE TEE IN LINE, BRANCH PIPE DOWN | CONT CFH | CONTINUE, CONTINUATION CUBIC FEET PER HOUR | | | |
| 20/12 | | CFH CFM | CUBIC FEET PER MINUTE | | | |
| | DUCT (FIRST FIGURE, SIDE SHOWN) | CW CWV | COLD WATER COMBINATION WASTE/VENT | | | |
| | DUCT SECTION (EXHAUST OR RETURN) | DEG F, °F | DEGREE FAHRENHEIT | | | |
| | VOLUME DAMPER (MANUAL) | DIA, Ø DN | DIAMETER DOWN | | | |
| | ELBOW WITH TURNING VANES | DWG | DRAWING | | | |
| | DUCT UP (RECTANGULAR) | DB EA | DRY BULB EACH | | | |
| | | ECM | ELECTRONIC COMMUTATED MOTOR | | | |
| | DUCT DOWN (RECTANGULAR) | EF EFF | EXHAUST FAN EFFICIENCY | | | |
| SIZE,SYMBO | | ELEC | ELECTRICAL, ELECTRIC | | | |
| | | EER EAT | ENERGY EFFICIENCY RATIO ENTERING AIR TEMPERATURE | | | |
| | | EWB | ENTERING WET BULB | | | |
| | | EDB EOL | ENTERING DRY BULB END OF LINING | | | |
| | | EXH | EXHAUST | | | |
| | | ESP FV | EXTERNAL STATIC PRESSURE FACE VELOCITY | | | |
| | | FPM | FEET PER MINUTE | | | |
| | | FLEX | FLEXIBLE FLOOR | | | |
| | | FCO | FLOOR CLEAN OUT | | | |
| | | FLA GAL | FULL LOAD AMPS GALLON | | | |
| | | HP | HORSE POWER | | | |
| | | HW HWC | HOT WATER HOT WATER CIRCULATION | | | |
| | | INTEGR. IN | INTEGRAL INCH | | | |
| | | KW | KILOWATT | | | |
| | | L LAT | LINING LEAVING AIR TEMPERATURE | | | |
| | | | LEAVING ARY BULB | | | |
| | | LWT LWB | LEAVING WATER TEMPERATURE LEAVING WET BULB | | | |
| | | MAX | MAXIMUM | | | |
| | | MFR MBH | MANUFACTURER THOUSAND BTUH | | | |
| | | MCA | MINIMUM CIRCUIT AMPACITY | | | |
| | | OFCI MECH | OWNER FURNISHED, CONTRACTOR INSTALLED MECHANICAL | | | |
| | | MIN | MINIMUM | | | |
| | | NO NTS | NUMBER NOT TO SCALE | | | |
| | | OBD | OPPOSED BLADE DAMPER | | | |
| | | PH PD | PHASE PRESSURE DROP | | | |
| | | — R | RETURN | | | |
| | | REF REL | REFERENCE RELIEF | | | |
| | | RLA | RATED LOAD AMPS | | | |
| | | REQ'D RPM | REQUIRED REVOLUTIONS PER MINUTE | | | |
| | | SCO S.O. | SURFACE CLEANOUT SCREENED OPENING | | | |
| | | | STAINLESS STEEL | | | |
| | | TEMP TD | TEMPERATURE TRANSFER DUCT | | | |
| | | TG | TRANSFER GRILLE | | | |
| | | TYP UG | TYPICAL UNDER GROUND | | | |
| | | UNO | UNLESS NOTED OTHERWISE | | | |
| | | V WC | VOLTS, VOLTAGE, VENT WATER COLUMN | | | |
| | | | WATER COLUMN WALL CLEAN OUT | | | |
| | | W | WASTE WATT | | | |
| 2 | - DETAIL/SECTION IDENTIFICATION NUMBER | WB | WET BULB | | | |
| (<u>2</u> (M3.1) | - SHEET ON WHICH DETAIL IS SHOWN | W/ | WITH | | | |
| | | | | | | |

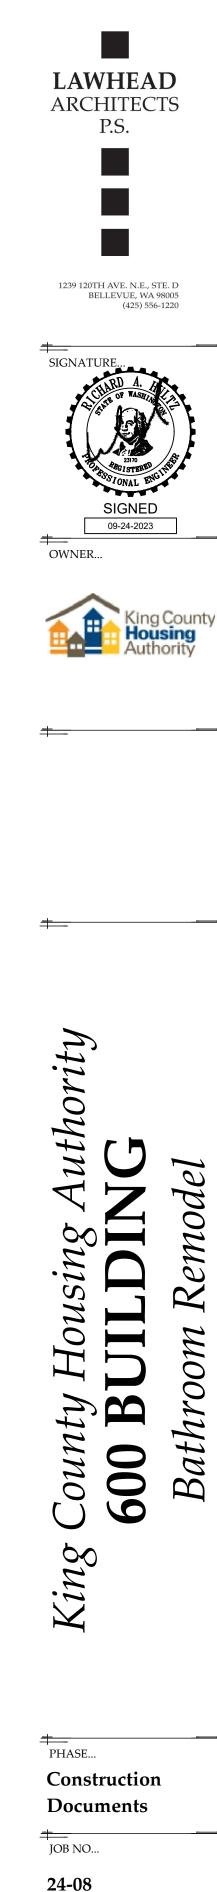

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DATE...

9/23/24

SHEET TITLE ... MECHANICAL LEGEND AND NOTES

SHEET NO...





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| | FAN SCHEDULE | | | | | | | | | | | |
|---------|-----------------------------------------------------------------------------------------------------------|-------------|---------------------------|-----|------|--------------|-----|------------|---------|-----------------|---------|--|
| SYMBOL | BASIS OF DESIGN MANUFACTURER AND SERIES NO. | AREA SERVED | CFM | ESP | MAX | X ELECTRICAL | | DRIVE | CONTROL | MAX WEIGHT | REMARKS | |
| OTMIDOL | | | | | LOP | RPM | HP | VOLTS / PH | | CONTROL | LBS | |
| EF-1 | COOK 100C17DEC | ROOFTOP | FIRST FLOOR RESTROOMS | 650 | 0.5" | 1725 | 1/4 | 115/1 | DIRECT | TIME CONTROL | 50 | |
| EF-2 | COOK 100C17DEC | ROOFTOP | SECOND FLOOR RESTROOMS | 650 | 0.5" | 1725 | 1/4 | 115/1 | DIRECT | TIME CONTROL | 50 | |
| NOTES: | NOTES: 1. PROVIDE FANS WITH EC MOTORS WITH SPEED ADJUSTMENT (MOTOR MOUNTED) OR VARIABLE FREQUENCY DRIVES. | | | | | | | | | | | |


- 2. PROVIDE FANS WITH DISCONNECT.
- 3. PROVIDE ALL ROOFTOP FANS WITH ADAPTER CURBS.

AIR INLET & OUTLET SCHEDULE

| SYMBOL | ТҮРЕ | MANUFACTURER AND SERIES NUMBER | REMARKS | | | | |
|---------------------------------------------------------------------------------|----------------------------|-----------------------------------|--------------------------|--|--|--|--|
| CEG | CEILING EXHAUST GRILLE | KRUEGER SERIES EGC-5 | 1/2"x1/2"x1/2" CUBE CORE | | | | |
| CTG | CEILING TRANSFER GRILLE | KRUEGER SERIES EGC-5 | 1/2"x1/2"x1/2" CUBE CORE | | | | |
| NOTES: | | | | | | | |
| 1. ALL AIR TERMINALS SHALL HAVE FACTORY FINISH, COLOR AS SELECTED BY ARCHITECT. | | | | | | | |
| 2. SEE LEGEND FOR TERMINOLOGY USED IN AIR TERMINAL CALL-OUTS ON DRAWINGS. | | | | | | | |

3. SEE ARCH. FINISH SCHEDULE FOR CEILING TYPES, PROVIDE AIR TERMINALS TO MATCH CEILING CONSTRUCTION INSTALLED IN.


| | PLUMBING FIXTURE SCHEDULE | | | | | | | | |
|--------|---------------------------|--------|--------|------|------|----------------------------------------------------|--|--|--|
| SYMBOL | DESCRIPTION | w | v | cw | нw | REMARKS | | | |
| P-1A | WATER CLOSET | 4" | 2" | 1" | - | FLOOR MOUNT, ADA ACCESSIBLE, SENSOR FLUSH VALVE | | | |
| P-2A | URINAL | - | - | 3/4" | - | (E) FIXTURE, SENSOR FLUSH VALVE REPLACEMENT | | | |
| P-3A | LAVATORY | 1-1/2" | 1-1/2" | 1/2" | 1/2" | UNDERMOUNT, ADA ACCESSIBLE, SENSOR FAUCET | | | |

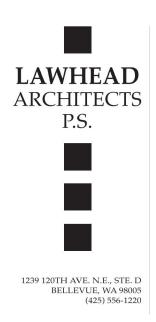





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PHASE...

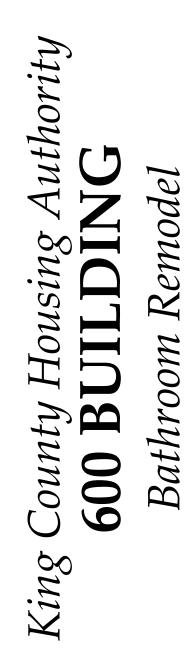Construction Documents

JOB NO...

24-08

DATE... 9/23/24

SHEET TITLE... MECHANICAL SCHEDULES

SHEET NO...







B (\mathbf{A})





RECEPTION


(C)

SCALE: 1/4" = 1'-0"

B A

OFFICE

C

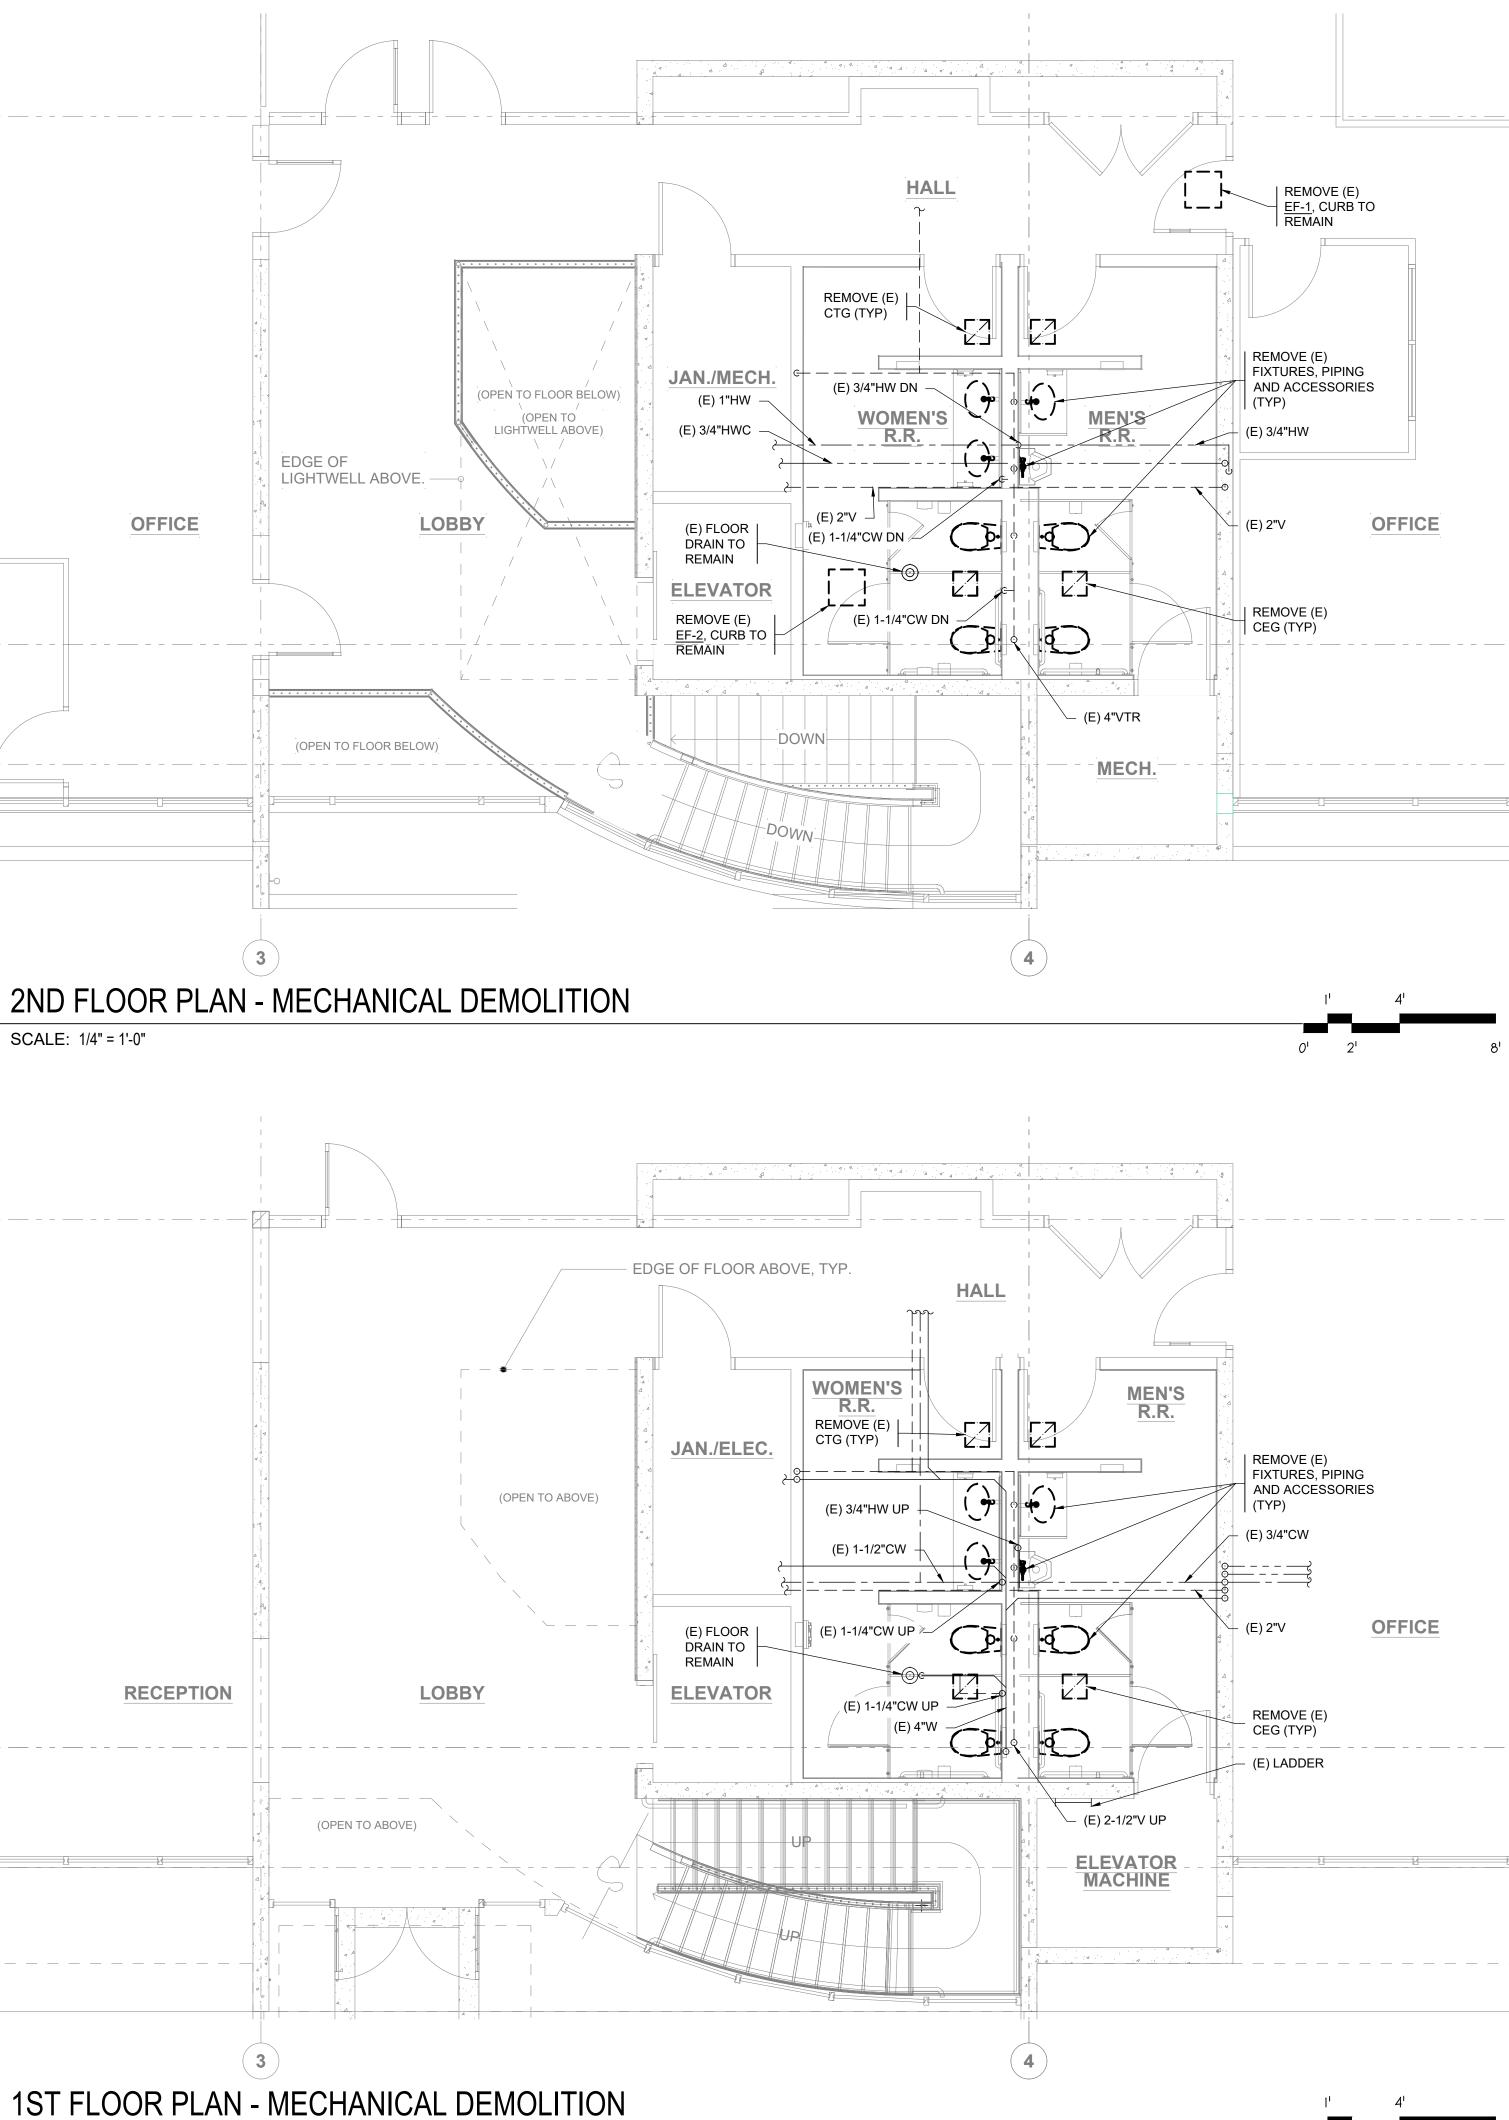

GENERAL NOTES:

1. SEE MECHANICAL GENERAL NOTES AND MECHANICAL DEMOLITION NOTES ON SHEET M0-1.

LAWHEAD ARCHITECTS P.S.









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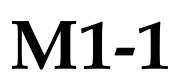
Construction Documents

+---JOB NO... 24-08

____ Date... 9/23/24

SHEET TITLE... ENLARGED DEMOLITION PLANS

SHEET NO...



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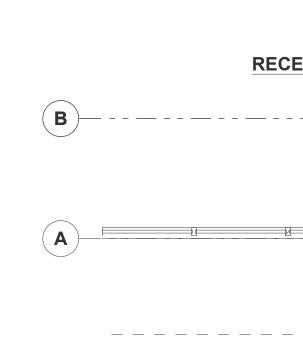
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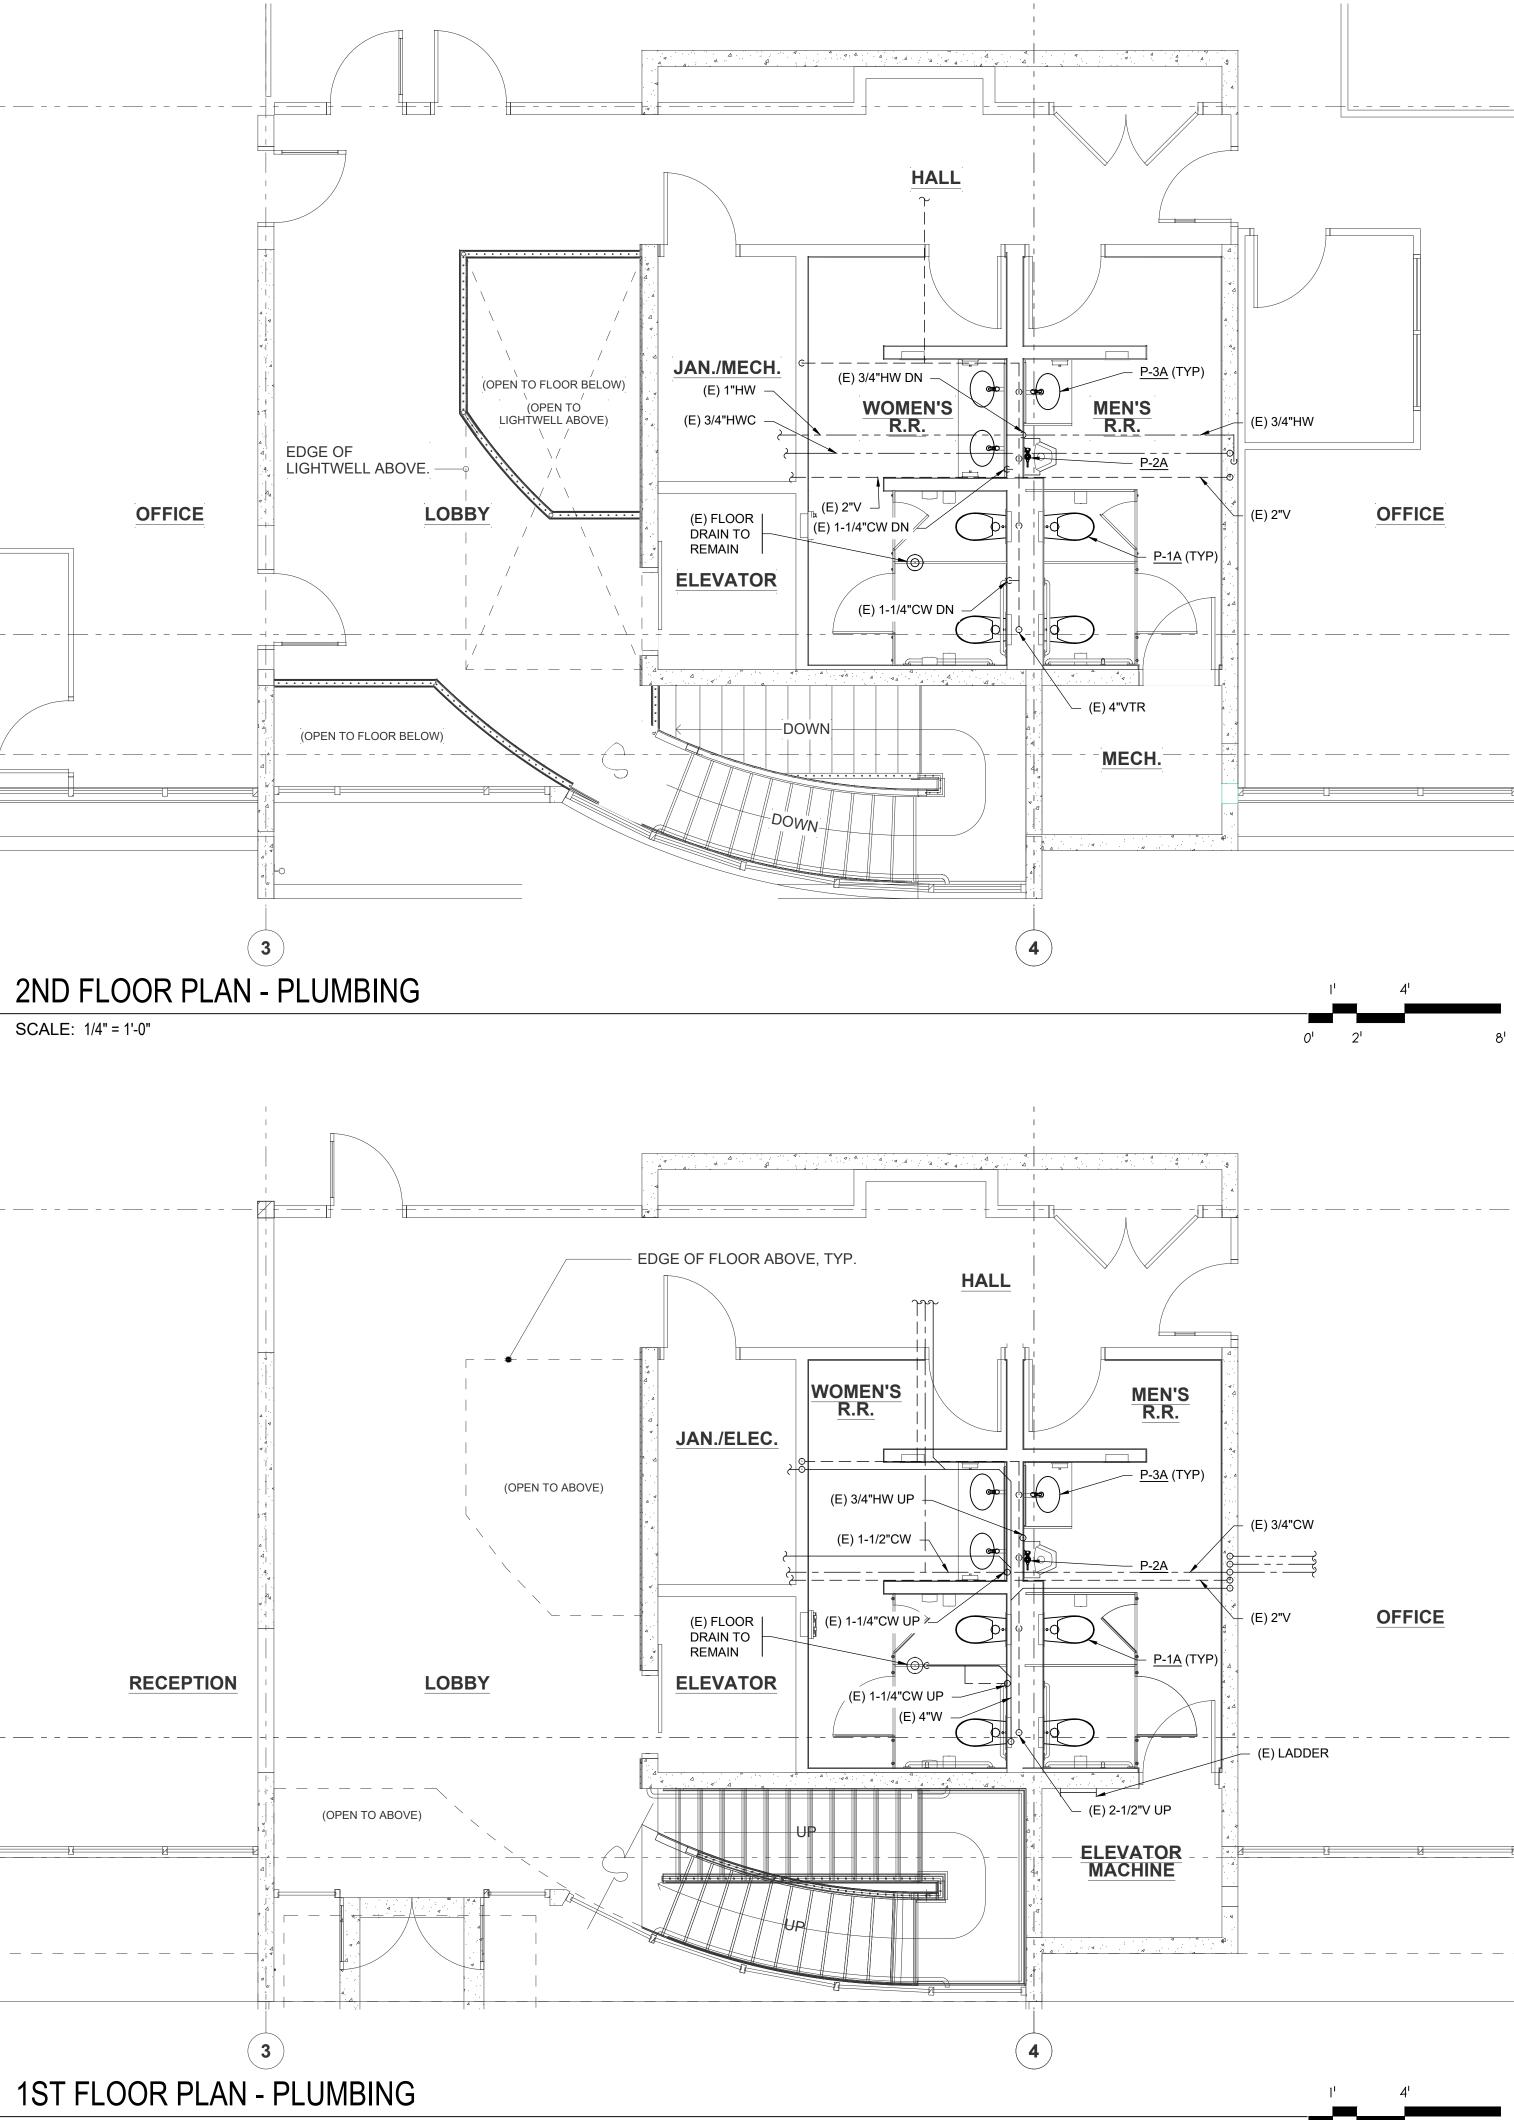














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GENERAL NOTES:

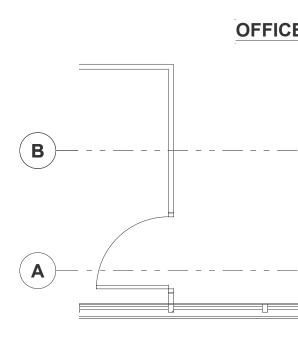- 1. SEE MECHANICAL GENERAL NOTES SEE SHEET M0-1.
- 2. REVISE EXISTING PLUMBING ROUGH-IN AS REQ'D TO ACCOMMODATE NEW FIXTURES.







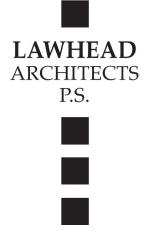



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24-08

DATE... 9/23/24

SHEET TITLE... ENLARGED PLUMBING PLANS

SHEET NO...

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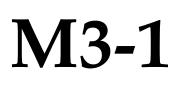
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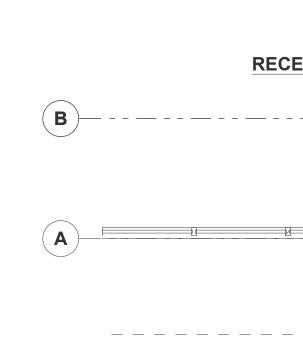
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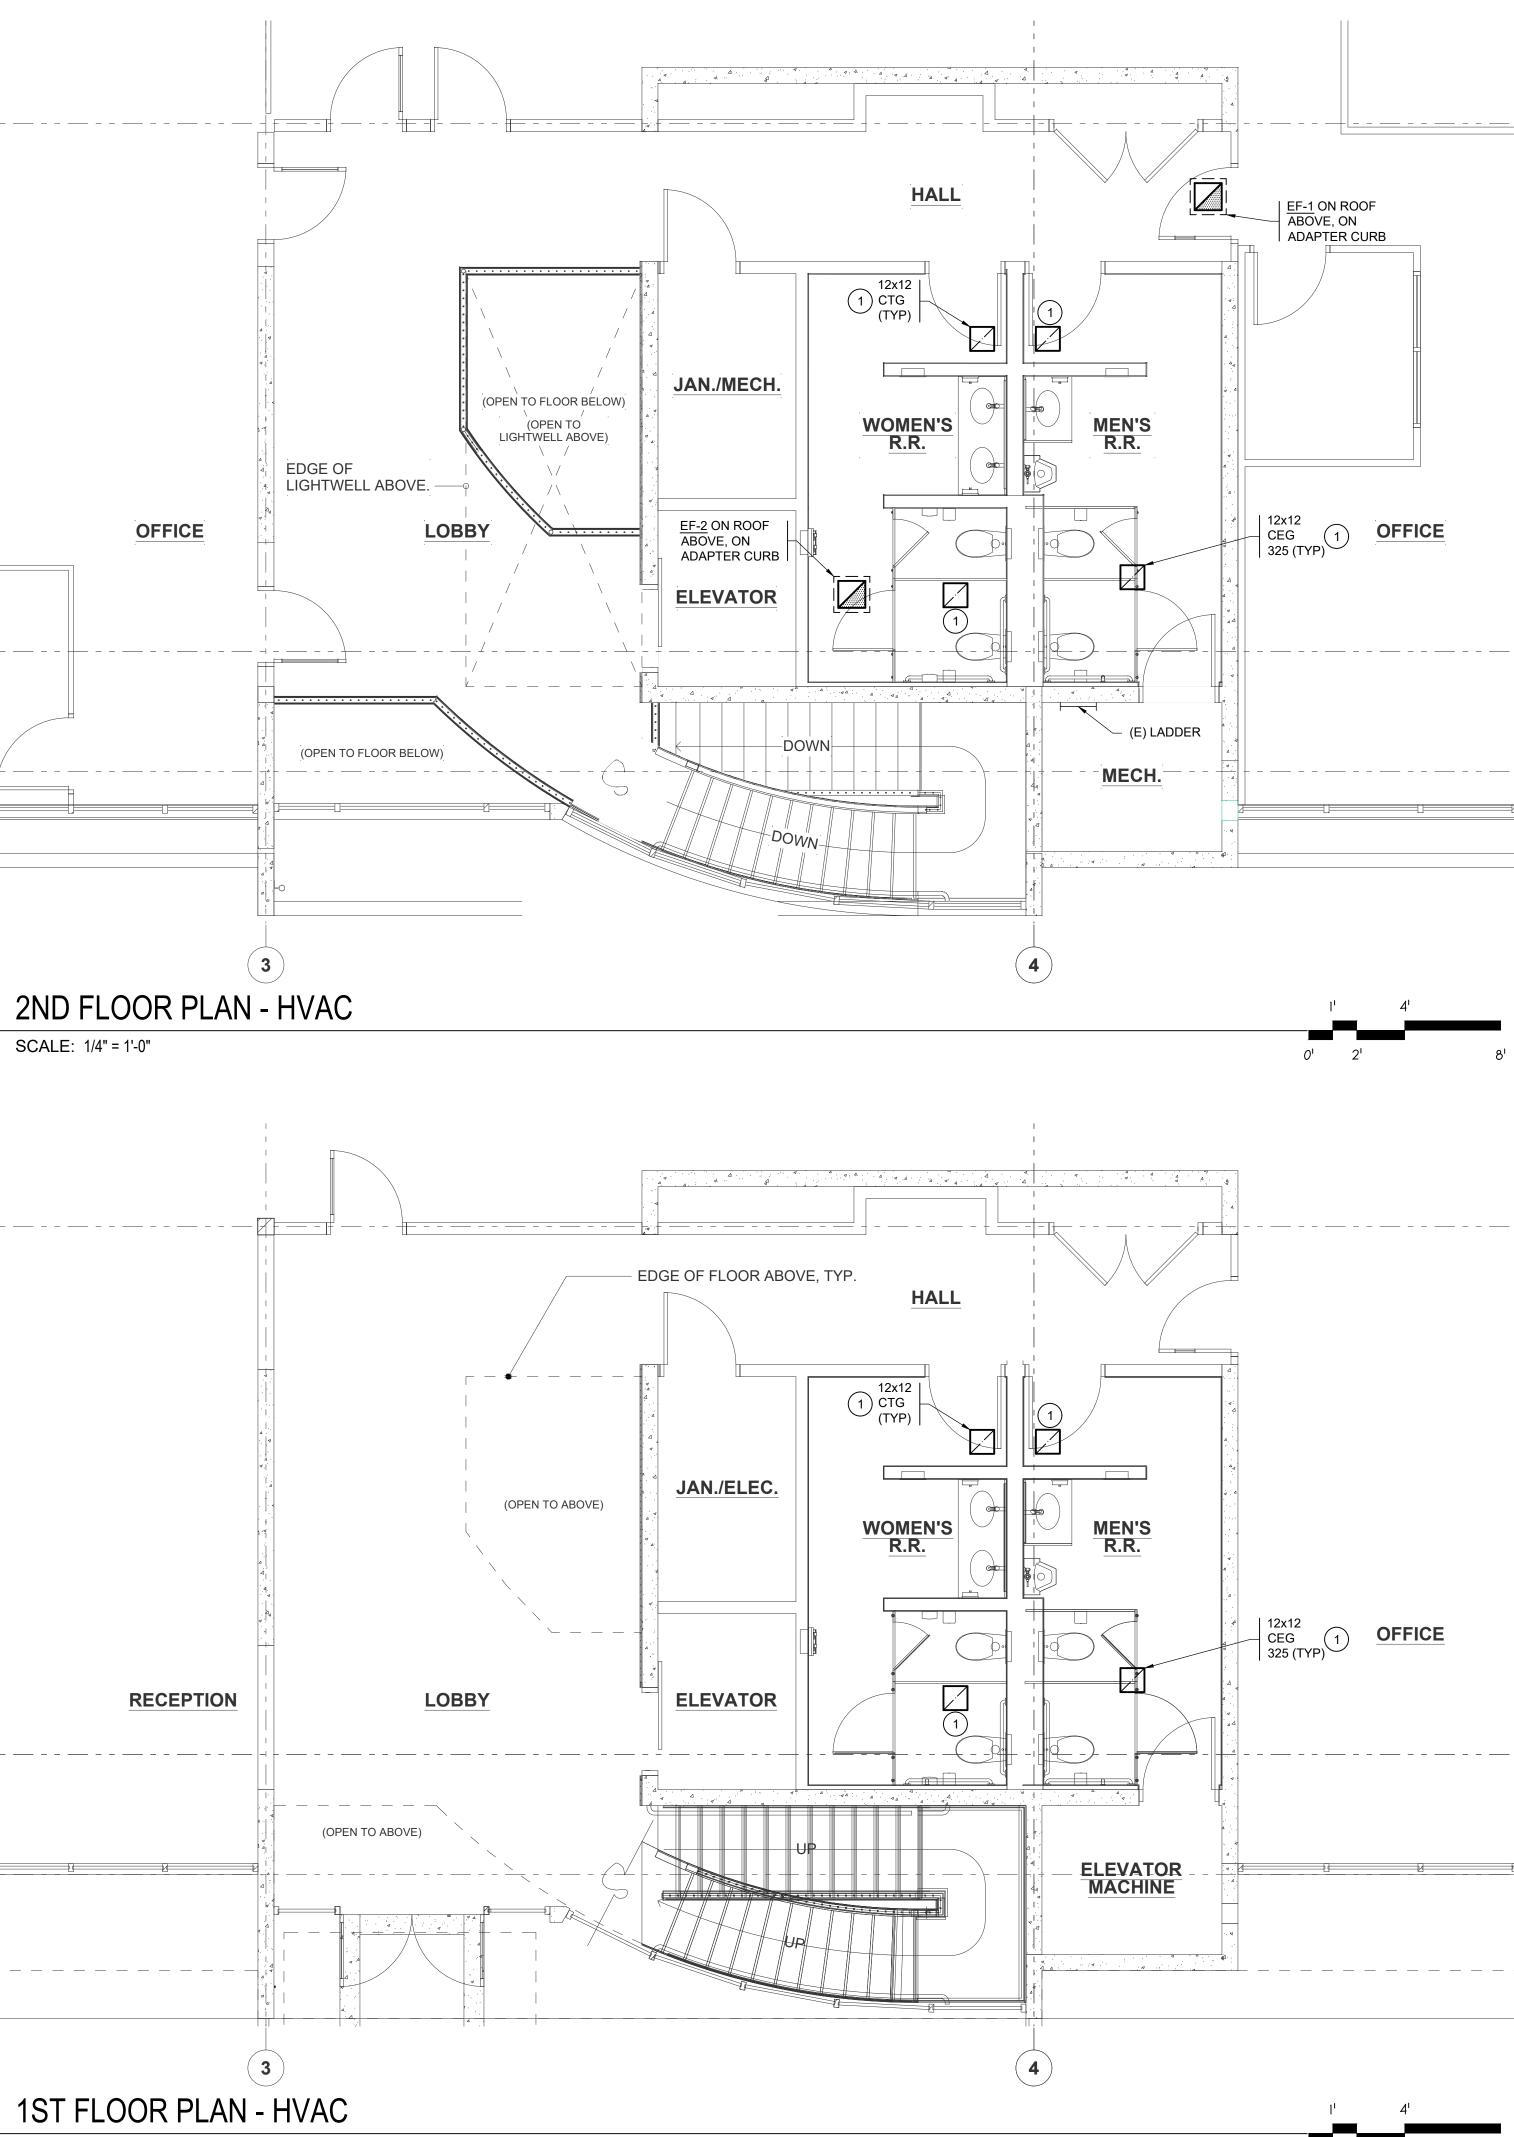













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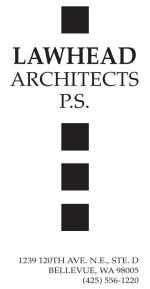
0' 2'

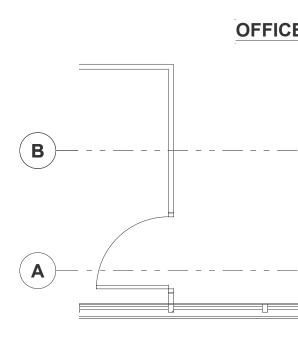GENERAL NOTES:

- 1. SEE MECHANICAL GENERAL NOTES SEE SHEET M0-1.
- 2. NEW EXHAUST FANS TO BE CONTROLLED SAME AS THE EXISTING (RETAIN EXISTING RELAYS/CONTROLS). REVISE AS NEEDED TO OPERATE NEW FANS.

KEYED NOTES:

1 EXTEND/REVISE EXISTING DUCTWORK AS NEEDED TO FIT NEW CEILING. FIELD VERIFY SIZE AND LOCATION.











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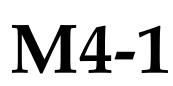
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24-08

DATE... 9/23/24

SHEET TITLE... ENLARGED HVAC PLANS

SHEET NO...



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ABBREVIATIONS

| (SOME ABBREVIATIONS MAY NOT BE USED ON DRAWINGS) | | | | | | | |
|--------------------------------------------------|-----------------------------------------|------------------|----------------------------------------|--|--|--|--|
| ABBREVIATIO N | DESCRIPTION | ABBREVIATIO N | DESCRIPTION | | | | |
| A or AMP | AMPERES | MECH | MECHANICAL | | | | |
| AC | ALTERNATING CURRENT | МН | MANHOLE | | | | |
| A/C | AIR CONDITIONING | MIN | MINIMUM | | | | |
| AIC | AMPERE INTERRUPTING CAPACITY | MLO | MAIN LUGS ONLY | | | | |
| AL | ALUMINUM | MOP, MOCP | MAXIMUM OVERCURRENT PROTECTION | | | | |
| ARCH | ARCHITECTURAL | MTD | MOUNTED | | | | |
| ATC | AUTOMATIC TEMPERATURE CONTROL | MTG | MOUNTING | | | | |
| ATS | AUTOMATIC TRANSFER SWITCH | NC | NORMALLY CLOSED | | | | |
| AWG | AMERICAN WIRE GAUGE | N, NEUT | NEUTRAL | | | | |
| BIL | | NIC | NOT IN CONTRACT | | | | |
| BKR | BREAKER | NO | | | | | |
| BLDG | BUILDING | NTS | NOT TO SCALE | | | | |
| C C O | | | | | | | |
| C.O. °C | | OD | | | | | |
| СВ | DEGREES CELSIUS CIRCUIT BREAKER | OH PA | OVERHEAD PUBLIC ADDRESS | | | | |
| CCTV | CLOSED CIRCUIT TELEVISION | PB | PULLBOX | | | | |
| CFM | CUBIC FEET PER MINUTE | PF | POWER FACTOR | | | | |
| CKT | CIRCUIT | Ø or PH | PHASE | | | | |
| CL | CENTER LINE | PNL | PHASE | | | | |
| CLG | CEILING | PNL PR | PANEL | | | | |
| CONC | CONCRETE | PRI | PRIMARY | | | | |
| CT | CURRENT TRANSFORMER | PT | POTENTIAL TRANSFORMER | | | | |
| CU | COPPER | PT PVC | POLYVINYL CHLORIDE | | | | |
| | COPPER COLD WATER | | RECEPTACLE | | | | |
| CW BD | DECIBELS | RECPT REQ | REQUIRED | | | | |
| | | | | | | | |
| DC DIA | DIRECT CURRENT DIAMETER | RF RM | RADIO FREQUENCY ROOM | | | | |
| DIA DIV | DIVISION | RMS | ROOM ROOT MEAN SQUARE | | | | |
| DPDT | DOUBLE POLE, DOUBLE THROW | SEC | SECONDARY | | | | |
| DPDT | DOUBLE POLE, SINGLE THROW | SEC | SHEET | | | | |
| DWG | DRAWING | SMR | SURFACE METAL RACEWAY | | | | |
| EGC | EQUIPMENT GROUND CONDUCTOR | SMR | SOLID NEUTRAL | | | | |
| ELEC | ELECTRIC | SP | SINGLE POLE | | | | |
| ELEC | ELECTRICAL METALLIC TUBING | SPD | SINGLE POLE SURGE PROTECTIVE DEVICE | | | | |
| EXST, (E) | EXISTING | SPD | SINGLE POLE, DOUBLE THROW | | | | |
| ETR | EXISTING EXISTING TO REMAIN | SPDT | SINGLE POLE, SINGLE THROW | | | | |
| °F | DEGREES FAHRENHEIT | SFST | STAINLESS STEEL | | | | |
| FA | FIRE ALARM | STD | STANDARD | | | | |
| FC | FOOTCANDLE | SW | SWITCH | | | | |
| FLA | FULL LOAD AMPS | SWBD | SWITCHBOARD | | | | |
| FLEX | FLEXIBLE CONDUIT | TEL | TELEPHONE | | | | |
| GALV | GALVANIZED | TV | TELEVISION | | | | |
| GFCI | GROUND FAULT CIRCUIT INTERRUPTER | TTB | TELECOMMUNICATIONS TERMINAL BOARD | | | | |
| GND | GROUND | TYP | TYPICAL | | | | |
| H-O-A | HAND - OFF - AUTO | UL | UNDERWRITERS LABORATORY | | | | |
| HP | HORSEPOWER | UF | UNDERFLOOR | | | | |
| HPF | HIGH POWER FACTOR | UG | UNDERGROUND | | | | |
| H & V | HEATING AND VENTILATION | v v | VOLTS | | | | |
| | | | | | | | |
| HVAC | HEATING, VENTILATION & AIR CONDITIONING | VA | VOLT AMPERES | | | | |
| HZ | HERTZ | VAC | VOLTS ALTERNATING CURRENT | | | | |
| IDF | INTERMEDIATE DISTRIBUTION FRAME | VAR | REACTIVE VOLT AMPERES | | | | |
| J-BOX | JUNCTION BOX | VAV | VARIABLE AIR VOLUME | | | | |
| KV | KILOVOLTS | VD | VOLTAGE DROP | | | | |
| KVA | KILOVOLT AMPERES | VDC | VOLTS DIRECT CURRENT | | | | |
| KVAR | REACTIVE KILOVOLT AMPERES | VFD | VARIABLE FREQUENCY DRIVE | | | | |
| KW | KILOWATTS | VT | VAPORTIGHT | | | | |
| KWH | KILOWATT HOURS | W | WATTS | | | | |
| LT | LIGHT | WP | WEATHERPROOF | | | | |
| LTG | LIGHTING | /w | WITH | | | | |
| MAX | MAXIMUM | W/O | WITHOUT | | | | |
| MCA | MINIMUM CIRCUIT AMPS | XFER | TRANSFER | | | | |
| MCB | MAIN CIRCUIT BREAKER | XFMR | TRANSFORMER | | | | |
| MCC | MOTOR CONTROL CENTER | XLP | CROSS-LINKED POLYETHYLENE | | | | |
| MCM, KCM | THOUSAND CIRCULAR MILS | ХР | EXPLOSION PROOF | | | | |
| | | z | IMPEDANCE | | | | |

| ELECTRICAL LEGEND | | | | | | | |
|----------------------|-------------------------------------------------------------------------------|-----------------|-------------------------------------------------------------------------------------------|--|--|--|--|
| | (SOME SYMBOLS MAY NOT | | , | | | | |
| SYMBOL | DESCRIPTION | SYMBOL | DESCRIPTION | | | | |
| (#) | BUBBLE NOTE TAG SYMBOL: # – IDENTIFYING NUMBER | ₩ L¢ | DUPLEX RECEPTACLE (NEMA 5-20R) | | | | |
| | SCHEDULED EQUIPMENT CONNECTION (INCLUDE | ₩ I | FOURPLEX RECEPTACLE (NEMA 5-20R) | | | | |
| \bigcirc | ALL WIRING, DISCONNECTING MEANS, CONTROL AND OTHER REQUIREMENTS SCHEDULED) | Ħ | GFCI DUPLEX RECEPTACLE (NEMA 5–20R) SUBSCRIPT: REF REFRIGERATOR DW DISHWASHER | | | | |
| 0 | LIGHTING OUTLET - CEILING | | FREZ CHEST FREEZER | | | | |
| | STRIP LUMINAIRE (LENGTH TO SCALE) | | MWO MICROWAVE OVEN | | | | |
| | LUMINAIRE (TO SCALE ON DRAWINGS) | ₩* | ASTERISK INDICATES COUNTER HEIGHT OUTLET (DUPLEX RECEPTACLE SHOWN) | | | | |
| 0 | RECESSED FIXTURE - ROUND | ₩ | DRYER RECEPTACLE (NEMA 14-30R) | | | | |
| \otimes | EXIT FIXTURE LUMINAIRE WITH EMERGENCY | Þ | SPLIT WIRED RECEPTACLE, 1/2 OF RECEPTACLE IS CONTROLLED BY OCCUPANCY SENSOR OR TIMESWITCH | | | | |
| | LIGHTING UNIT | H ≹ | SPLIT WIRED FOURPLEX (1) DUPLEX RECEPTACLE | | | | |
| لې بې | LAY-IN LUMINAIRE EMERGENCY SURFACE FIXTURE | | UNSWITCHED, (1) DUPLEX RECEPTACLE CONTROLLED BY OCCUPANCY SENSOR OR TIME SWITCH | | | | |
| | EMERGENCY FIXTURE - TWIN HEAD | | COPY MACHINE RECEPTACLE (NEMA 5-20R) | | | | |
| \otimes | EXIT FIXTURE | | JUNCTION BOX | | | | |
| S | SINGLE POLE TOGGLE SWITCH | | INDOOR POWER POLE | | | | |
| \$ | DIGITAL SWITCH STATION | Q | MOTOR CONNECTION | | | | |
| \$ _{WP.} S3 | SWITCH SUBSCRIPTS: | | PANELBOARD | | | | |
| ⊤ ₩ F , ⊂ 3 | 2 DOUBLE POLE | | DISCONNECT SWITCH | | | | |
| | 3 THREE WAY 4 FOUR WAY | \square | DRY TYPE TRANSFORMER | | | | |
| | D DIMMER | \triangleleft | DATA (COMPUTER) OUTLET WITH JACK | | | | |
| | EP EXPLOSION PROOF K KEY OPERATED | 200-4-G | FEEDER CALLOUT X-Y-Z. SEE SCHEDULE. | | | | |
| | LV LOW VOLTAGE MASTER | 200/150-3P | DEVICE SIZE / FUSE OR TRIP RATING – No. OF POLES | | | | |
| | M MANUAL MOTOR STARTER W/OVERLOADS MC MOMENTARY CONTACT | ₽ | HEAVY LINE WEIGHT = NEW WORK (RECEPTACLE SHOWN) | | | | |
| | P SWITCH W/PILOT LIGHT T TIMER | Þ | STANDARD LINE WEIGHT = EXISTING TO REMAIN (RECEPTACLE SHOWN) | | | | |
| | WP WEATHERPROOF a, b, c MULTIGANG SWITCH STATION | 中 | BROKEN LINE WORK = ELECTRICAL DEMOLITION (RECEPTACLE SHOWN) | | | | |
| OS | OCCUPANCY SENSOR - CEILING MOUNT | | | | | | |
| igodot | DAYLIGHT SENSOR | | | | | | |

| | MECHANICAL EQUIPMENT CONNECTION SCHEDULE | | | | | | | | | | | | | |
|------|------------------------------------------|----------|-----|-----------------|-----|-----|------|---------|----------------------|----|-------------|----|------|--|
| | | | | MAXIMUM RATINGS | | | | | (CU) FEEDER | | DISCONNECT | | CON | |
| NAME | DESCRIPTION | LOCATION | HP | KVA | FLA | MCA | MOCP | VOLT/PH | #12 EACH PHASE | BY | DESCRIPTION | | STA | |
| | | | | | | | | | + NEUTRAL +GND, UNO. | Ы | | BY | DESC | |
| EF-1 | EXHAUST FAN | ROOF | 1/4 | 0.70 | 5.8 | 7.3 | 15 | 120 1 | 3/4"C-2#12 + #12G | • | TOGGLE | | | |
| EF-2 | EXHAUST FAN | ROOF | 1/4 | 0.70 | 5.8 | 7.3 | 15 | 120 1 | 3/4"C-2#12 + #12G | • | TOGGLE | | | |

QUIPMENT CONNECTION SCHEDULE NOTES:

VERIFY VOLTAGE, PHASE, FLA/MCA OF EACH CONNECTION WITH EQUIPMENT SUPPLIER PRIOR TO ROUGH-IN. NOTIFY ARCHITECT/ENGINEER WHEN SCHEDULED SUPPLY WILL NOT MEET NEC REQUIREMENTS.

DUTLETS, DISCONNECTS, CONTROLLERS, AND EQUIPMENT CONNECTIONS FOR ROOF TOP AND OTHER OUTDOOR EQUIPMENT SHALL BE WEATHER PROOF.

LOCATION OF OUTLETS, DISCONNECTS, CONTROL DEVICES, AND EQUIPMENT CONNECTIONS ARE DIAGRAMMATIC AND TO BE LOCATED IN FIELD BY THE CONTRACTOR AS APPROVED BY THE ENGINEER. UNLESS OTHERWISE INDICATED O NTROL DEVICES IN SIGHT OF EQUIPMENT. ARRANGE WIRING AND EQUIPMENT TO AVOID INTERFERENCE WITH OTHER WORK AND TO MAXIMIZE ACCESSIBILITY FOR MAINTENANCE AND REPAIRS.

COORDINATE WITH THE OTHER INSTALLING CONTRACTORS TO ENSURE NEC REQUIRED ACCESS TO DISCONNECTS IS PROVIDED FOR EACH PIECE OF EQUIPMENT.

PROVIDE SMOKE DUCT DETECTORS IN HEATING AND COOLING SYSTEMS PER INTERNATIONAL MECHANICAL CODE. SEE DIVISION 25 EQUIPMENT SCHEDULES FOR ADDITIONAL UNITS RATED COMBINED 2000 CFM OR GREATER AND PROVIDE DUCT DETECTOR AS REQUIRED.

WIRING BETWEEN EQUIPMENT DISCONNECT AND POINT OF CONNECTION SHALL COMPLY WITH NEC BASED ON EQUIPMENT NAMEPLATE RATING EXCEPT MINIMUM BRANCH CIRCUIT RATING SHALL BE 20 AMPERES.

SIZE OF DISCONNECT SWITCH AND MOTOR STARTER SHALL BE SIZED TO COMPLY WITH NEC REQUIREMENTS. WHERE INDICATED MOTOR CONTROL IS NOT LOCATED IN SIGHT OF MOTOR AS DEFINED BY NEC, PROVIDE ADDITIONAL DISCONNECTING MEANS TO COMPLY WITH NEC 430.102. WIRING SIZES ARE BASED ON 60 DEGREE C. FOR AMPACITIES 100 AMPERES AND LESS. FOR FEEDERS LESS THAN 100 FEET IN LENGTH, CONDUCTOR SIZES MAY BE SELECTED BASED ON 75 DEGREE C. WHERE EQUIPMENT INSTALLED IS LABELED FOR 75 DEGREE C. WIRING.

CHEDULE LEGEND:

FURNISH AND INSTALL NEW UNDER DIVISION 26 O = INSTALL UNDER DIVISION 26; FURNISHED WITH EQUIPMENT OR BY OTHERS.

X = FURNISH AND INSTALL BY OTHERS (NOT DIVISION 26) * = EXISTING, RELOCATED EQUIPMENT

GENERAL ELECTRICAL NOTES:

- 1. SEE ARCHITECTURAL PLANS FOR LOCATION OF FIRE RATED CONSTRUCTION.
- 2. BRANCH CIRCUIT NOTES:
- A. VERIFY BRANCH CIRCUIT WIRE COUNT BEFORE PULLING CONDUCTORS. PROVIDE REQUIRED CONDUCTORS TO EACH OUTLET AND DEVICE FOR PHASE, NEUTRAL AND EQUIPMENT GROUND BASED ON CIRCUIT DESIGNATIONS SHOWN AND AS OTHERWISE INDICATED ON PLANS OR NOTE BELOW.
- B. PROVIDE SEPARATE NEUTRAL CONDUCTOR FOR BRANCH CIRCUITS SERVING RECEPTACLE OUTLETS UNLESS OTHERWISE INDICATED.
- C. MINIMUM BRANCH CIRCUIT CONDUCTOR SIZE FOR OUTDOOR AND EXTERIOR BUILDING LIGHTING SHALL BE MINIMUM NO. #10 AWG. PROVIDE LARGER SIZE FEEDER PER CODE WHERE EQUIPMENT MCA EXCEEDS 30 AMPS.
- 3. MINIMUM CONDUIT SIZE FOR HOMERUNS SHALL BE 3/4 INCH.
- 4. REFER TO ARCHITECTURAL PLANS FOR LIGHT FIXTURE LOCATIONS AND FOR MOUNTING HEIGHT OF SUSPENDED AND WALL MOUNTED LIGHT FIXTURES. REFER TO REFLECTED CEILING PLANS, INTERIOR ELEVATIONS, EXTERIOR ELEVATIONS, ROOM SECTIONS, AND DETAILS SHOWN ON ARCHITECTURAL CONTRACT DOCUMENTS PRIOR TO ROUGH-IN. REPORT CONFLICTS TO ARCHITECT/ENGINEER FOR RESOLUTION.
- 5. REFER TO ARCHITECTURAL ELEVATIONS FOR LOCATION AND MOUNTING HEIGHT OF WIRING DEVICES. REPORT CONFLICTS TO ARCHITECT/ENGINEER FOR RESOLUTION.
- 6. VERIFY BACK BOX REQUIREMENTS OF EQUIPMENT FURNISHED UNDER OTHER THAN DIVISION 26, 27 OR 28 SECTIONS AND EQUIPMENT FURNISHED BY OWNER.

ENERGY CODE COMPLIANCE NOTES

- 1. MANUAL LIGHTING CONTROL: PROVIDE EACH ROOM WITH MANUAL LIGHTING CONTROL AS INDICATED. REMOTE LIGHTING CONTROLS SHALL IDENTIFY WHERE LIGHTS ARE CONTROLLED AND ON/OFF STATUS. MANUAL CONTROLS FOR SPACES NOT COVERED IN C405.2.1 LISTED EXCEPTIONS SHALL INCLUDE PROVISION FOR 50% LIGHT REDUCTION.
- 2. OCCUPANCY SENSORS: PROVIDE OCCUPANCY SENSORS IN ALL CLASSROOMS, CONFERENCE/MEETING ROOMS, LUNCH AND BREAK ROOMS, PRIVATE OFFICES, RESTROOMS, WAREHOUSE AND STORAGE SPACES, JANITORIAL CLOSETS, AND OTHER SPACES 300 SQUARE FEET OR LESS.
- 3. MOTORS SHALL COMPLY WITH EFFICIENCY REQUIREMENTS OF C405.8, SEE MECHANICAL DOCUMENTS FOR MOTOR EFFICIENCY DATA.

| DRAWING INDEX | | | | | | |
|---------------|-------------------------------------|--|--|--|--|--|
| SHEET # | DESCRIPTION | | | | | |
| E0-1 | ABBREVIATIONS, LEGEND, & NOTES | | | | | |
| E1-1 | ELECTRICAL DEMOLITION PLANS | | | | | |
| E2-1 | ELECTRICAL POWER AND LIGHTING PLANS | | | | | |
| E5-1 | ONE-LINE DIAGRAM | | | | | |

| NTROLS | REMARKS |
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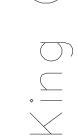


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+____ PHASE... Construction Documents

JOB NO...

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24-08

= DATE...

9/23/24

SHEET TITLE... ABBREVIATIONS, LEGEND, & NOTES SHEET NO...




1111 Fawcett Ave, Suite 100 Tacoma, WA 98402 Phone: (253) 383-3257 Fax: (253) 383-3283

general@hultzbhu.com Job Number: 24-145

E0-]

LAWHEAD ARCHITECTS P.S.

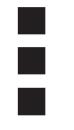

1239 120TH AVE. N.E., STE. D BELLEVUE, WA 98005 (425) 556-1220

SIGNED


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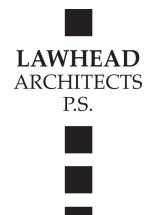
Housing

SIGNATURE.,

OWNER...

PLO1 FILE



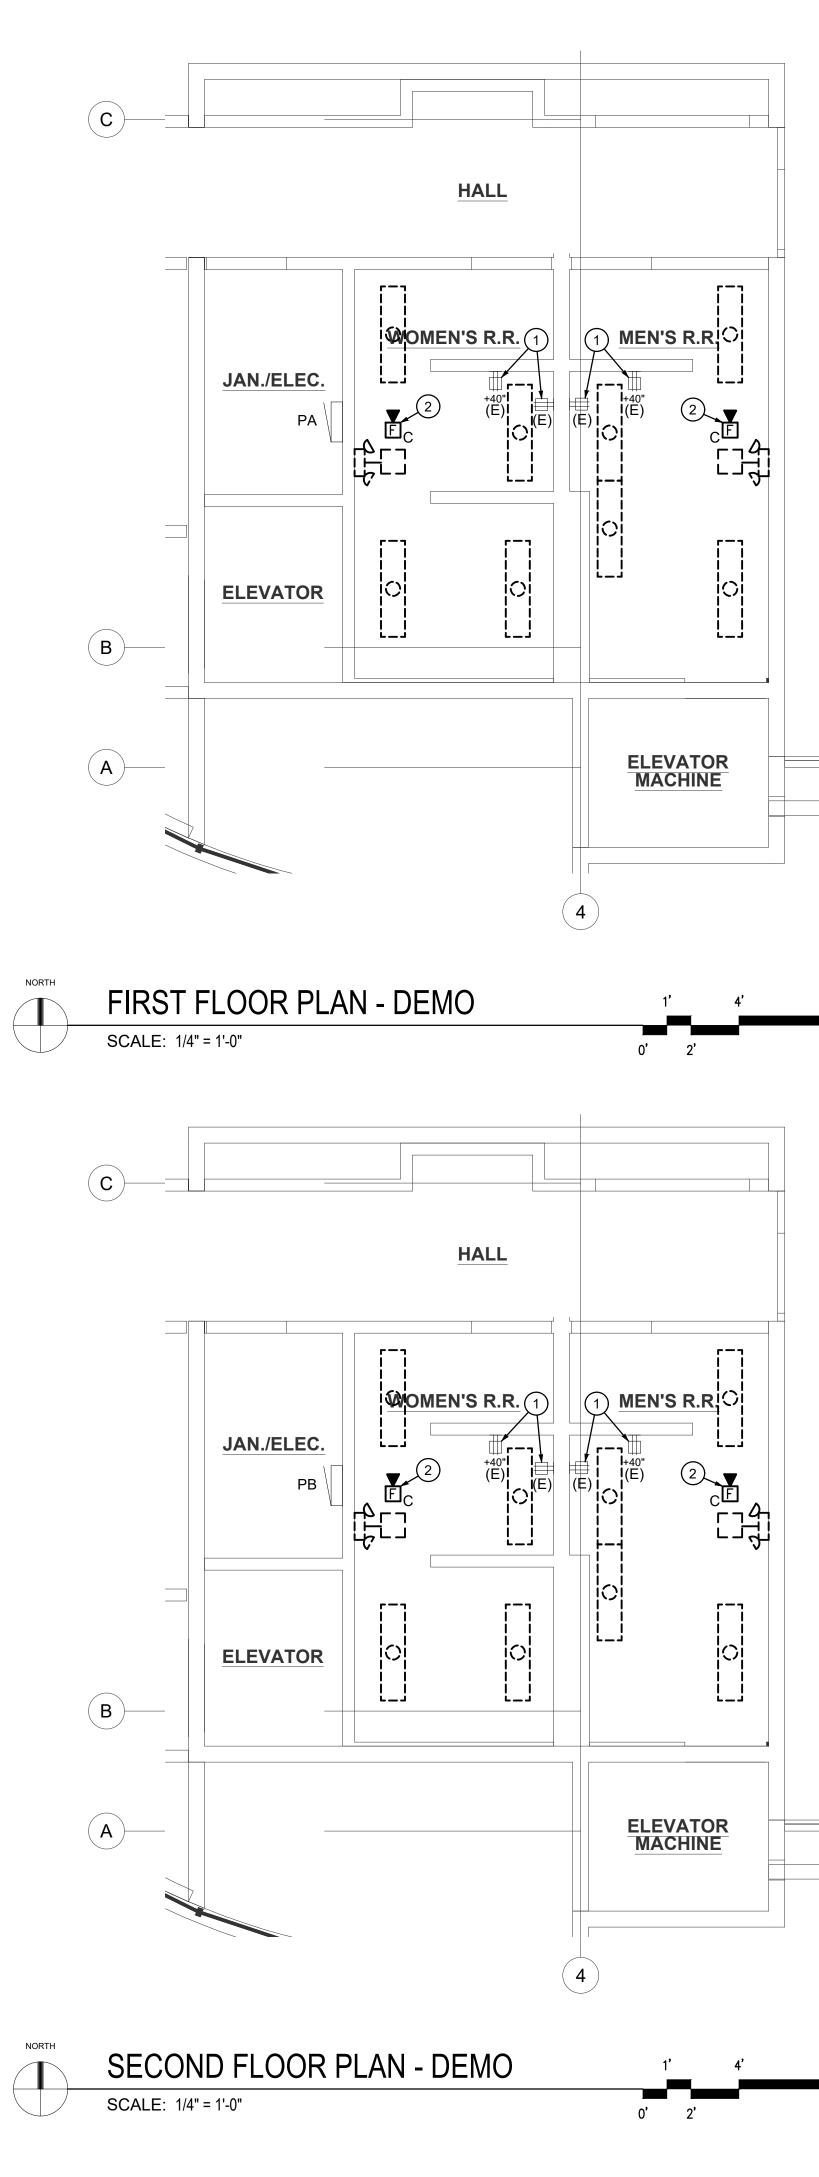

1239 120TH AVE. N.E., STE. D BELLEVUE, WA 98005 (425) 556-1220

SIGNED 9-23-2024

King County Housing Authority

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+---OWNER...

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SIGNATURE.

GENERAL NOTES:

- 1. REFER TO GENERAL ELECTRICAL NOTES ON SHEET E0-1 FOR ADDITIONAL INFORMATION.
- 2. CONTRACTOR TO VERIFY ALL CIRCUITING PRIOR TO BEGINNING WORK. ALL CIRCUITS IDENTIFY ARE BASED ON LIMITED FIELD OBSERVATIONS AND OWNER PROVIDED AS-BUILTS.

PLAN NOTES:

- 1 EXISTING OUTLETS TO BE REPLACED. REMOVE EXISTING GFCI DUPLEX OUTLET AND FACEPLATE. EXISTING WIRING TO REMAIN FOR RECONNECTION.
- 2 SALVAGE FIRE ALARM HORN/STROBE FOR REINSTALLATION. WIRING IS TO REMAIN FOR RECONNECTION.





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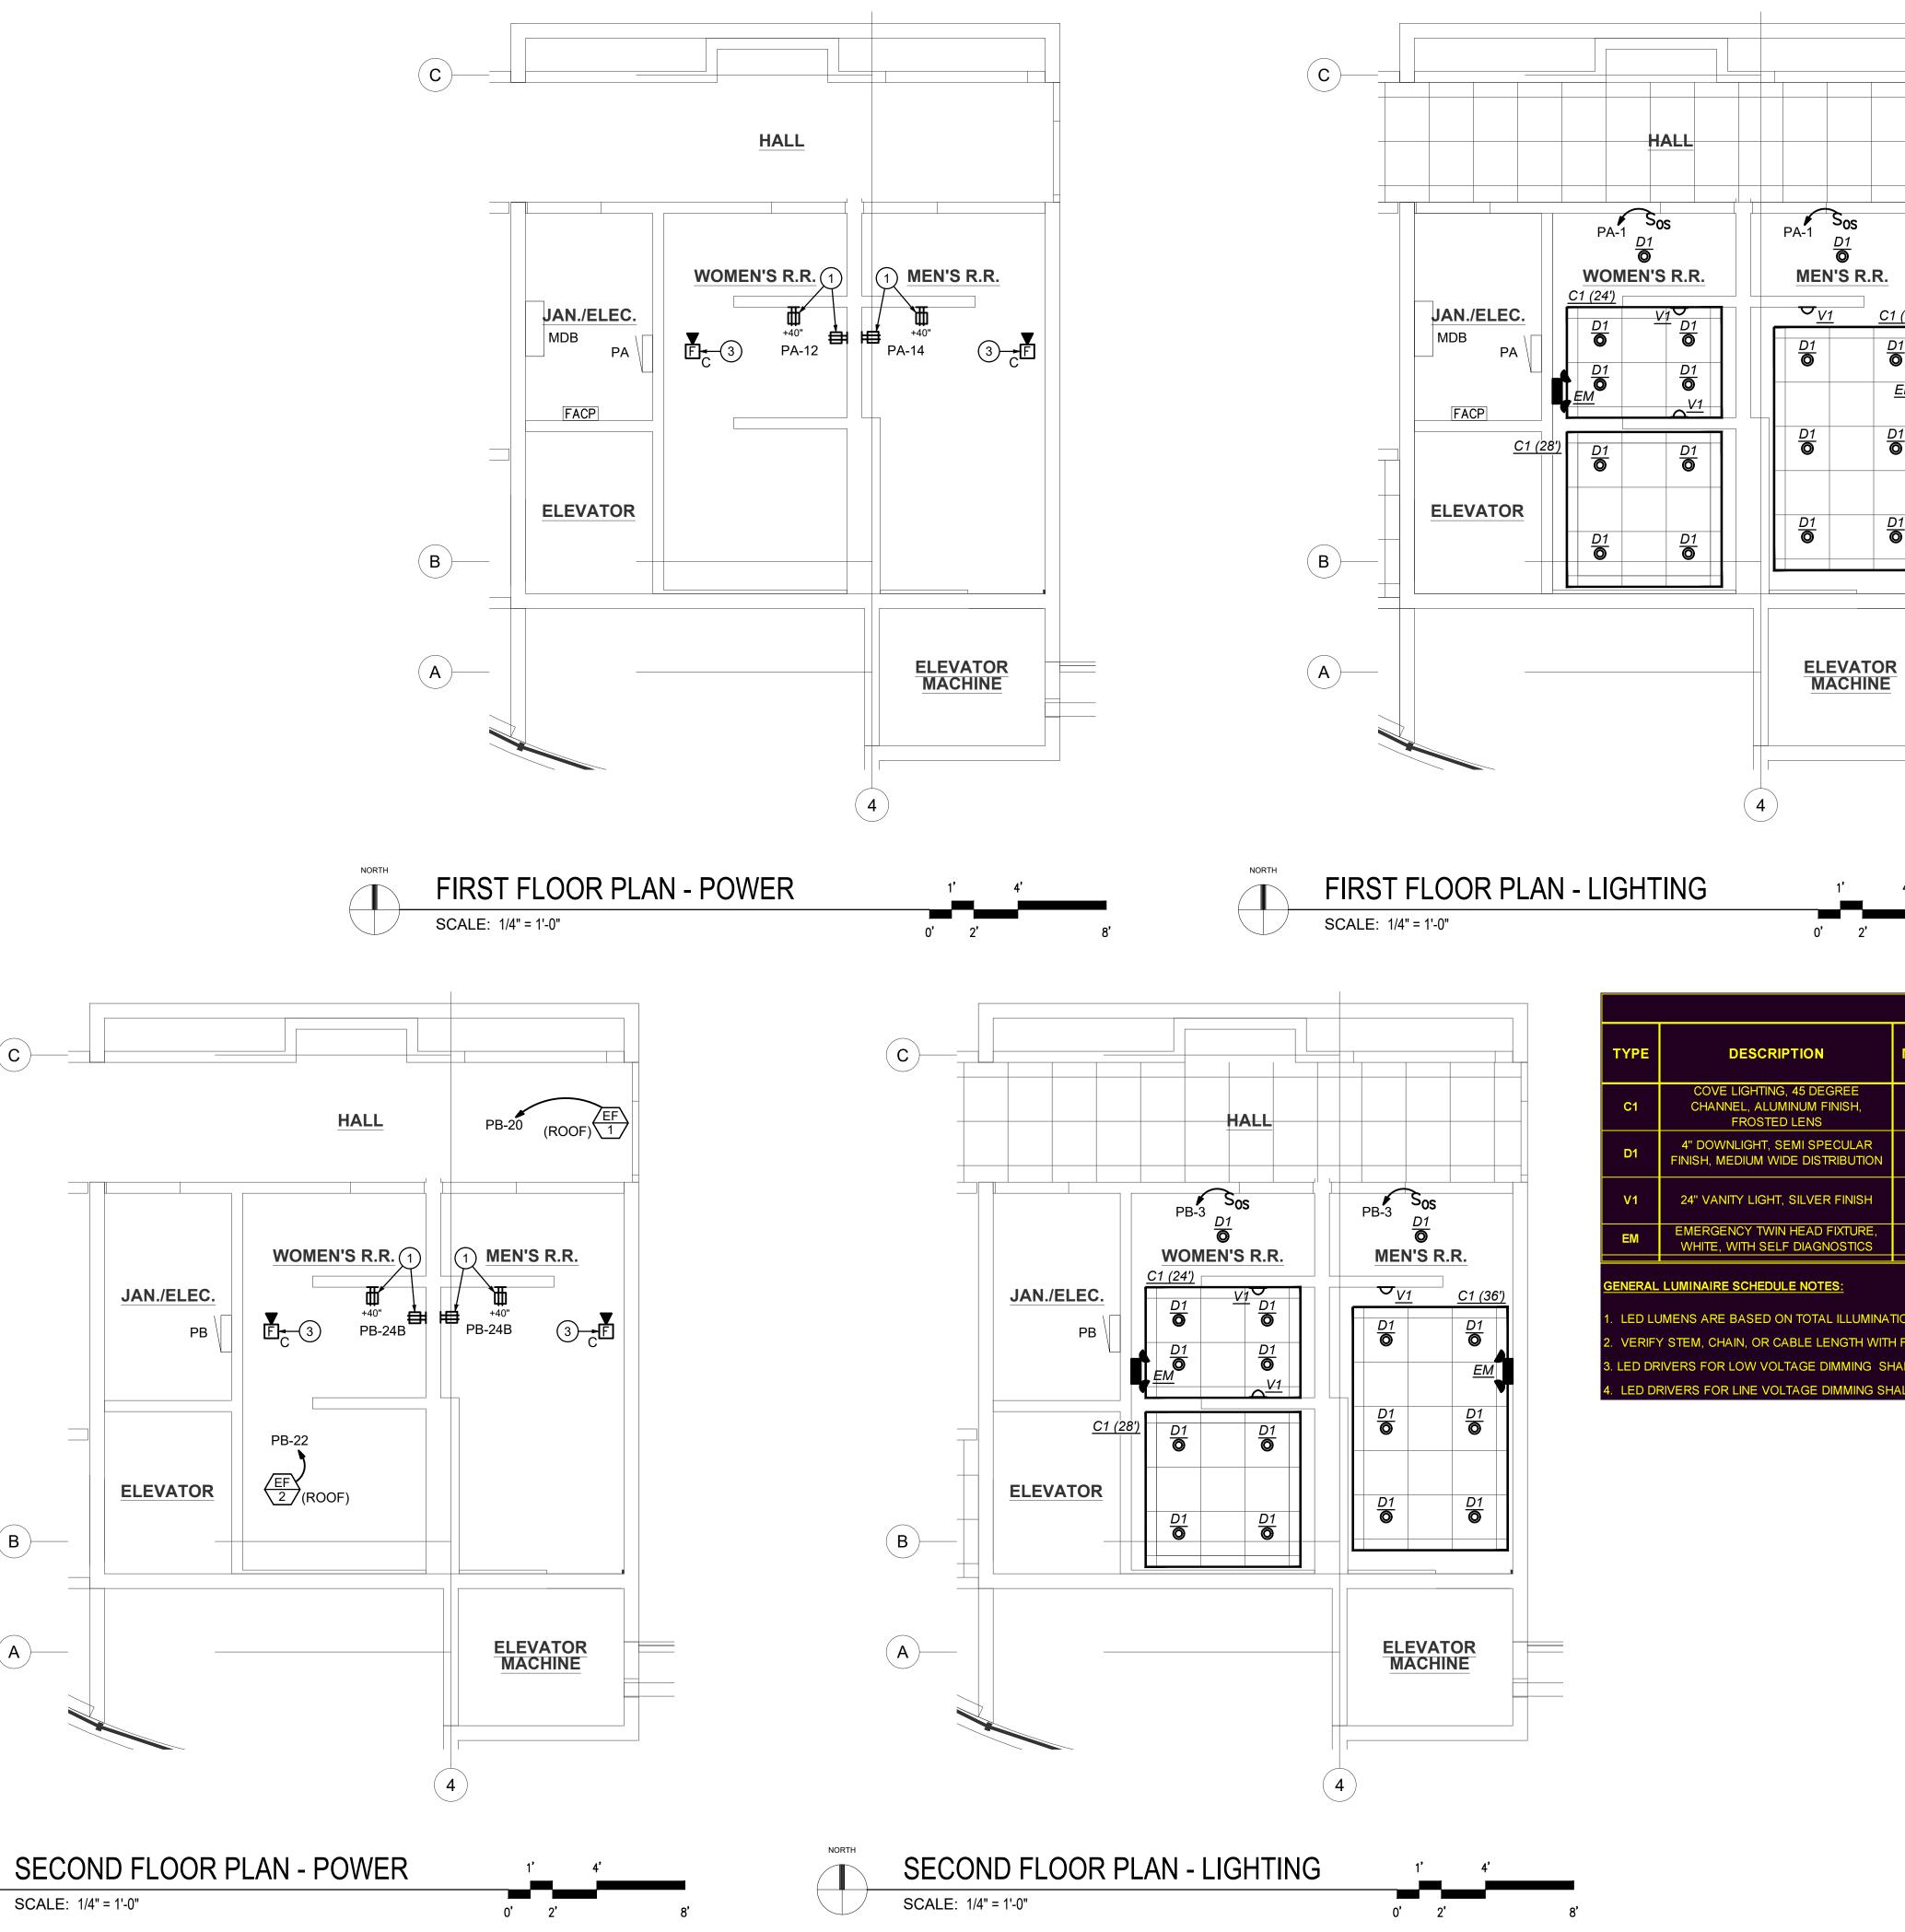
9/23/24

ELECTRICAL DEMOLITION PLANS SHEET NO...



1111 Fawcett Ave, Suite 100Tacoma, WA 98402Phone: (253) 383-3257Fax: (253) 383-3283general@hultzbhu.comJob Number: 24-145





(C)-

B

A

NORTH



1239 120TH AVE. N.E., STE. D BELLEVUE, WA 98005

SIGNATURE.

(425) 556-1220

GENERAL NOTES:

- REFER TO GENERAL ELECTRICAL NOTES ON SHEET E0-1 FOR 1. ADDITIONAL INFORMATION.
- 2. CONTRACTOR TO VERIFY ALL CIRCUITING PRIOR TO BEGINNING WORK. ALL CIRCUITS IDENTIFY ARE BASED ON LIMITED FIELD OBSERVATIONS AND OWNER PROVIDED AS-BUILTS.

PLAN NOTES:

- 1 EXISTING OUTLETS TO BE REPLACED WITH NEW. PROVIDE NEW GFCI DUPLEX OUTLET AND NEW FACEPLATE. CONNECT TO EXISTING CIRCUIT.
- 2 NOT USED
- 3 REINSTALL SALVAGED FIRE ALARM HORN/STROBE. RECONNECT TO EXISTING WIRING.





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| LUMINAIRE SCHEDULE | | | | | | | |
|--------------------|-----------------------------------|-----------------------------|---------|----------------|--------------------|------------------------------------------------------------------|--|
| | MANUFACTURER | LAMP | VOLTAGE | INPUT WATTS | BALLAST/ DRIVER | REMARKS | |
| REE ISH, | DIODELED BLAZE SERIES | LED 3500K 126 LM/FT | 24VDC | 1.5W / FT | 0-10V | PROVIDE POWER SUPPLY AS REQUIRED. LENGTH VARIES, SEE PLANS | |
| ULAR BUTION | LITHOINA LIGHTING LDN4 SERIES | LED 3500K 1500 LUMENS | 120V | 19 | 0-10V | | |
| INISH | INDESSA 444 SERIES | LED 3500K 2380 LUMENS | 120V | 24 | 0-10V | | |
| KTURE, STICS | LITHONIA LIGHTING ELM2L SERIES | LED | 120V | 2.4 | - | | |

LED LUMENS ARE BASED ON TOTAL ILLUMINATION OUTPUT OF THE LUMINAIRE UNLESS OTHERWISE INDICATED.

(ERIFY STEM, CHAIN, OR CABLE LENGTH WITH FIXTURE VENDOR AS REQUIRED TO ACCOMMODATE THE INDICATED MOUNTING HEIGHT MEASURED TO BO OR LOW VOLTAGE DIMMING SHALL BE 0-10 VOLTS [DIGITAL SIGNAL DIMMING INTERFACE TYPE] UNLESS OTHERWISE INDICATED. ED DRIVERS FOR LINE VOLTAGE DIMMING SHALL BE REVERSE PHASE ELECTRONIC LOW VOLTAGE (ELV) UNLESS OTHERWISE APPROVED BY THE ARCH





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DATE...


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-†___ SHEET TITLE... ELECTRICAL POWER AND LIGHTING PLANS = SHEET NO...




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general@hultzbhu.com Job Number: 24-145



| PARLE MDB VICLIAGE 2007.0 VICLIAGE 2007.0< | LOAD CALCULATION - 30 DAY MINIMUM RECORDING | | REVISED THREE PHASE PANEL SCHEDULE | | | | REVISED THREE PHASE PANEL SCHEDULE | | | |
|---------------------------------------------------------------------------------------------------------------------------------------------------------------------------------------------------------------------------------------------------------------------------------------------------------------------------------------------------------------------------------------------------------------------------------------------------------------------------------------------------------------------------------------------------------------------------------------------------------------------------------------------------------------------------------------------------------------------------------------------------------------------------------------------------------------------------------------------------------------------------------------------------------------------------------------------------------------------------------------------------------------------------------------------------------------------------------------------------------------------------------------------------------------------------------------------------------------------------------------------------------------------------------------------------------------------------------------------------------------------------------------------------------------------------------------------------------------------------------------------------------------------------------------------------------------------------------------------------------------------------------------------------------------------------------------------------------------------------------------------------------------------------------------------------------------------------------------------------------------------------------------------------------------------------------------------------------------------------------------------------------------------------------------------------------------------------------------------------------------|---------------------------------------------|---------------------|------------------------------------|-------------------------|-------------------------|---------------|------------------------------------|-----------------------|--------------------------|-----------------------|
| LEACH JON LEACH | 480/277V - 3PH | | ΡΑ | VOLTAGE: 208/120 🔽 4W | RATING: 200 A MAIN: | LUG | PB | VOLTAGE: 208/120 🖌 4W | RATING: 225 A MAIN: | BREAKER |
| Norma Norma <th< th=""><th></th><th></th><th>- GRID</th><th>ENCLOSURE</th><th>_ACCESSORIES_</th><th>_AIC ASSEMBLY</th><th>GRID</th><th>ENCLOSURE</th><th>_ACCESSORIES_</th><th>AIC ASSEMBLY</th></th<> | | | - GRID | ENCLOSURE | _ACCESSORIES_ | _AIC ASSEMBLY | GRID | ENCLOSURE | _ACCESSORIES_ | AIC ASSEMBLY |
| Number of the second | DESCRIPTION | REMARKS | SECTION 1 OF1 | FLUSH | ISOLATED GROUND | SERVICE RATED | SECTION 1 OF1 | FLUSH | ISOLATED GROUND | SERVICE RATED |
| Norm | | | LOCATION: ELEC CLOSET | X SURFACE | SPD | SERIES RATED | LOCATION: ELEC CLOSET | X SURFACE | SPD | SERIES RATED |
| CODINIE FIELD VEX. FUEL VEX. FUEL CODINIE FIEL COUNT VEX. FUEL FUEL COUNT VEX. FUEL FUEL COUNT VEX. FUEL FUEL FUEL FUEL FUEL | | | | | | | | | | |
| Displand Displ | | | | NEMA TYPE 3R | FEED THRU LUGS | 22K | | NEMA TYPE 3R | FEED THRU LUGS | 22K |
| Construct Construct <t< td=""><td>CORDING PERIOD 12/8/2022 TO 1/10/2023</td><td>HIGHEST RECORDED</td><td></td><td></td><td></td><td></td><td></td><td></td><td></td><td></td></t<> | CORDING PERIOD 12/8/2022 TO 1/10/2023 | HIGHEST RECORDED | | | | | | | | |
| CALA MARKES 1/3.2 AVR 1/4.0 VA 4 201 201 2 1/4.0 4 201 201 2 201 2 201 2 201 2 201 2 2 4 201 2 2 4 201 2 2 4 201 2 2 4 201 2 4 201 2 4 201 2 4 201 2 4 201 201 2 4 201 201 2 4 201 201 2 4 201 201 <t< td=""><td></td><td></td><td></td><td>* VA BKR CKT A</td><td>B C CKT BKR VA</td><td></td><td></td><td>* VA BKR CKT A</td><td>B C CKT BKR VA</td><td></td></t<> | | | | * VA BKR CKT A | B C CKT BKR VA | | | * VA BKR CKT A | B C CKT BKR VA | |
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| CCUPNON DRAT DDS CCUPNOLES CCUPNOLES RECEPTACLES RECE | | | | | | | | 1440 20/20 5 | 2440 6 20/1 1000 | CORE LIGHTING |
| Distribution D | DJUSTED DEMAND 104.0 KVA | A | | | | | | 1440 20/20 7 2880 | 8 20/20 1440 | RECEPTACLES |
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| CAD ALODED 363.3 KVA SERVICE UPGRADE Total Product | | | | | | PANEL PB | | 500 20/20 15 | 1940 16 20/20 1440 | RECEPTACLES / FURNACE |
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| BREAKER CODE: | | | 2 WORK STATIONS | | | | | | | |
| K=AFCI, G=GFCI, N=SWITCHED NEUTRAL, S=SHUNT TRIP VA VA VA VA RECEPTACLES OVER 10K 20.9 X 50% 10.4 * * Component of the | | | | | | SPACE | | | | |
| K=KEYED, P=PADLOCK ATTACHMENT VA VA VA VA MOTORS 1.4 X 10% 1.4 X 1.4 X 10% 1.4 X | | | | | 33736 30786 VA PANEL PA | | | | | 65.8 |
| KVAKVAKVAANPSLARGEST MOTORX125%* EQUIPMENT REPLACED LIKELIGHTING2.6X125%337360786VA SUB-TOTAL LOADKVAAMPSKITCHENX100%* NEW LOAD ON EXISTING BRELIGHTING2.6X125%10.0277.5NONCOINCIDENTX0%*NOWRECEPTACLES0.0X10.0CALCULATED62.0172.1NONCOINCIDENTX100%*NEW LOAD ON EXISTING BREAKERMOTORS1.4X100%1.4****NEW LOAD ON EXISTING BREAKEREV CHARGERX125%LIGHT LINE WEIGHT EQUALS EXISTING BREAKERNONCOINCIDENT2.8X100%6.2X100%5.2*************************************************************************************************** | | | | | | | | | | |
| KVAKVATOTAL LOADKVAAMPSKITCHENX100%**NEW LOAD ON EXISTING BRELIGHTING2.6X125%3.3CONNECTED10.0277.5NONCOINCIDENTX0%RECEPTACLES10.0X10.0CALCULATED62.0172.1REMAINDERX100%EV CHARGERX125%NOTORS1.4X100%1.4****NEW LOAD ON EXISTING BREAKEREV CHARGERX125%LIGHT LINE WEIGHT EQUALS EXISTINGNONCOINCIDENTX125%125%125%*NEW LOAD ON EXISTING BREAKEREV CHARGERX100%X100%NONCOINCIDENTX100%6.2X100%6.2*NEW LOAD ON EXISTING BREAKERHEAVY LINE WEIGHT EQUALS NEWNONCOINCIDENTX0%X0%X100%KITCHENKITCHENKITCHENKITCHENKITCHENNONCOINCIDENTX100%5.2*NEW LOAD ON EXISTING BREAKERKITCHENKITCHENKITCHENKITCHENKITCHENKITCHENKITCHENNONCOINCIDENTX100%6.2X100%6.2*NEW LOAD ON EXISTING BREAKERKITCHENKITCHENKITCHENKITCHENKITCHENKITCHENKITCHENKITCHENKITCHENKITCHENKITCHENKITCHENKITCHENKITCHENKITCHENKITCHENKITCHENKITCHENKITCHENKITCHENKITCHENKITCHENKITCHEN <t< td=""><td></td><td></td><td>K=KEYED, P=PADLOCK ATTACHM</td><td></td><td></td><td></td><td></td><td>N 4050/</td><td></td><td></td></t<> | | | K=KEYED, P=PADLOCK ATTACHM | | | | | N 4050/ | | |
| LIGHTING 2.6 X 125% 3.3 CONNECTED 100.0 277.5 NONCOINCIDENT X 0% RECEPTACLES 10.0 X 100% 10.0 CALCULATED 62.0 172.1 REMAINDER X 100% RECEPTACLES OVER 10K 77.2 X 50% 38.6 * * 100% EV KEMAINDER X 100% MOTORS 1.4 X 100% 1.4 * * | | | | | | 4400 | | | | |
| RECEPTACLES10.0X10.0%10.0CALCULATED62.0172.1REMAINDERX100%RECEPTACLES OVER 10K77.2X50%38.6**EV CHARGERX125%LIGHT LINE WEIGHT EQUALS EXISTINGMOTORS1.4X100%1.4*****EMARKS125%LIGHT LINE WEIGHT EQUALS EXISTINGLARGEST MOTORX125%***NEW LOAD ON EXISTING BREAKER**HEAVY LINE WEIGHT EQUALS NEWNONCOINCIDENT6.2X100%6.2X100%6.2***** | | | | | | | | | NEW LOAD ON EXIST | ING BREAKER |
| RECEPTACLES OVER 10K 77.2 X 50% 38.6 MOTORS 1.4 X 100% 1.4 LARGEST MOTOR X 125% LIGHT LINE WEIGHT EQUALS EXISTING KITCHEN 6.2 X 100% 6.2 NONCOINCIDENT X 0% - | | | | | | | | | | |
| MOTORS1.4X100%1.4* REMARKSLIGHT LINE WEIGHT EQUALS EXISTINGLARGEST MOTORX125%* NEW LOAD ON EXISTING BREAKERHEAVY LINE WEIGHT EQUALS NEWKITCHEN6.2X100%6.2NONCOINCIDENTX0% | | | | | CALCULATED 62.0 | 1/2.1 | | | | |
| LARGEST MOTORX125%* NEW LOAD ON EXISTING BREAKERKITCHEN6.2X100%6.2NONCOINCIDENTX0% | | | | | | | | A 125% | | SEVISTING |
| KITCHEN 6.2 X 100% 6.2 NONCOINCIDENT X 0% 0% 0% | | | | | | | | | | |
| NONCOINCIDENT X 0% | | | | | * NEW LOAD ON EXIST | | | | | |
| | | | | | | | | | | |
| REMAINDER 2.5 X 100% 2.5 | | | | | | | | | | |
| | | | | | | | | | | |
| EV CHARGER X 125% | | | EV CHARGER | X 125% | | | | | | |

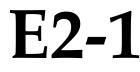HEAVY LINE WEIGHT EQUALS NEW



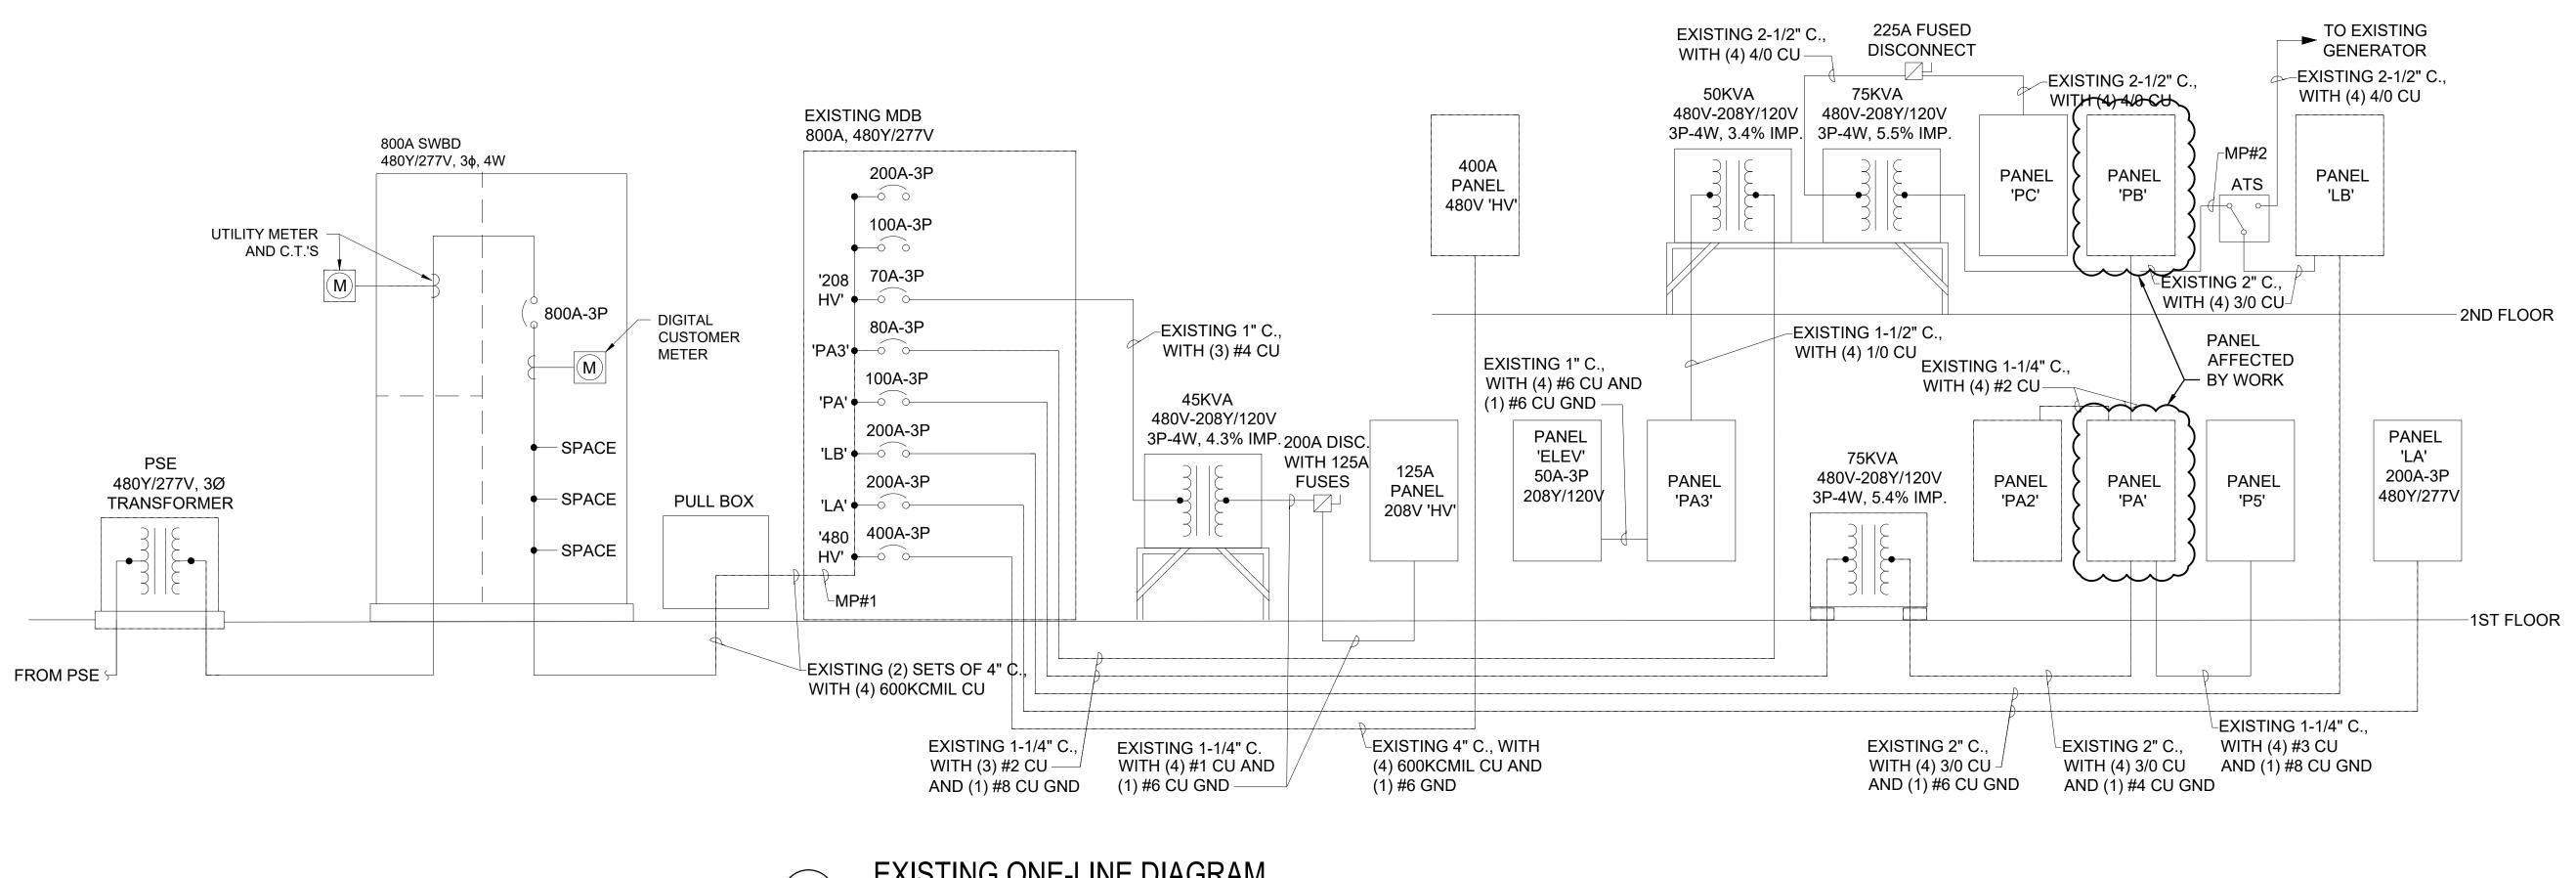

SCALE: N.T.S.



1111 Fawcett Ave, Suite 100 Tacoma, WA 98402 Phone: (253) 383-3257 Fax: (253) 383-3283 general@hultzbhu.com Job Number: 24-145

SIGNED 9-23-2024 OWNER... King County Housing Authority +۰ — \subseteq $\stackrel{\text{A}}{\vdash}$ $(\)$ $\underbrace{ }$ $\overline{}$ \bigcirc

LAWHEAD ARCHITECTS P.S.

1239 120TH AVE. N.E., STE. D BELLEVUE, WA 98005

SIGNATURE.

(425) 556-1220

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+----PHASE ... Construction Documents

+---JOB NO... 24-08

+____ DATE...

9/23/24

____ SHEET TITLE...

ONE-LINE DIAGRAM

+---SHEET NO...



