# **KCHA - 600 BUILDING - BATHROOM REMODEL**

# **PROJECT TEAM**

**OWNER:** 

\_\_\_\_

KING COUNTY HOUSING AUTHORITY 700 ANDOVER PARK WEST SUITE C

PARTIAL INTERIOR

ELEVATIONS

1 A1.1

**PROJECT DESCRIPTION** 

SEATTLE, WA 98188 (206) 826-5348 PATRICK KAAPANA <PatrickK@kcha.org>

#### **ARCHITECT:**


LAWHEAD ARCHITECTS P.S. 1239 120TH AVENUE NORTHEAST SUITE D BELLEVUE, WA 98005 (425) 556-1220 FRANK LAWHEAD <FLawhead@Lawhead.com>

## **MECHANICAL/ ELECTRICAL:**

HULTZ BHU ENGINEERS INC. 1111 FAWCETT AVE. SUITE 100 **TACOMA, WA 98402** (253) 383-3257 RICK HULTZ <RHultz@HultzBHU.com>

THE PROPOSED PROJECT CONSISTS OF INTERIOR RENOVATIONS TO MALE AND FEMALE RESTROOM FACILITIES WITH MATCHING PLAN LAYOUTS ON THE 1ST AND 2ND FLOORS IN THE PUBLIC CORE OF THE KING COUNTY HOUSING AUTHORITY CENTRAL OFFICE 600 BUILDING. THE BUILDING AND RESTROOMS WERE CONSTRUCTED IN 1980 AND ORIGINAL DRAWINGS PERMITTED UNDER THE 1976 EDITION OF THE UNIFORM BUILDING CODE. THE INTENDED SCOPE OF THE PROPOSED PROJECT IS LIMITED TO THESE RESTROOMS AND WOULD INCLUDE REPLACING EXISTING WALL AND FLOOR FINISHES. MODIFYING EXISTING LIGHTING, REPLACING PLUMBING FIXTURES, REPLACING TOILET PARTITIONS, REPLACING LAVATORY CASEWORK, REPLACING TOILET ACCESSORIES, MAKING MODIFICATIONS TO THE CEILING ARCHITECTURE TO INSTALL A COFFERED CEILING DESIGN, AND RELATED MECHANICAL AND ELECTRICAL MODIFICATIONS TO ACCOMMODATE THE AFOREMENTIONED WORK.

# **ARCHITECTURAL ABBREVIATIONS**

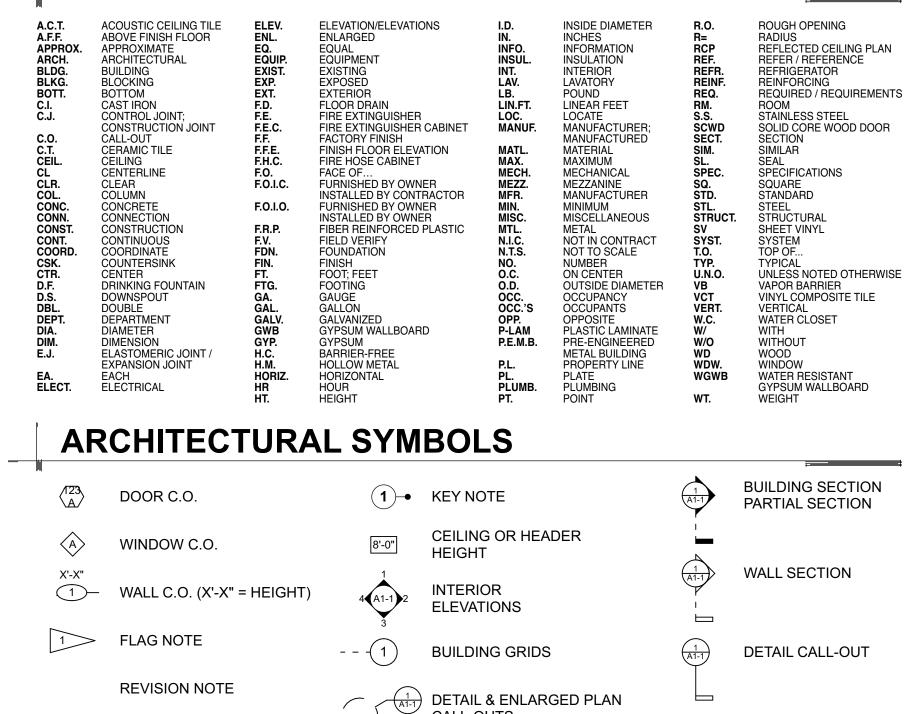

CALL-OUTS

VICINITY MAP.... 600 ANDOVER PARK W, TUKWILA, WA 98188 **— ||** SCALE: 1" = 1000' -SITE 🎢 S 166th St S 167th St Tukwila Pond Park Wig Blvd Minkler Blvc S 172nd Pl Minkler Blvd S 175th St

WOMEN'S RESTROOM - SOUTHEAST PERSPECTIVE VIEW...



**MEN'S RESTROOM - SOUTHWEST PERSPECTIVE VIEW..** 



1	PROJECT DATA			DEX	
ļ	SITE ADDRESS:	600 ANDOVER PARK W TUKWILA, WA 98188		COVER S	
	PARCEL: LOT AREA:	#262304-9123 54,000 SQ. FT. (1.24 ACRES)	ARCI	HITECTUR AD-1 A2-1 A2-2	AL DEMO EN FLOOR PI ENLARGE
	ZONING:	TUC-WP – TUKWILA URBAN CENTER - WORKPLACE DISTRICT		A2-3	ENLARGE PLANS
	BUILDING AREA:	1ST FLOOR= $9,474$ SQ. FT.2ND FLOOR= $\pm 10,412$ SQ. FT.COMBINED AREA=19,886 SQ. FT		A3-1 A3-2 A4-1 A5-1	INTERIOR FINISH SE ENLARGE INTERIOR
	BUILDING HEIGHT: (PER IBC 202 DEFINITION)	± 29'-0" MAXIMUM HEIGHT. TWO-STORY BUILDING	MEC	HANICAL M0-1	MECHANI
	CONSTRUCTION TYPE: (IBC 601)	V-B ASSUMED (V-N PER 1976 U.B.C.), FULLY SPRINKLERED.		M0-2 M1-1 M3-1	MECHANI ENLARGE ENLARGE
	OCCUPANCY:	B (B-2 PER 1976 U.B.C.) – BUSINESS: 19,886 SQ. FT.		M4-1	ENLARGE







#### Construction Documents

JOB NO...

PHASE ...

24-08

+---DATE...

9/23/24

SHEET TITLE ...

**Cover Sheet** 

SHEET NO...



### ELECTRICAL

E5-1

ABBREVIATIONS, LEGEND,

ENLARGED FLOOR PLAN PLAN (KEY PLANS) GED FLOOR PLANS GED REFLECTED CEILING

OR ELEVATIONS SELECTIONS GED BUILDING SECTIONS OR DETAILS

NICAL LEGEND AND NOTES NICAL SCHEDULES GED DEMOLITION PLANS GED PLUMBING PLANS GED HVAC PLANS

& NOTES

ELECTRICAL DEMOLITION PLANS ELECTRICAL POWER AND LIGHTING PLANS **ONE-LINE DIAGRAM AND SCHEDULES** 


E0-1 E1-1 E2-1

- 1. SEE MECHANICAL & ELECTRICAL DRAWINGS FOR MORE INFORMATION NOT SHOWN HERE.
- 2. ALL NOTES ARE TYPICAL FOR BOTH MEN'S AND WOMEN'S RESTROOMS AT BOTH FLOORS. SURVEY EXISTING RESTROOMS FOR A COMPLETE ACCOUNTING OF EXISTING FIXTURES, EQUIPMENT, RECEPTACLES, SIGNAGE, ETC. WITHIN PROJECT SCOPE OF WORK.
- 3. PROVIDE ADDITIONAL DEMOLITION NOT SHOWN HERE IN ORDER TO MAKE WAY FOR NEW CONSTRUCTION. REFER TO ALL DRAWINGS & SPECIFICATIONS.





WOMEN'S RESTROOM -SOUTH PERSPECTIVE

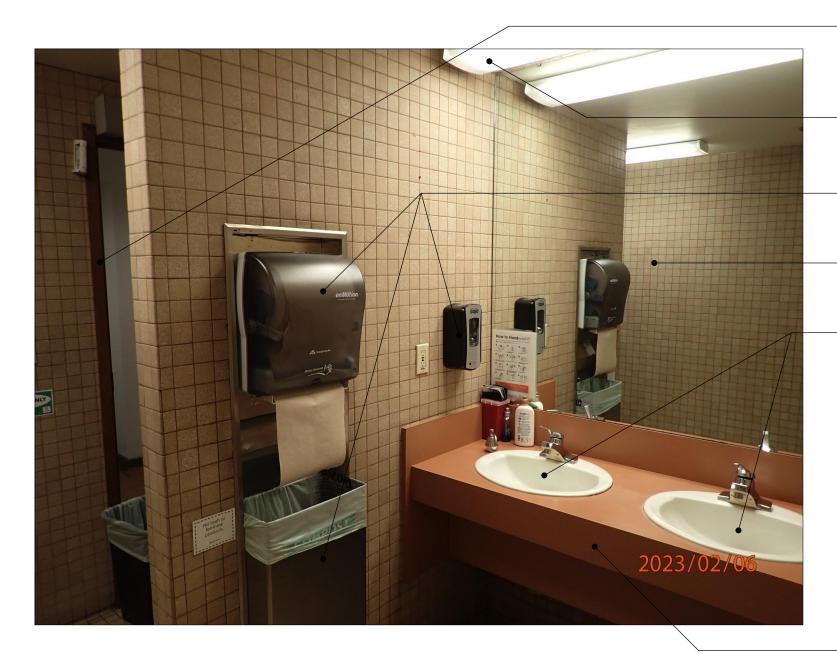



WOMEN'S RESTROOM -NORTHEAST PERSPECTIVE





3

WOMEN'S RESTROOM -NORTH PERSPECTIVE

REMOVE / SALVAGE FIRE ALARM EQUIPMENT FOR REUSE AT ORIGINAL LOCATIONS.

REMOVE / TEMPORARILY PROTECT FIRE SPRINKLER SYSTEM WHERE NECESSARY TO MAKE WAY FOR NEW SOFFITS AND COFFERED CEILINGS.

DEMO. LIGHTING. SALVAGE LIGHTING WHERE BEING REUSED. SEE ELEC. FOR MORE INFO.

DEMO. TOILET PARTITIONS.

- REMOVE ALL TOILET ACCESSORIES. RETURN TO OWNER.

DEMO EXISTING CEILING FINISHES AND SUPPORTING CONSTRUCTION TO MAKE WAY FOR NEW SOFFITS AND COFFERED CEILINGS.

- DEMO. ALL CERAMIC TILE WALL AND FLOOR FINISHES. DEMO. UNDERLYING WALL SHEATHING MATERIALS, AND FLOOR UNDERLAYMENTS DOWN TO SUBSTRATE — CONCRETE SLAB ON GRADE AT THE 1ST FLOOR & CONCRETE TOPPING AT THE 2ND FLOOR. COORDINATE WITH OWNER TO ASSESS QUALITY OF SUBSTRATE AFTER DEMOLITION. ENSURE SURFACES ARE CLEAN AND LEVEL AND READY TO RECEIVE NEW WORK.

PROTECT DOORS DURING DEMOLITION.

- DEMO. LIGHTING. SALVAGE LIGHTING WHERE BEING REUSED. SEE ELEC. FOR MORE INFO.

- REMOVE ALL TOILET ACCESSORIES. RETURN TO OWNER.

DEMO. MIRRORS.

- DEMO. PLUMBING FIXTURES (U.N.O.). SEE MECH. FOR MORE INFO.

DEMO. CASEWORK

- DEMO EXISTING CEILING FINISHES AND SUPPORTING CONSTRUCTION TO MAKE WAY FOR NEW SOFFITS AND COFFERED CEILINGS.

DEMO. LIGHTING. SALVAGE LIGHTING WHERE BEING REUSED. SEE ELEC. FOR MORE INFO.

- DEMO. MIRRORS.

REMOVE / TEMPORARILY PROTECT FIRE SPRINKLER SYSTEM WHERE NECESSARY TO MAKE WAY FOR NEW SOFFITS AND COFFERED CEILINGS.

DEMO. ALL CERAMIC TILE WALL AND FLOOR FINISHES. DEMO. UNDERLYING WALL SHEATHING MATERIALS, AND FLOOR UNDERLAYMENTS DOWN TO SUBSTRATE — CONCRETE SLAB ON GRADE AT THE 1ST FLOOR & CONCRETE TOPPING AT THE 2ND FLOOR. COORDINATE WITH OWNER TO ASSESS QUALITY OF SUBSTRATE AFTER DEMOLITION. ENSURE SURFACES ARE CLEAN AND LEVEL AND READY TO RECEIVE NEW WORK.

REMOVE ALL TOILET ACCESSORIES. RETURN TO OWNER.





# **MEN'S RESTROOM -NORTHWEST PERSPECTIVE**





# **MEN'S RESTROOM -**SOUTH PERSPECTIVE





# **MEN'S RESTROOM -**NORTH PERSPECTIVE

DEMO. LIGHTING. SALVAGE LIGHTING WHERE BEING REUSED. SEE ELEC. FOR MORE INFO.

REMOVE / SALVAGE SWITCH & RECEPTACLE PLATES FOR REINSTALLATION AT ORIGINAL LOCATIONS. SEE ELEC.

REMOVE / SALVAGE SIGNAGE FOR REINSTALLATION AT ORIGINAL LOCATIONS.

REMOVE / SALVAGE DOOR HARDWARE FOR REINSTALLATION AT ORIGINAL LOCATIONS WHERE AFFECTED BY WORK.

DEMO EXISTING CEILING FINISHES AND SUPPORTING CONSTRUCTION TO MAKE WAY FOR NEW SOFFITS AND COFFERED CEILINGS.

DEMO. TOILET PARTITIONS.

REMOVE / SALVAGE FIRE ALARM EQUIPMENT FOR REUSE AT ORIGINAL LOCATIONS.

TO ASSESS QUALITY OF SUBSTRATE AFTER DEMOLITION. ENSURE SURFACES ARE CLEAN AND LEVEL AND READY TO RECEIVE NEW WORK.

DEMO. ALL CERAMIC TILE WALL AND FLOOR FINISHES. DEMO. UNDERLYING WALL SHEATHING MATERIALS, AND FLOOR UNDERLAYMENTS

DOWN TO SUBSTRATE - CONCRETE SLAB ON GRADE AT THE 1ST FLOOR & CONCRETE TOPPING AT THE 2ND FLOOR. COORDINATE WITH OWNER

DEMO. PLUMBING FIXTURES (U.N.O.). SEE MECH. FOR MORE INFO.

- DEMO EXISTING CEILING FINISHES AND SUPPORTING CONSTRUCTION TO

MAKE WAY FOR NEW SOFFITS AND COFFERED CEILINGS.



- DEMO. TOILET PARTITIONS.

FOR MORE INFO. - DEMO GRILLES. SEE MECH.

PROTECT DOORS DURING DEMOLITION. DEMO. LIGHTING. SALVAGE LIGHTING WHERE BEING REUSED. SEE ELEC.

NECESSARY TO MAKE WAY FOR NEW SOFFITS AND COFFERED CEILINGS.

REMOVE / TEMPORARILY PROTECT FIRE SPRINKLER SYSTEM WHERE

EXISTING URINAL TO REMAIN. PROTECT. MODIFY VALVES PER MECH.



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King

PHASE ...

JOB NO...

24-08

9/23/24

SHEET TITLE ...

SHEET NO...

Demo Plan

**AD-1** 

+ DATE...

Construction

Documents

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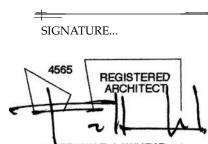
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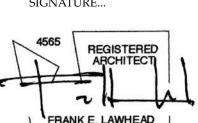
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9

Remode

Bathroom





STATE OF WASHINGTON

1239 120TH AVE. N.E., STE. D BELLEVUE, WA 98005 (425) 556-1220

LAWHEAD ARCHITECTS P.S.

# DEMO. PLUMBING FIXTURES (U.N.O.). SEE MECH. FOR MORE INFO. REMOVE ALL TOILET ACCESSORIES. RETURN TO OWNER

REMOVE ALL TOILET ACCESSORIES. RETURN TO OWNER.

- DEMO. CASEWORK.

DEMO. TOILET PARTITIONS.









1. FIELD VERIFY ALL EXISTING DIMENSIONS.

LAWHEAD

- 2. FIELD VERIFY ALL EXISTING DIMENSIONS.

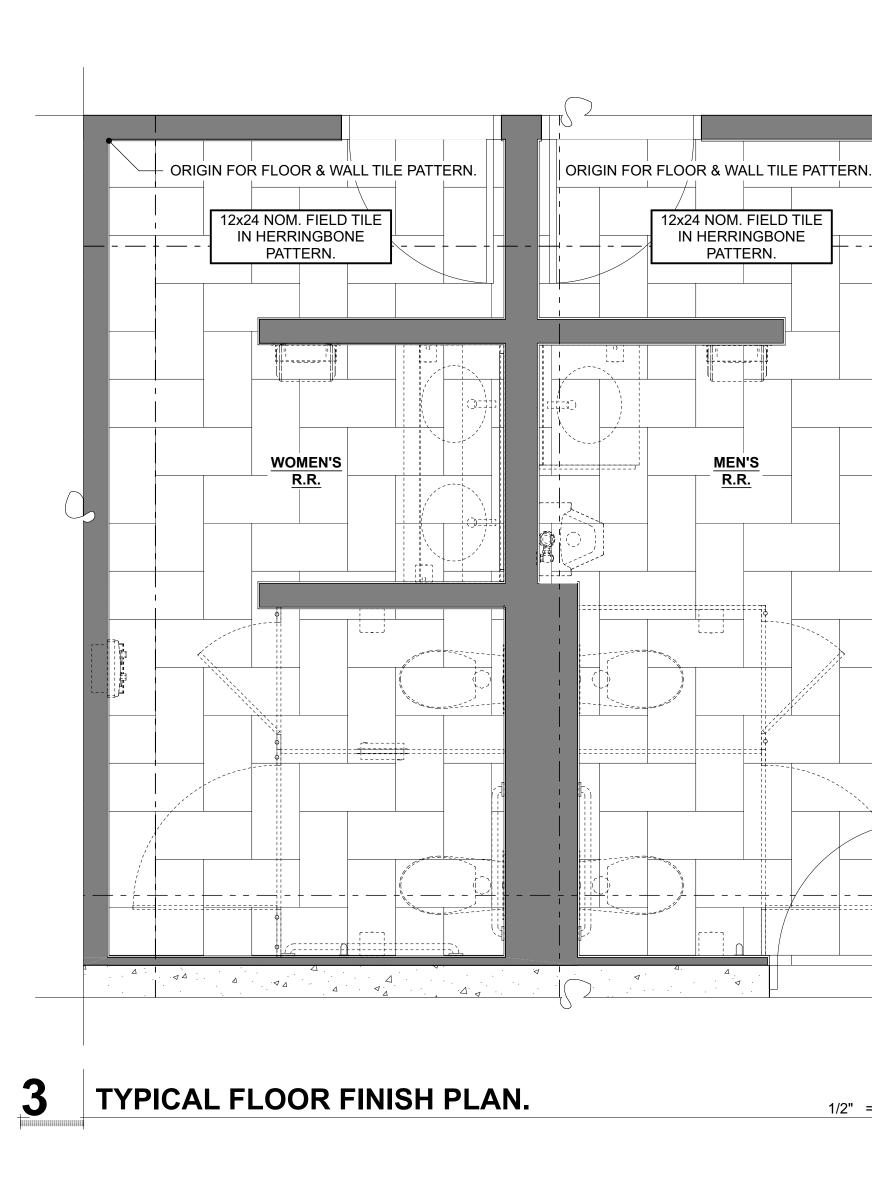


SEE MECHANICAL & ELECTRICAL FOR ADDITIONAL INFORMATION NOT SHOWN HERE.

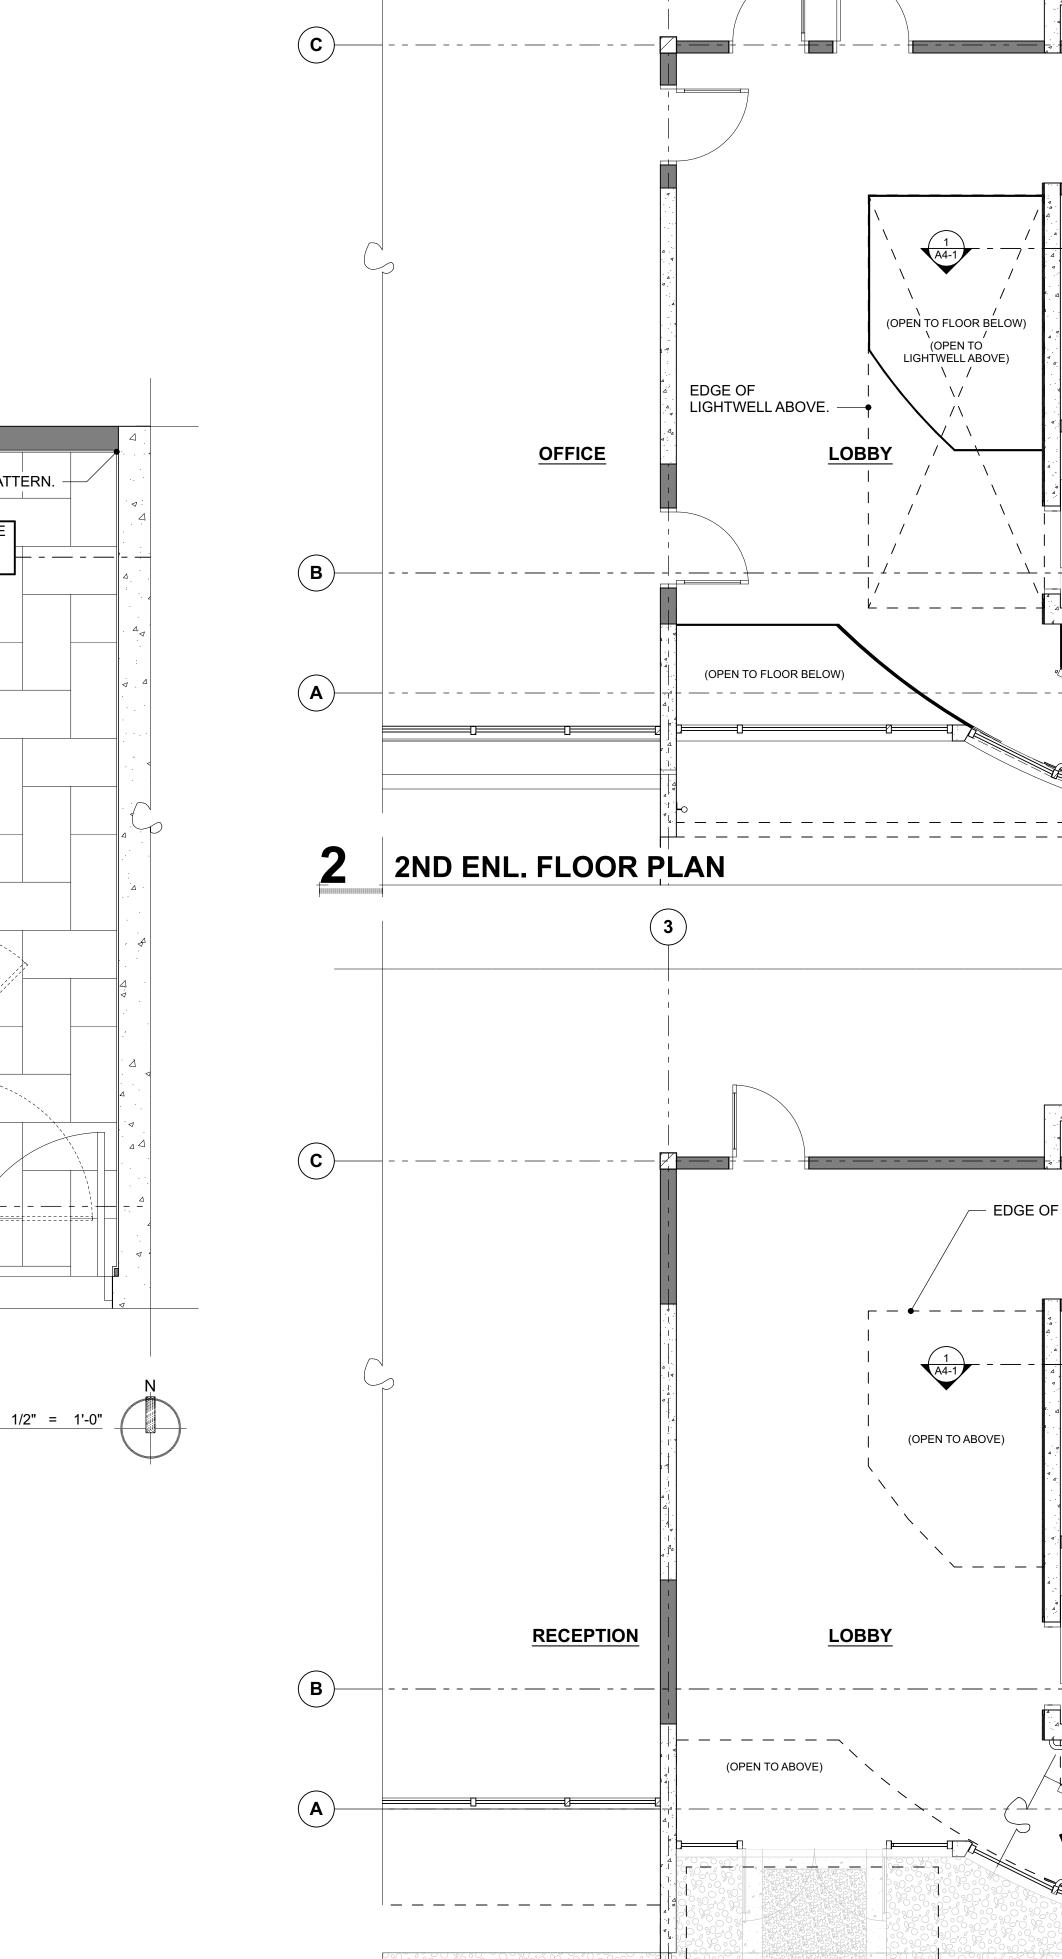

(3)

**1ST ENL. FLOOR PLAN** 

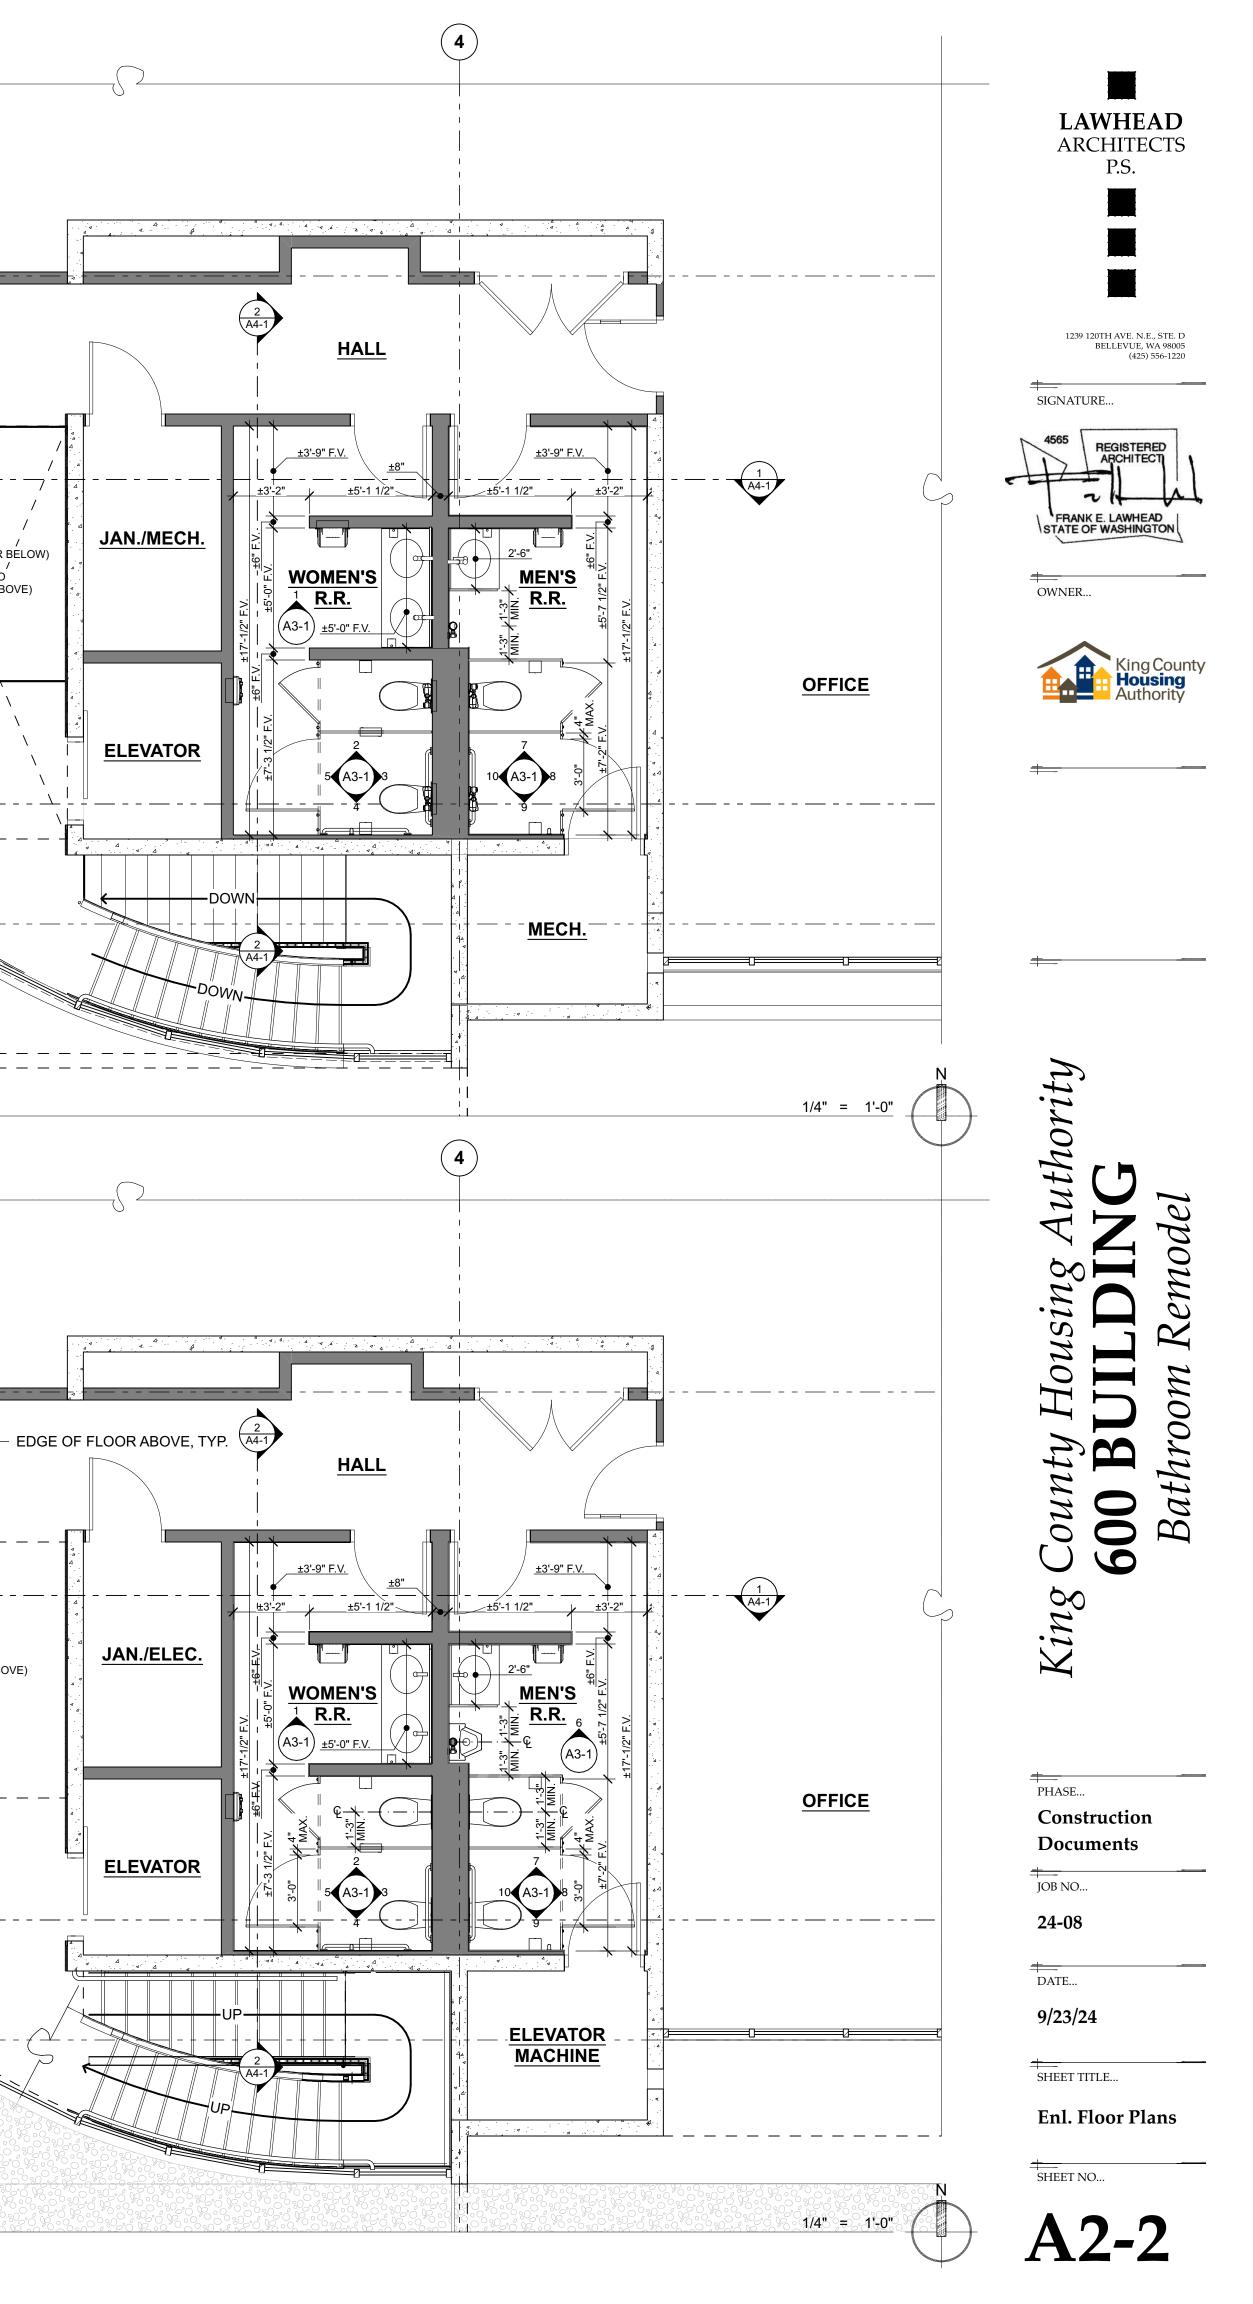



- 1. SEE MECHANICAL & ELECTRICAL FOR ADDITIONAL INFORMATION NOT SHOWN HERE.
- 2. FIELD VERIFY ALL EXISTING DIMENSIONS.
- 3. MODIFY EXISTING SPRINKLER SYSTEM TO ACCOMMODATE NEW COFFERED CEILINGS.


- 6. REINSTALL EXISTING LIGHTING WHERE BEING SALVAGED FOR REUSE.


RCP LEGEND							
	GWB (GYPSUM WALL BOARD)						
	ACT (ACOUSTIC CEILING TILE)						
	PERFORATED WOOD VENEER ACT (ACOUSTIC CEILING TILE)						
	EXPOSED TO STRUCTURE ABOVE						



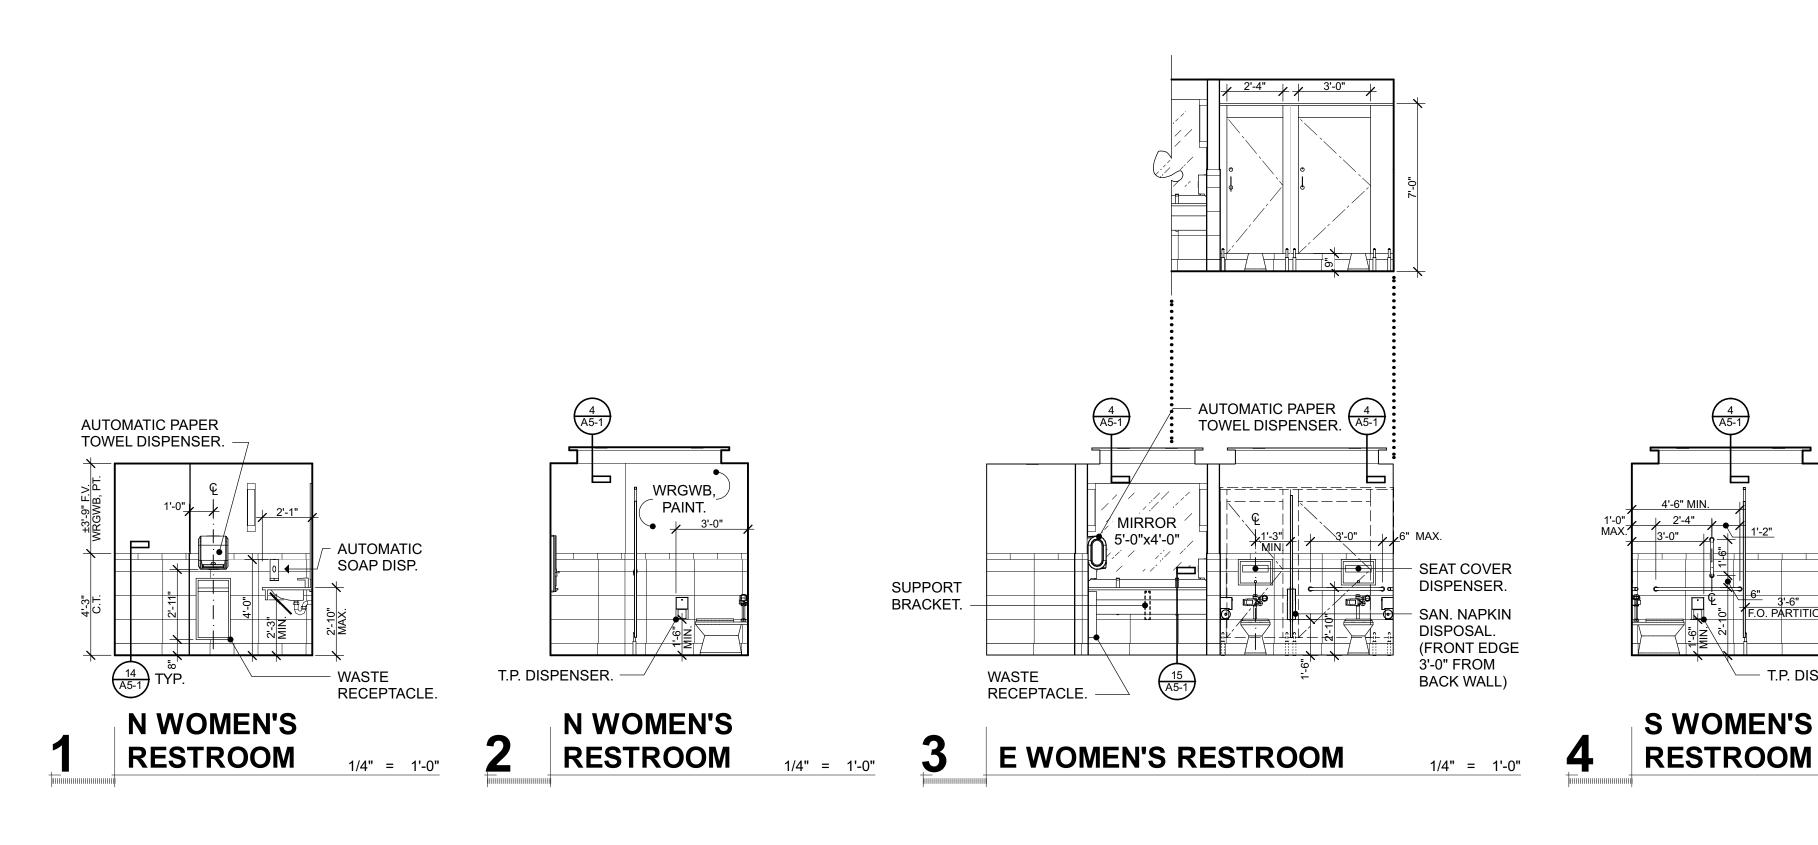

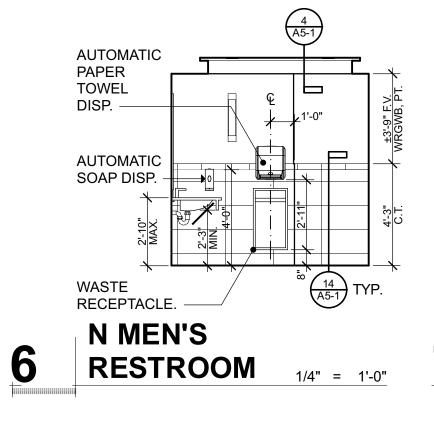

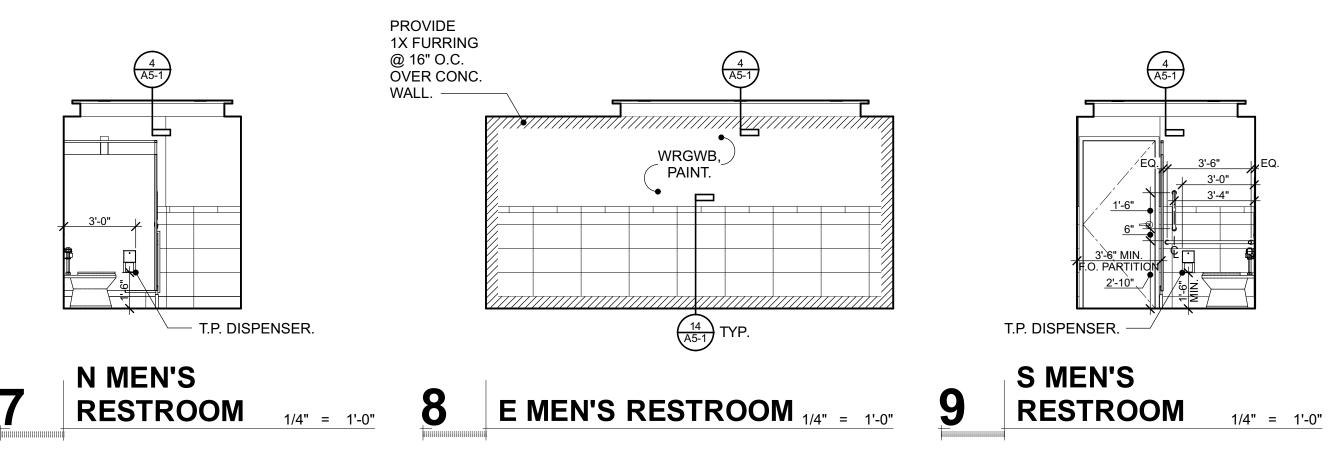

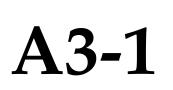

SHEET NO...

### **Interior Elevations**

SHEET TITLE...

9/23/24

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Construction

Documents


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PHASE ...

JOB NO...

King

Remode Bathroom **D** 600

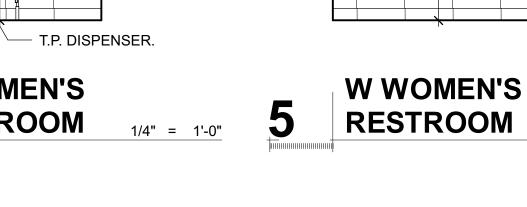

SEAT COVER DISPENSER.

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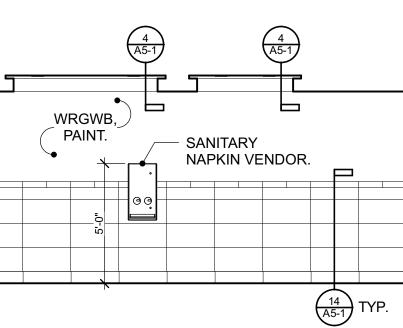
AUTOMATIC PAPER TOWEL DISPENSER.

1/

URINAL PARTITION. EXTEND TO MIN. 5'-0" HT. A.F.F. EXTEND HORIZ. THE GREATER OF EITHER 1-6" FROM WALL OR 6" BEYOND FRONT LIP OF URINAL ———

**10** W MEN'S RESTROOM

PART



4 A5-1

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15 A5-1

- MIRROR 2'-6"x4'-0"

WRGWB,

PAINT.


SUPPORT


BRACKET.


1/4" = 1'-0"

- WASTE RECEPTACLE.

1/4" = 1'-0"

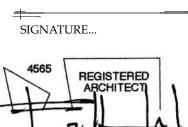


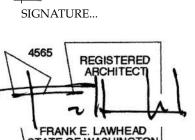

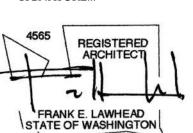

King County Housing

Authority

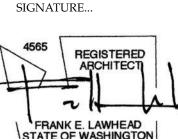


OWNER...

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**O**C

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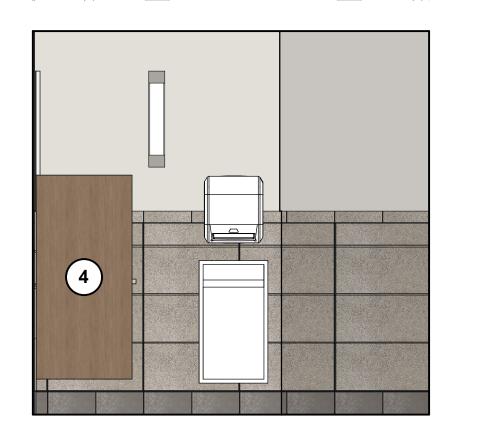
LAWHEAD


ARCHITECTS

P.S.

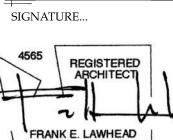- 1. SEE MECHANICAL & ELECTRICAL DRAWINGS FOR ADDITIONAL INFORMATION NOT SHOWN HERE.
- 2. FIELD VERIFY ALL EXISTING DIMENSIONS.
- 3. MODIFY EXISTING WALL FRAMING AS REQUIRED TO MAKE WAY FOR RECESSED FIXTURES, & TO PROVIDE ADDITIONAL SUPPORT BLOCKING FOR SURFACE-MOUNTED FIXTURES.
- REMOVE / REPLACE EXISTING INSULATION DISTURBED DURING WORK.
- 4. REINSTALL DOOR HARDWARE, SWITCH & RECEPTACLE PLATES, SIGNAGE, AND OTHER EQUIPMENT SALVAGED FOR REUSE AT ORIGINAL LOCATIONS.





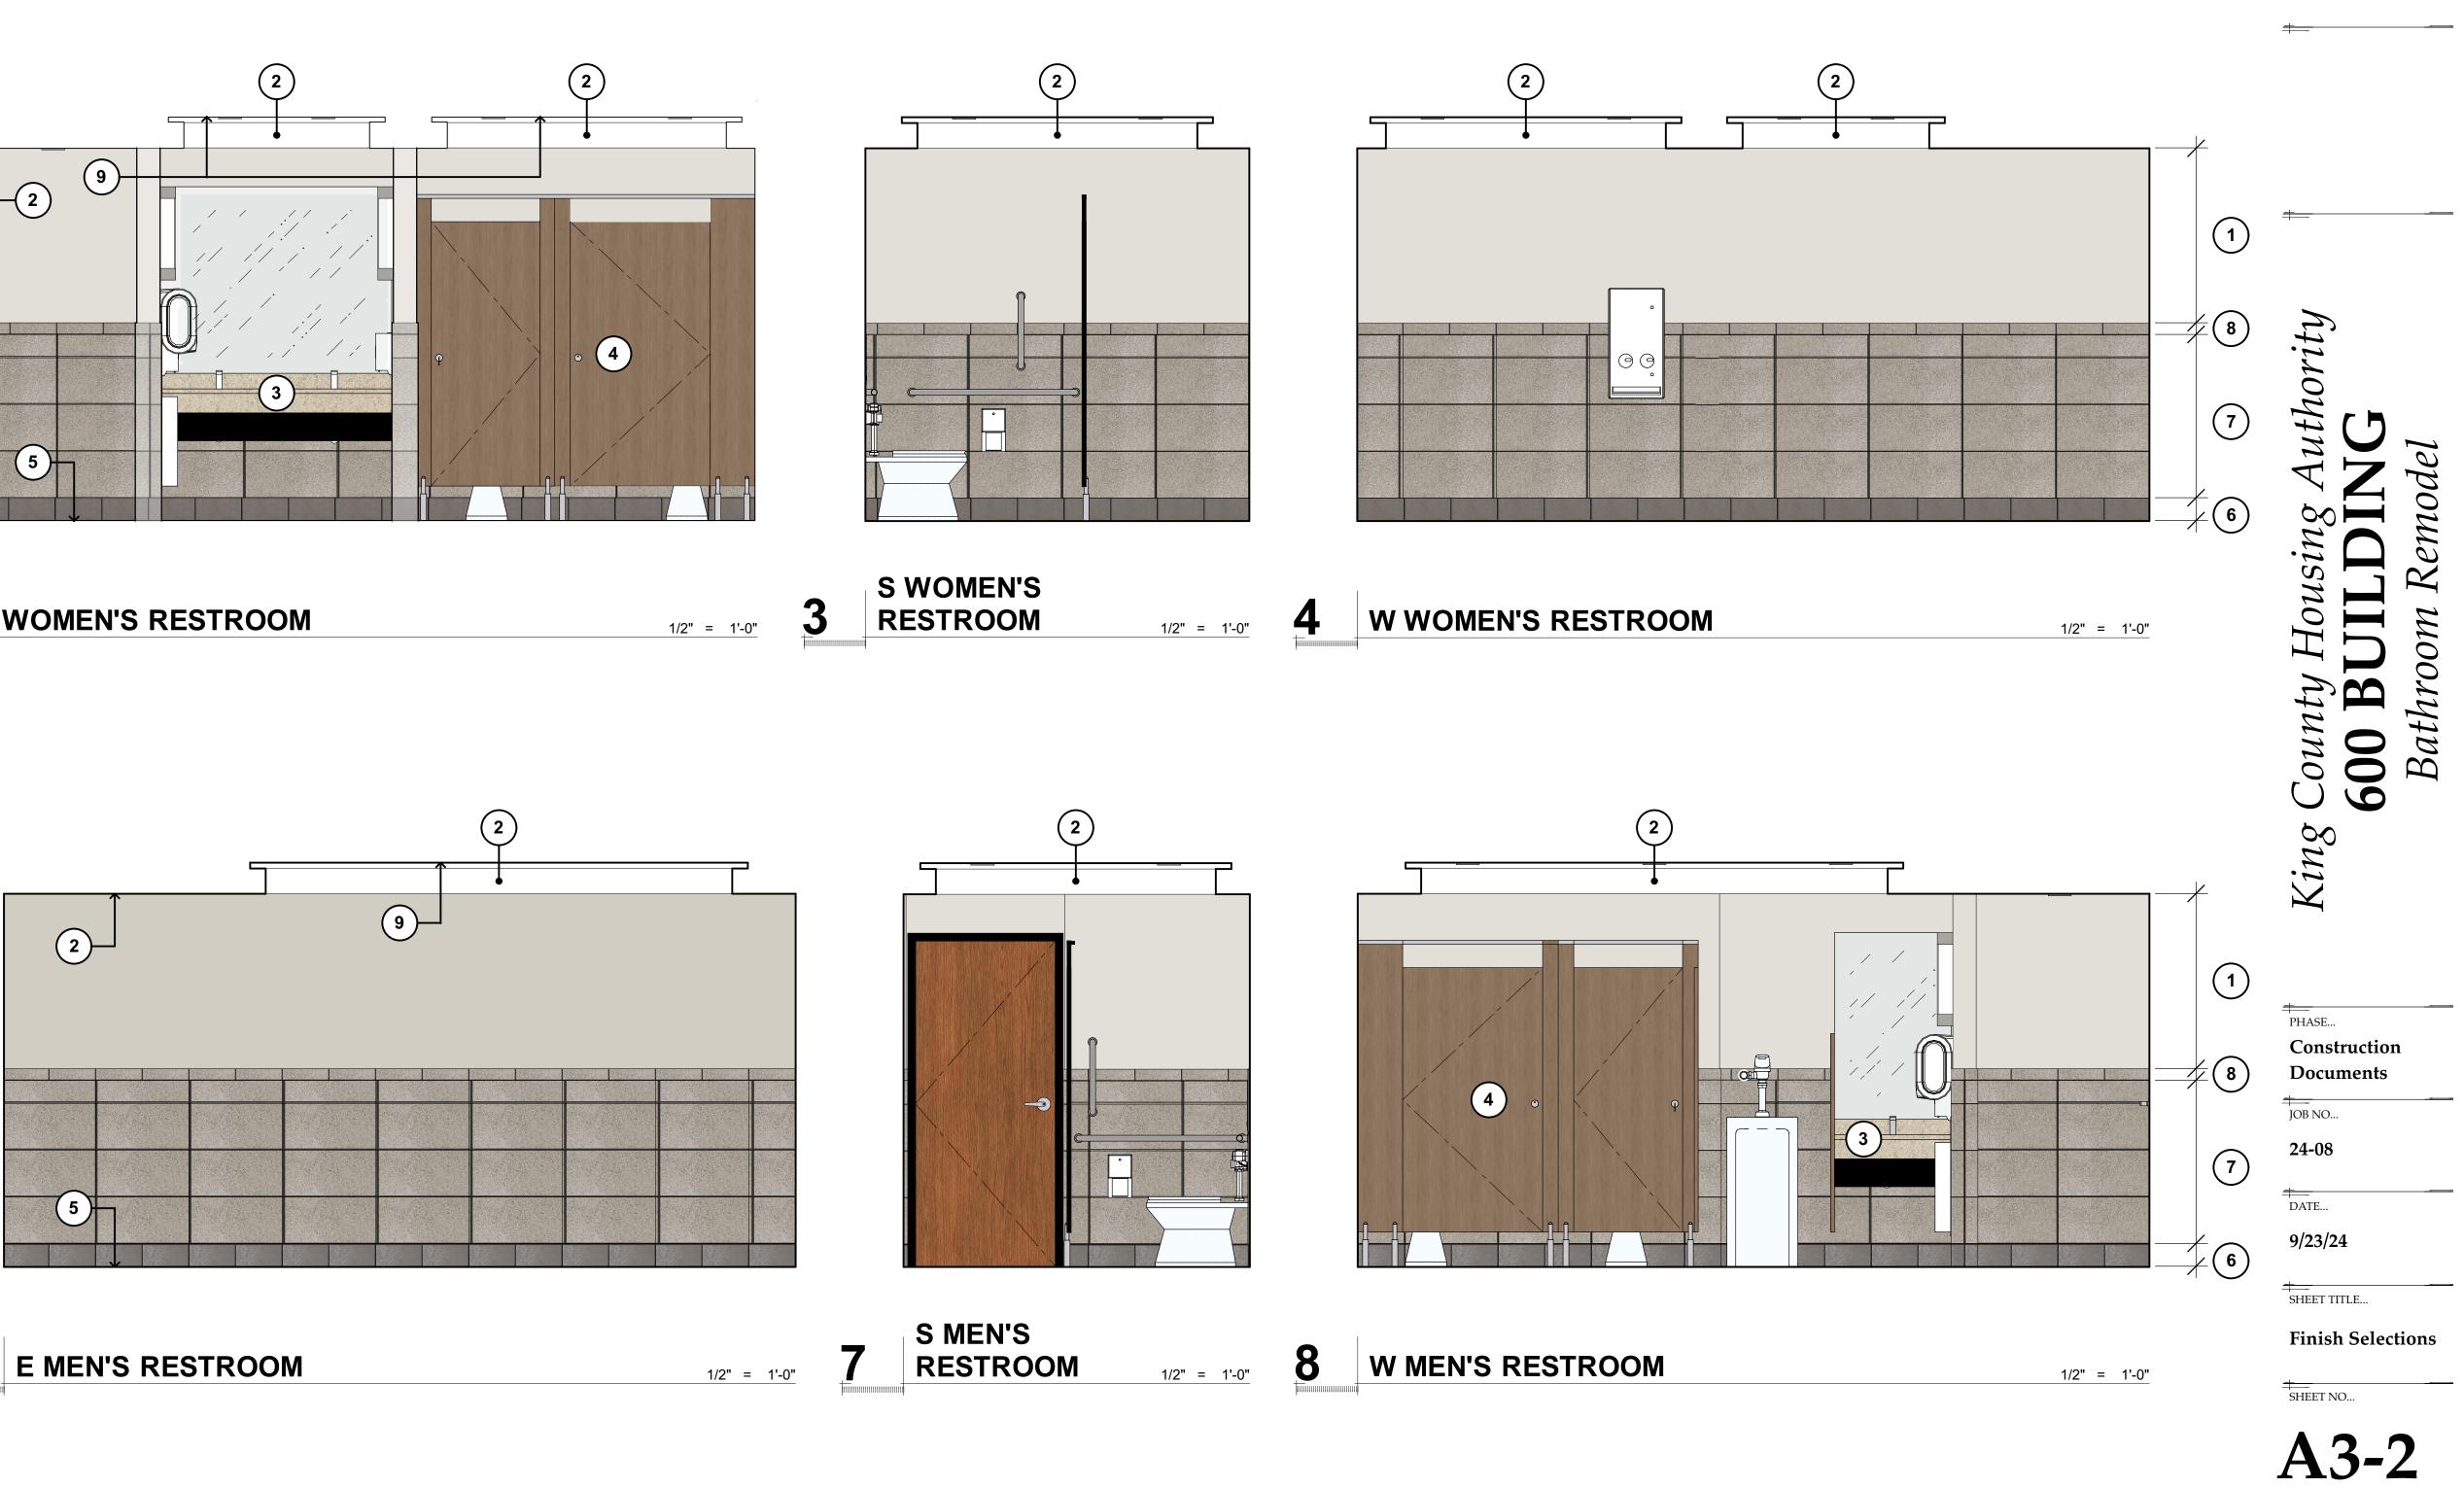



1

1/2" = 1'-0"

6

			FINISH L
NO.	MATERIAL	MANUFACTURER	PRODUCT SPEC.   GROUP
1-	PAINT	'SHERWIN-WILLIAMS'	INTERIOR ACRYLIC LATEX
2-	PAINT	'SHERWIN-WILLIAMS'	INTERIOR ACRYLIC LATEX
3-	QUARTZ RESIN	'CORIAN'	QUARTZ PORTFOLIO
<b>④</b> -	PLASTIC LAMINATE	'WILSONART'	PREMIUM LAMINATE (HW107)
<b>⑤</b> –	CERAMIC TILE	'DALTILE'	COLORBODY PORCELAIN   'STO   'DIGNITARY' SERIES
6 –	CERAMIC TILE	'DALTILE'	COLORBODY PORCELAIN   'STO   'HAUTE MONDE' SERIES
7-	CERAMIC TILE	'DALTILE'	COLORBODY PORCELAIN   'STO   'DIGNITARY' SERIES
8 –	CERAMIC TILE	'DALTILE'	COLORBODY PORCELAIN   'STO   'DIGNITARY' SERIES
9 –	PERFORATED WOOD CEILING TILE	'ARMSTRONG'	WOODWORKS VENEER

# LEGEND

TONE ATTACHÉ' COLLECTION SUPERIOR TAUPE (DR08)

STONE ATTACHÉ' COLLECTION GLITTERATI GRANITE (HM03)

- TONE ATTACHÉ' COLLECTION SUPERIOR TAUPE (DR08)
- STONE ATTACHÉ' COLLECTION
- NATURAL VARIATIONS MAPLE (NMP)

SUPERIOR TAUPE (DR08)


**COLOR SELECTION | FINISH** 


EIDER WHITE (SW 7014) | HIGH GLOSS


VENETIA CREAM | SINGLE POLISHED


HIGH REFLECTIVE WHITE (SW 7757) | HIGH GLOSS

DAINTREE (8235K-05) TIMBERGRAIN FINISH WITH 'AEON' | #60 MATTE FINISH

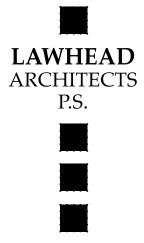

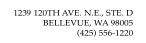


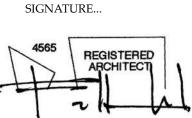


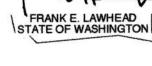

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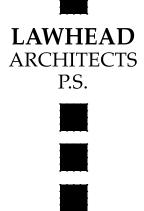


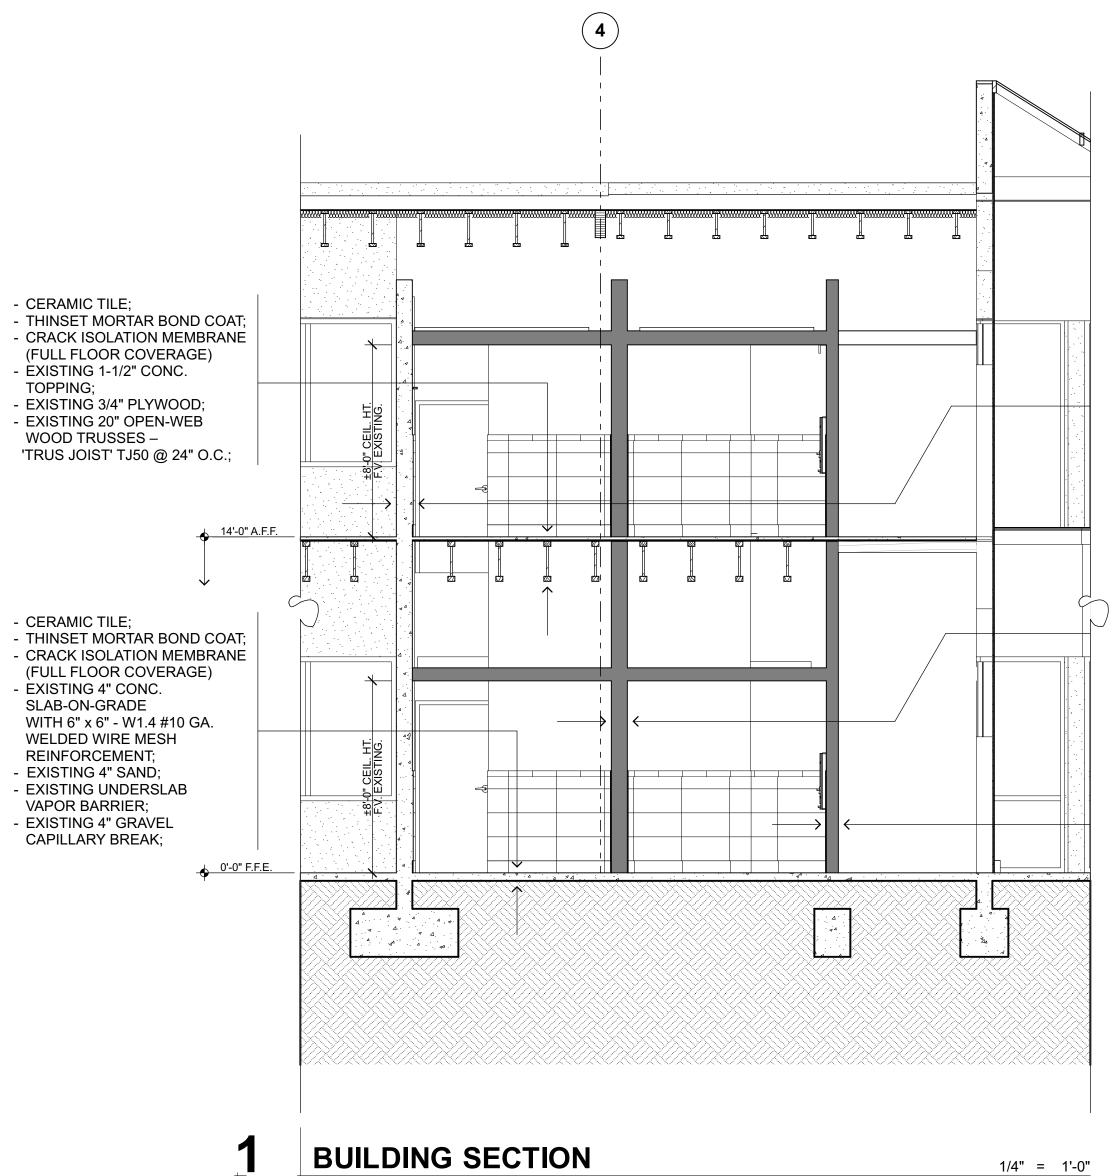


1/4" = 1'-0"
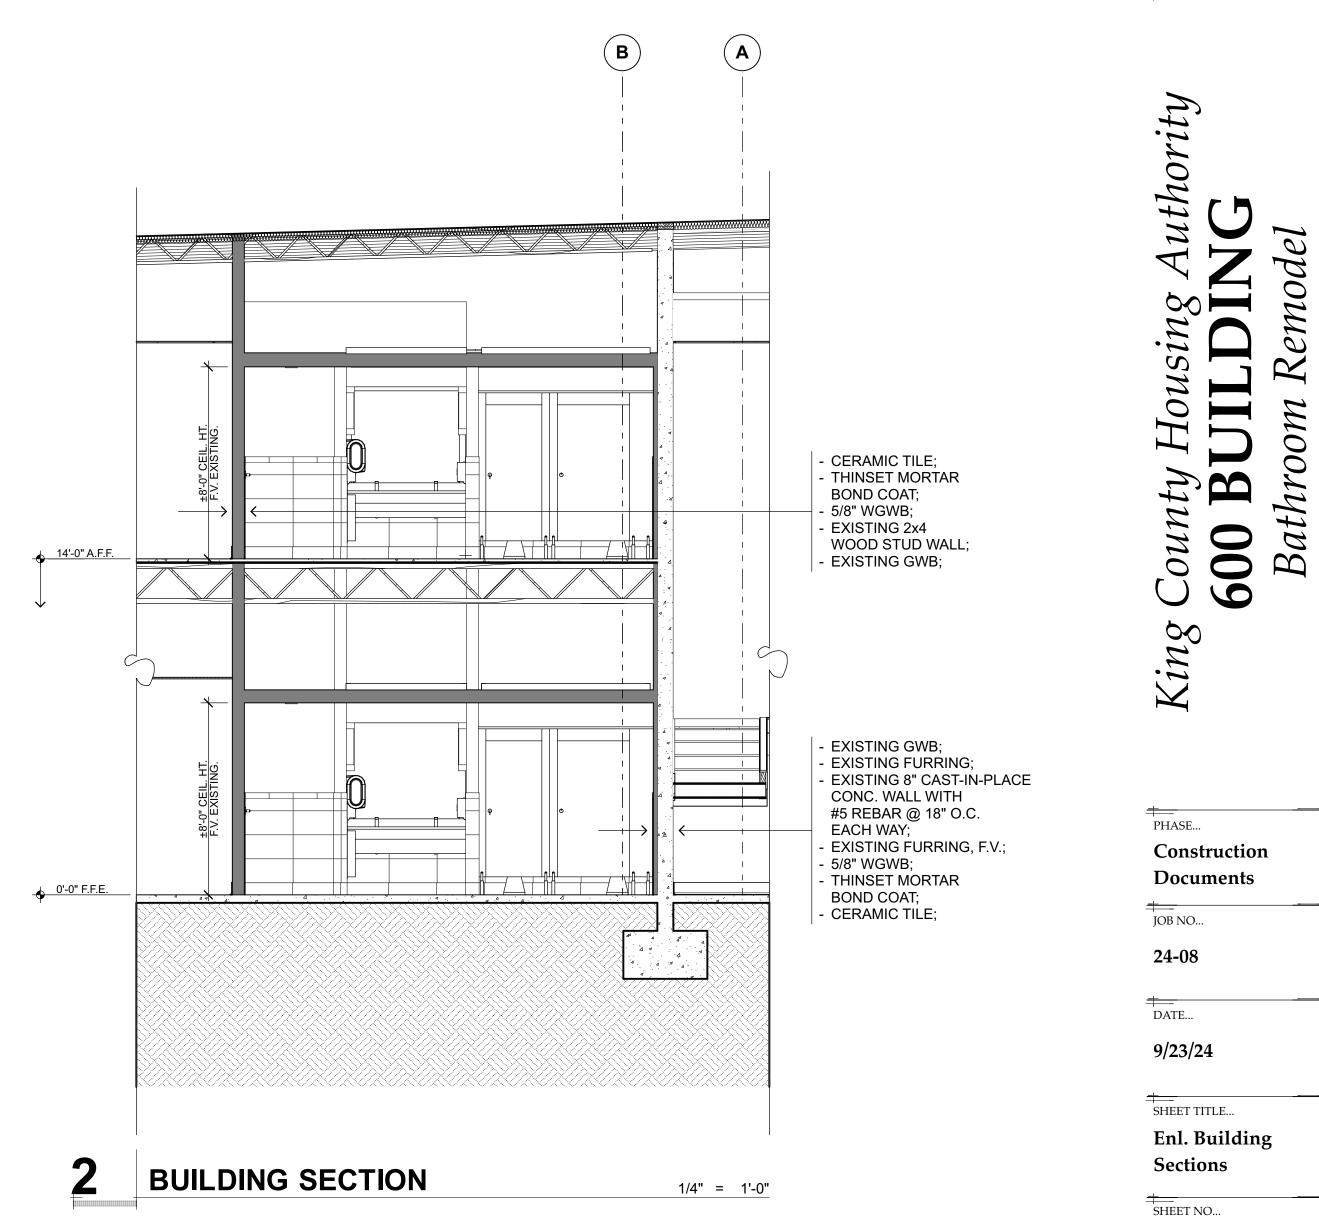
## **GENERAL NOTES:**

- 1. SEE MECHANICAL & ELECTRICAL FOR ADDITIONAL INFORMATION NOT SHOWN HERE.
- 2. FIELD VERIFY ALL EXISTING DIMENSIONS.
- FIELD VERIFY ALL EXISTING CONSTRUCTION. IMMEDIATELY REPORT ANY DISCREPANCIES FOUND TO ARCHITECT OR OWNER'S REPRESENTATIVE.







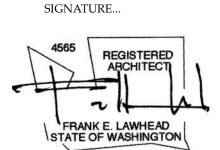








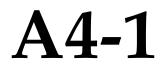

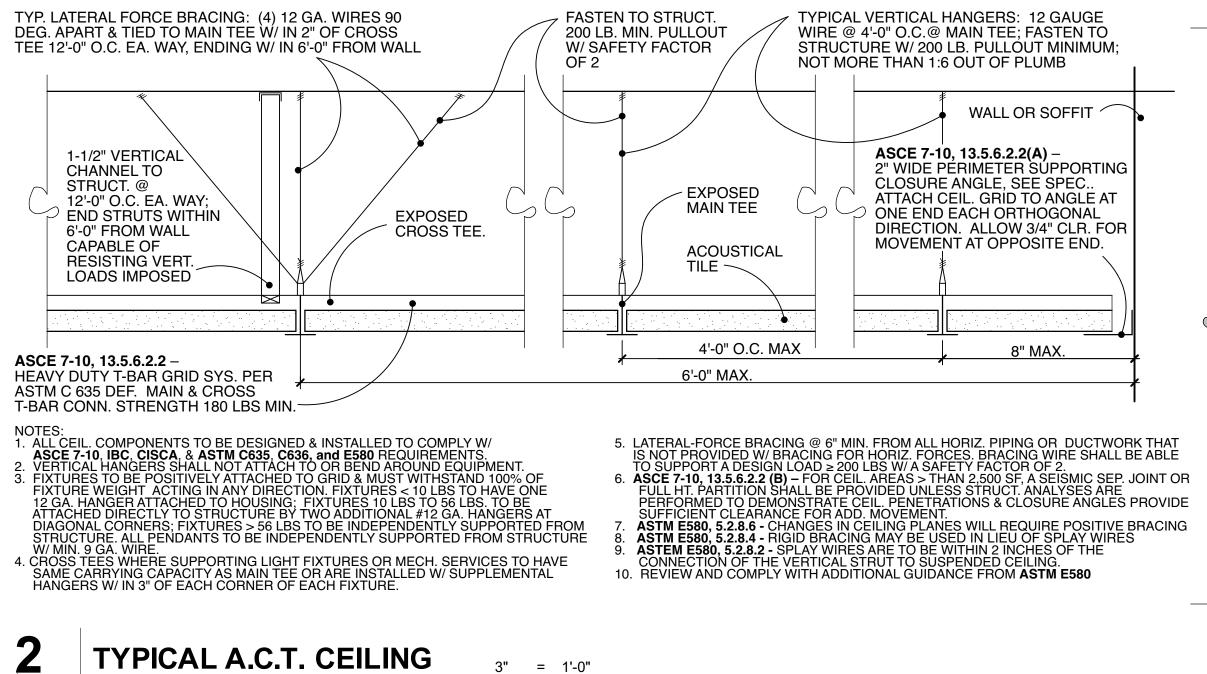

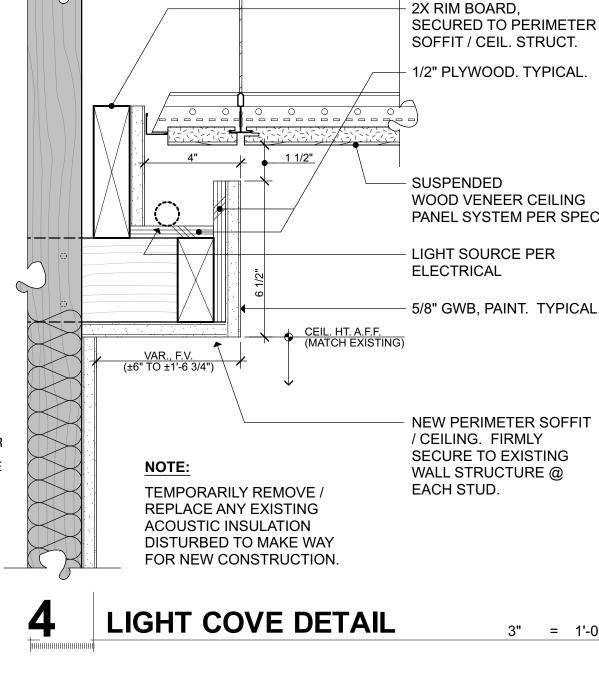

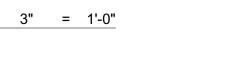

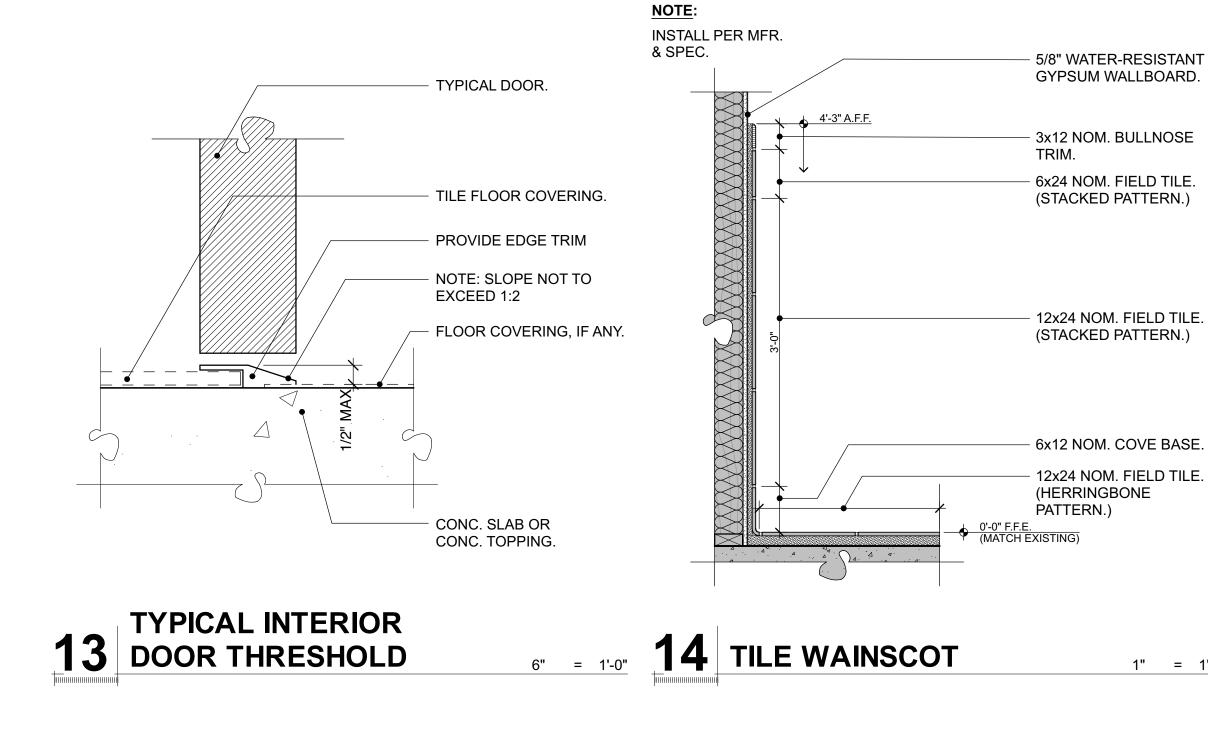

- 1. SEE MECHANICAL & ELECTRICAL DRAWINGS FOR ADDITIONAL INFORMATION NOT SHOWN HERE.
- 2. FIELD VERIFY ALL EXISTING DIMENSIONS.

1/2" PLYWOOD. TYPICAL.

WOOD VENEER CEILING PANEL SYSTEM PER SPEC.


- LIGHT SOURCE PER

- 5/8" GWB, PAINT. TYPICAL

NEW PERIMETER SOFFIT / CEILING. FIRMLY SECURE TO EXISTING WALL STRUCTURE @

3" = 1'-0"

- EXISTING CONSTRUCTION SHOWN SHADED

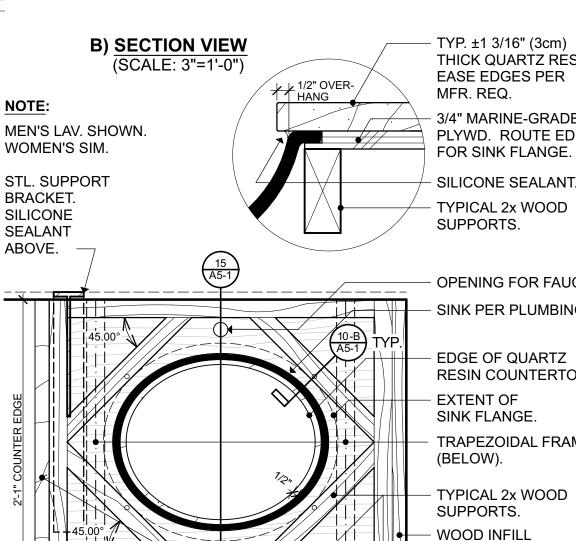

2'-0" O.C. MAX. A) RCP VIEW

1 1/2" OVER-HANG

- TYP. ±1 3/16" (3cm) THICK QUARTZ RESIN. EASE EDGES PER MFR. REQ. 3/4" MARINE-GRADE PLYWD. ROUTE EDGE

SILICONE SEALANT. TYPICAL 2x WOOD SUPPORTS.


OPENING FOR FAUCET. SINK PER PLUMBING

EDGE OF QUARTZ RESIN COUNTERTOP. EXTENT OF SINK FLANGE.


TRAPEZOIDAL FRAME (BELOW).

TYPICAL 2x WOOD SUPPORTS. WOOD INFILL AT WALL LEDGER. 5" HIGH QUARTZ RESIN SKIRT ON EXP. EDGES. MECH. SECURED.

**10** LAVATORY SINK PLAN 1 1/2"= 1'-0" OPENING FOR FAUCET (NOT SHOWN).

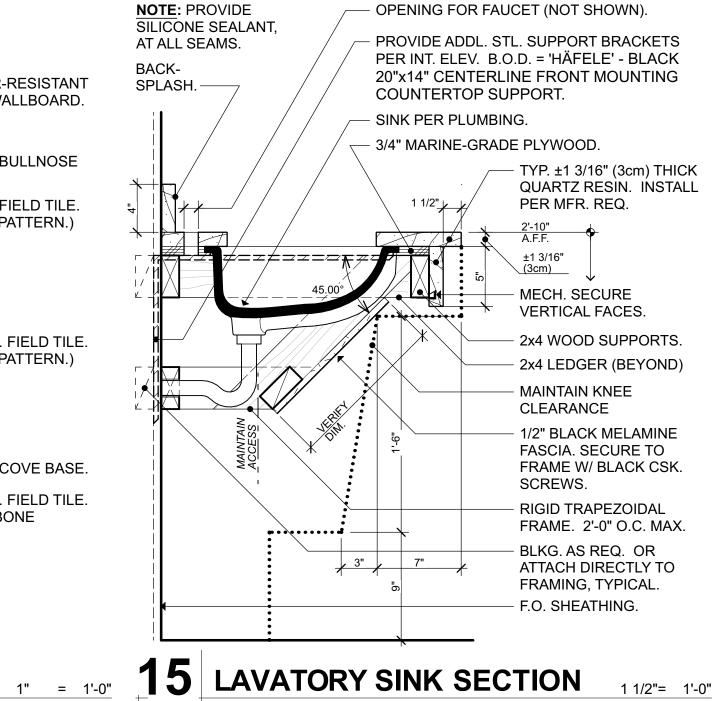



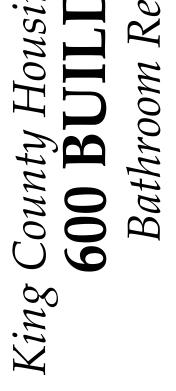

PHASE ... Construction Documents + -JOB NO...

24-08


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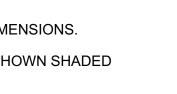
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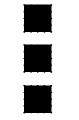
**Interior Details** 

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LAWHEAD ARCHITECTS P.S.



1239 120TH AVE. N.E., STE. D

REGISTERE
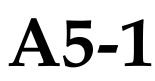
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FRANK E. LAWHEAD

STATE OF WASHINGTON

ABCHITEC

SIGNATURE ...

4565

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OWNER...

BELLEVUE, WA 98005

(425) 556-1220

King County

Housing

Authorit





# **GENERAL MECHANICAL DEMOLITION NOTES**

- DEMOLITION DRAWINGS ARE INTENDED TO ONLY GIVE A GENERAL REPRESENTATION OF THE 1. DEMOLITION INVOLVED, AND DO NOT CONSTITUTE A FULL LISTING OF ALL ITEMS REQUIRING REMOVAL. SEE SPECIFICATIONS & THESE GENERAL NOTES FOR REQUIREMENTS.
- 2. IT IS THE CONTRACTOR'S RESPONSIBILITY TO REVIEW SITE CONDITIONS AND TO IDENTIFY ALL DEMOLITION WORK, AND INCLUDE IN HIS BID ALL COSTS FOR DEMOLITION & DISPOSAL.
- EXISTING DUCTS, EQUIPMENT, PIPING, AIR INLETS/OUTLETS, PLUMBING FIXTURES SHOWN DASHED REPRESENT MAJOR MECHANICAL ITEMS TO BE REMOVED. SEE GENERAL NOTES, DRAWING NOTES & KEYED NOTES WHICH COVER ALL OTHER MISC. MECHANICAL ITEMS TO BE REMOVED.
- 4. ALL EXISTING ITEMS NOT BEING REUSED SHALL BE REMOVED. THIS INCLUDES SUCH ITEMS AS THERMOSTATS, CONTROL DEVICES, DUCTS, FANS, PIPING, GRILLES, SUPPORTS, VALVES, CURBS, AND RELATED ACCESSORIES.
- 5. PATCH ALL WALL/FLOOR/CEILING OPENINGS LEFT BY REMOVAL OF EXISTING ITEMS. PATCH SO AS TO MATCH FINISH OF ADJACENT UNDISTURBED AREA.
- REFERENCE ARCHITECTURAL DRAWINGS FOR WHERE CEILING/WALL AND OTHER GENERAL 6. DEMOLITION WORK IS BEING DONE.
- SEE MECHANICAL FLOOR PLANS FOR HVAC DUCTS THAT ARE BEING REUSED.
- WHERE EXISTING PLUMBING FIXTURES ARE REMOVED, CAP OFF CW, HW, VENT & WASTE PIPING AT A 8. CONCEALED LOCATION (I.E. ABOVE CEILING OR INSIDE WALL).
- 9. PROVIDE TEMPORARY CAP-OFF OF ALL EXIST. SYSTEMS TO ALLOW CONTINUED USE OF ALL SYSTEMS UNTIL THE FINAL SYSTEM COMPONENTS ARE INSTALLED AND CONNECTED (INCLUDE HWS/HWR AT EACH RHI, RHU; FIRE SPRINKLERING, ETC.).
- 10. VERIFY SIZE & LOCATION OF ALL EXISTING ITEMS SHOWN TO BE DEMO'D. LOCATIONS SHOWN ARE APPROXIMATE AND ARE BASED ON OWNER'S AS-BUILTS.


# **MECHANICAL GENERAL NOTES**

- 1. ALL ITEMS ARE NEW UNLESS SPECIFICALLY NOTED AS EXISTING.
- 2. FIXTURE LOCATIONS: VERIFY LOCATION OF PLUMBING FIXTURES WITH ARCHITECTURAL DRAWINGS BEFORE BEGINNING WORK. ARCHITECTURAL DRAWINGS GOVERN. PLUMBING FIXTURE HEIGHTS SHALL BE AS SHOWN ON ARCHITECTURAL DRAWINGS.
- 3. ALL PIPING & DUCTWORK SHOWN IS SCHEMATIC, CONTRACTOR SHALL PROVIDE ALL OFFSETS/ELBOWS AS REQ'D TO ALLOW ROUTING AROUND STRUCTURE, ELECTRICAL, & OTHER INTERFERENCES.
- 4. BUILDING FEATURES AND PIPING LOCATIONS & SIZES SHOWN ON PLANS ARE APPROXIMATE & ARE BASED ON AS-BUILT DATA PROVIDED BY THE OWNER, A COMPLETE REVIEW IS REQUIRED TO BE MADE BY THE CONTRACTOR. VERIFY SIZES PRIOR TO BIDDING AND BEGINNING WORK.
- 5. CONTRACTOR SHALL VERIFY LOCATIONS OF ALL EXISTING EQUIPMENT, PIPING, WALLS, SUPPORTS, ELECTRICAL AND RELATED BUILDING FEATURES AND RELOCATE/REVISE SUCH EXISTING ITEMS AS NECESSARY TO ALLOW FOR THE WORK INDICATED.
- 6. CONTRACTOR SHALL FIELD VERIFY THE SIZES AND LOCATIONS OF ALL EXISTING ITEMS SHOWN BEING CONNECTED TO. VERIFICATION SHALL OCCUR PRIOR TO MATERIALS BEING ORDERED OR FABRICATED.
- 7. CONTRACTOR SHALL VISIT THE SITE PRIOR TO BIDDING TO REVIEW AND VERIFY EXISTING CONDITIONS AND CONSTRUCTION MATERIALS, INCLUDING, BUT NOT LIMITED TO, ALL WALLS, FLOORS, CEILINGS, AND OTHER AREAS THAT MAY BE DISTURBED DURING CONSTRUCTION IN ORDER TO ACCOMPLISH THE WORK IN THESE DOCUMENTS. THE CONTRACTOR SHALL ALSO VISIT THE SITE AGAIN PRIOR TO BEGINNING ANY WORK.
- 8. PROVIDE PIPING TRANSITIONS AS NECESSARY TO CONNECT TO EXISTING SYSTEMS. SUCH SYSTEMS SHALL BE FIELD REVIEWED FOR SIZE, DIRECTION OF FLOW, LOCATION AND TYPE PRIOR TO ORDERING/FABRICATING SUCH TRANSITIONS BECAUSE OWNER PROVIDED AS-BUILT DRAWINGS THAT SHOW SUCH INFORMATION ARE CONSIDERED APPROXIMATE. CONTRACTOR SHALL ASSUME IN HIS BID ONE TRANSITION FOR EACH CONNECTION TO EXISTING SYSTEMS. PIPING CONNECTIONS ON EXISTING ITEMS MAY BE ONE PIPE SIZE SMALLER OR LARGER THAN SHOWN.

# FIRE SPRINKLER NOTES

- 1. FIRE SPRINKLER SYSTEM & WORK IS CONTRACTOR DESIGN/BUILD.
- 2. BUILDING HAS AN EXISTING FIRE SPRINKLER SYSTEM.
- 3. PROVIDE MODIFICATIONS TO (E) SYSTEM TO ACCOMMODATE REVISED CEILING AND OTHER WORK. SEE ARCHITECTURAL DRAWINGS.
- 4. REVIEW ARCHITECTURAL AND ALL OTHER DRAWINGS FOR BUILDING DETAILS AND LAYOUT.
- 5. COORDINATE WITH ALL TRADES IN ROUTING OF SPRINKLER PIPING TO AVOID CONFLICTS. FIRE PROTECTION SYSTEM HAS THE LOWEST PRIORITY OF ITEMS RAN IN THE CEILING. PROVIDE OFFSETS AS REQUIRED.
- 6. ALL FIRE SPRINKLER HEADS SERVING OCCUPIED AREAS OF THE BLDG SHALL BE QUICK RESPONSE TYPE.
- 7. ALL FIRE SPRINKLER HEADS SHALL BE LOCATED TO BE SYMMETRICAL WITHIN SPACES SERVED AND BUILDING ARCHITECTURAL FEATURES.
- 8. PIPING SHALL BE RAN CONCEALED.

MECHANICAL LEGEND						
SYMBOL	DESCRIPTION	SYMBOL	DESCRIPTION			
	WASTE OR SOIL (W)	AFF AHJ	ABOVE FINISHED FLOOR AUTHORITY HAVING JURISDICTION			
	VENT (V)	APPROX	APPROXIMATELY			
	COLD WATER (CW)	ARCH ASSY	ARCHITECTURAL ASSEMBLY			
	HOT WATER (HW)	BDD	BACKDRAFT DAMPER			
	HOT WATER CIRCULATING (HWC)	B.O.D. BTU	BOTTOM OF DUCT BRITISH THERMAL UNIT			
		BTUH BLDG	BRITISH THERMAL UNIT/HOUR BUILDING			
۲	FLOOR CLEANOUT (FCO) OR SURFACE CLEANOUT (SCO)	CAP	CAPACITY			
	ISOLATION VALVE	CLG CO	CEILING CLEANOUT			
O	PIPE UP	COP	COEFFICIENT OF PERFORMANCE			
)	PIPE DOWN	COMP CONN	COMPRESSOR CONNECTION			
	PIPE TEE IN LINE, BRANCH PIPE DOWN	CONT CFH	CONTINUE, CONTINUATION CUBIC FEET PER HOUR			
20/12		CFH CFM	CUBIC FEET PER MINUTE			
	DUCT (FIRST FIGURE, SIDE SHOWN)	CW CWV	COLD WATER COMBINATION WASTE/VENT			
	DUCT SECTION (EXHAUST OR RETURN)	DEG F, °F	DEGREE FAHRENHEIT			
	VOLUME DAMPER (MANUAL)	DIA, Ø DN	DIAMETER DOWN			
	ELBOW WITH TURNING VANES	DWG	DRAWING			
	DUCT UP (RECTANGULAR)	DB EA	DRY BULB EACH			
		ECM	ELECTRONIC COMMUTATED MOTOR			
	DUCT DOWN (RECTANGULAR)	EF EFF	EXHAUST FAN EFFICIENCY			
SIZE,SYMBO		ELEC	ELECTRICAL, ELECTRIC			
		EER EAT	ENERGY EFFICIENCY RATIO ENTERING AIR TEMPERATURE			
		EWB	ENTERING WET BULB			
		EDB EOL	ENTERING DRY BULB END OF LINING			
		EXH	EXHAUST			
		ESP FV	EXTERNAL STATIC PRESSURE FACE VELOCITY			
		FPM	FEET PER MINUTE			
		FLEX	FLEXIBLE FLOOR			
		FCO	FLOOR CLEAN OUT			
		FLA GAL	FULL LOAD AMPS GALLON			
		HP	HORSE POWER			
		HW HWC	HOT WATER HOT WATER CIRCULATION			
		INTEGR. IN	INTEGRAL INCH			
		KW	KILOWATT			
		L LAT	LINING LEAVING AIR TEMPERATURE			
			LEAVING ARY BULB			
		LWT LWB	LEAVING WATER TEMPERATURE LEAVING WET BULB			
		MAX	MAXIMUM			
		MFR MBH	MANUFACTURER THOUSAND BTUH			
		MCA	MINIMUM CIRCUIT AMPACITY			
		OFCI MECH	OWNER FURNISHED, CONTRACTOR INSTALLED MECHANICAL			
		MIN	MINIMUM			
		NO NTS	NUMBER NOT TO SCALE			
		OBD	OPPOSED BLADE DAMPER			
		PH PD	PHASE PRESSURE DROP			
		— R	RETURN			
		REF REL	REFERENCE RELIEF			
		RLA	RATED LOAD AMPS			
		REQ'D RPM	REQUIRED REVOLUTIONS PER MINUTE			
		SCO S.O.	SURFACE CLEANOUT SCREENED OPENING			
			STAINLESS STEEL			
		TEMP TD	TEMPERATURE TRANSFER DUCT			
		TG	TRANSFER GRILLE			
		TYP UG	TYPICAL UNDER GROUND			
		UNO	UNLESS NOTED OTHERWISE			
		V WC	VOLTS, VOLTAGE, VENT WATER COLUMN			
			WATER COLUMN WALL CLEAN OUT			
		W	WASTE WATT			
2	- DETAIL/SECTION IDENTIFICATION NUMBER	WB	WET BULB			
( <u>2</u> (M3.1)	- SHEET ON WHICH DETAIL IS SHOWN	W/	WITH			

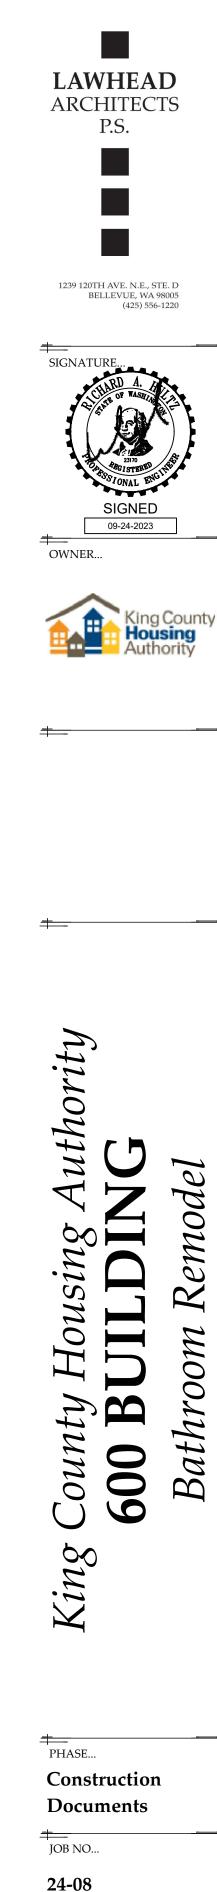

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DATE...

9/23/24

SHEET TITLE ... MECHANICAL LEGEND AND NOTES

SHEET NO...





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	FAN SCHEDULE											
SYMBOL	BASIS OF DESIGN MANUFACTURER AND SERIES NO.	AREA SERVED	CFM	ESP	MAX	X ELECTRICAL		DRIVE	CONTROL	MAX WEIGHT	REMARKS	
OTMIDOL					LOP	RPM	HP	VOLTS / PH		CONTROL	LBS	
EF-1	COOK 100C17DEC	ROOFTOP	FIRST FLOOR RESTROOMS	650	0.5"	1725	1/4	115/1	DIRECT	TIME CONTROL	50	
EF-2	COOK 100C17DEC	ROOFTOP	SECOND FLOOR RESTROOMS	650	0.5"	1725	1/4	115/1	DIRECT	TIME CONTROL	50	
NOTES:	NOTES: 1. PROVIDE FANS WITH EC MOTORS WITH SPEED ADJUSTMENT (MOTOR MOUNTED) OR VARIABLE FREQUENCY DRIVES.											


- 2. PROVIDE FANS WITH DISCONNECT.
- 3. PROVIDE ALL ROOFTOP FANS WITH ADAPTER CURBS.

# **AIR INLET & OUTLET SCHEDULE**

SYMBOL	ТҮРЕ	MANUFACTURER AND SERIES NUMBER	REMARKS				
CEG	CEILING EXHAUST GRILLE	KRUEGER SERIES EGC-5	1/2"x1/2"x1/2" CUBE CORE				
CTG	CEILING TRANSFER GRILLE	KRUEGER SERIES EGC-5	1/2"x1/2"x1/2" CUBE CORE				
NOTES:							
1. ALL AIR TERMINALS SHALL HAVE FACTORY FINISH, COLOR AS SELECTED BY ARCHITECT.							
2. SEE LEGEND FOR TERMINOLOGY USED IN AIR TERMINAL CALL-OUTS ON DRAWINGS.							

3. SEE ARCH. FINISH SCHEDULE FOR CEILING TYPES, PROVIDE AIR TERMINALS TO MATCH CEILING CONSTRUCTION INSTALLED IN.


	PLUMBING FIXTURE SCHEDULE								
SYMBOL	DESCRIPTION	w	v	cw	нw	REMARKS			
P-1A	WATER CLOSET	4"	2"	1"	-	FLOOR MOUNT, ADA ACCESSIBLE, SENSOR FLUSH VALVE			
P-2A	URINAL	-	-	3/4"	-	(E) FIXTURE, SENSOR FLUSH VALVE REPLACEMENT			
P-3A	LAVATORY	1-1/2"	1-1/2"	1/2"	1/2"	UNDERMOUNT, ADA ACCESSIBLE, SENSOR FAUCET			

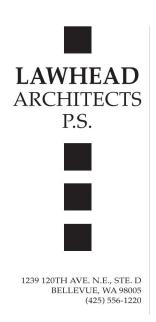





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# PHASE...

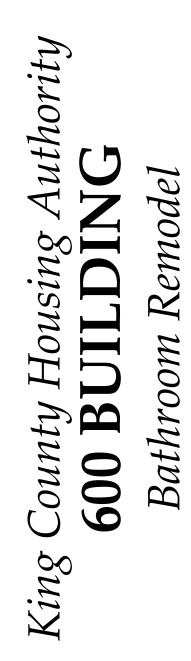Construction Documents

JOB NO...

24-08

DATE... 9/23/24

SHEET TITLE... MECHANICAL SCHEDULES

SHEET NO...







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RECEPTION


**(C**)

SCALE: 1/4" = 1'-0"

B A

OFFICE

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# GENERAL NOTES:

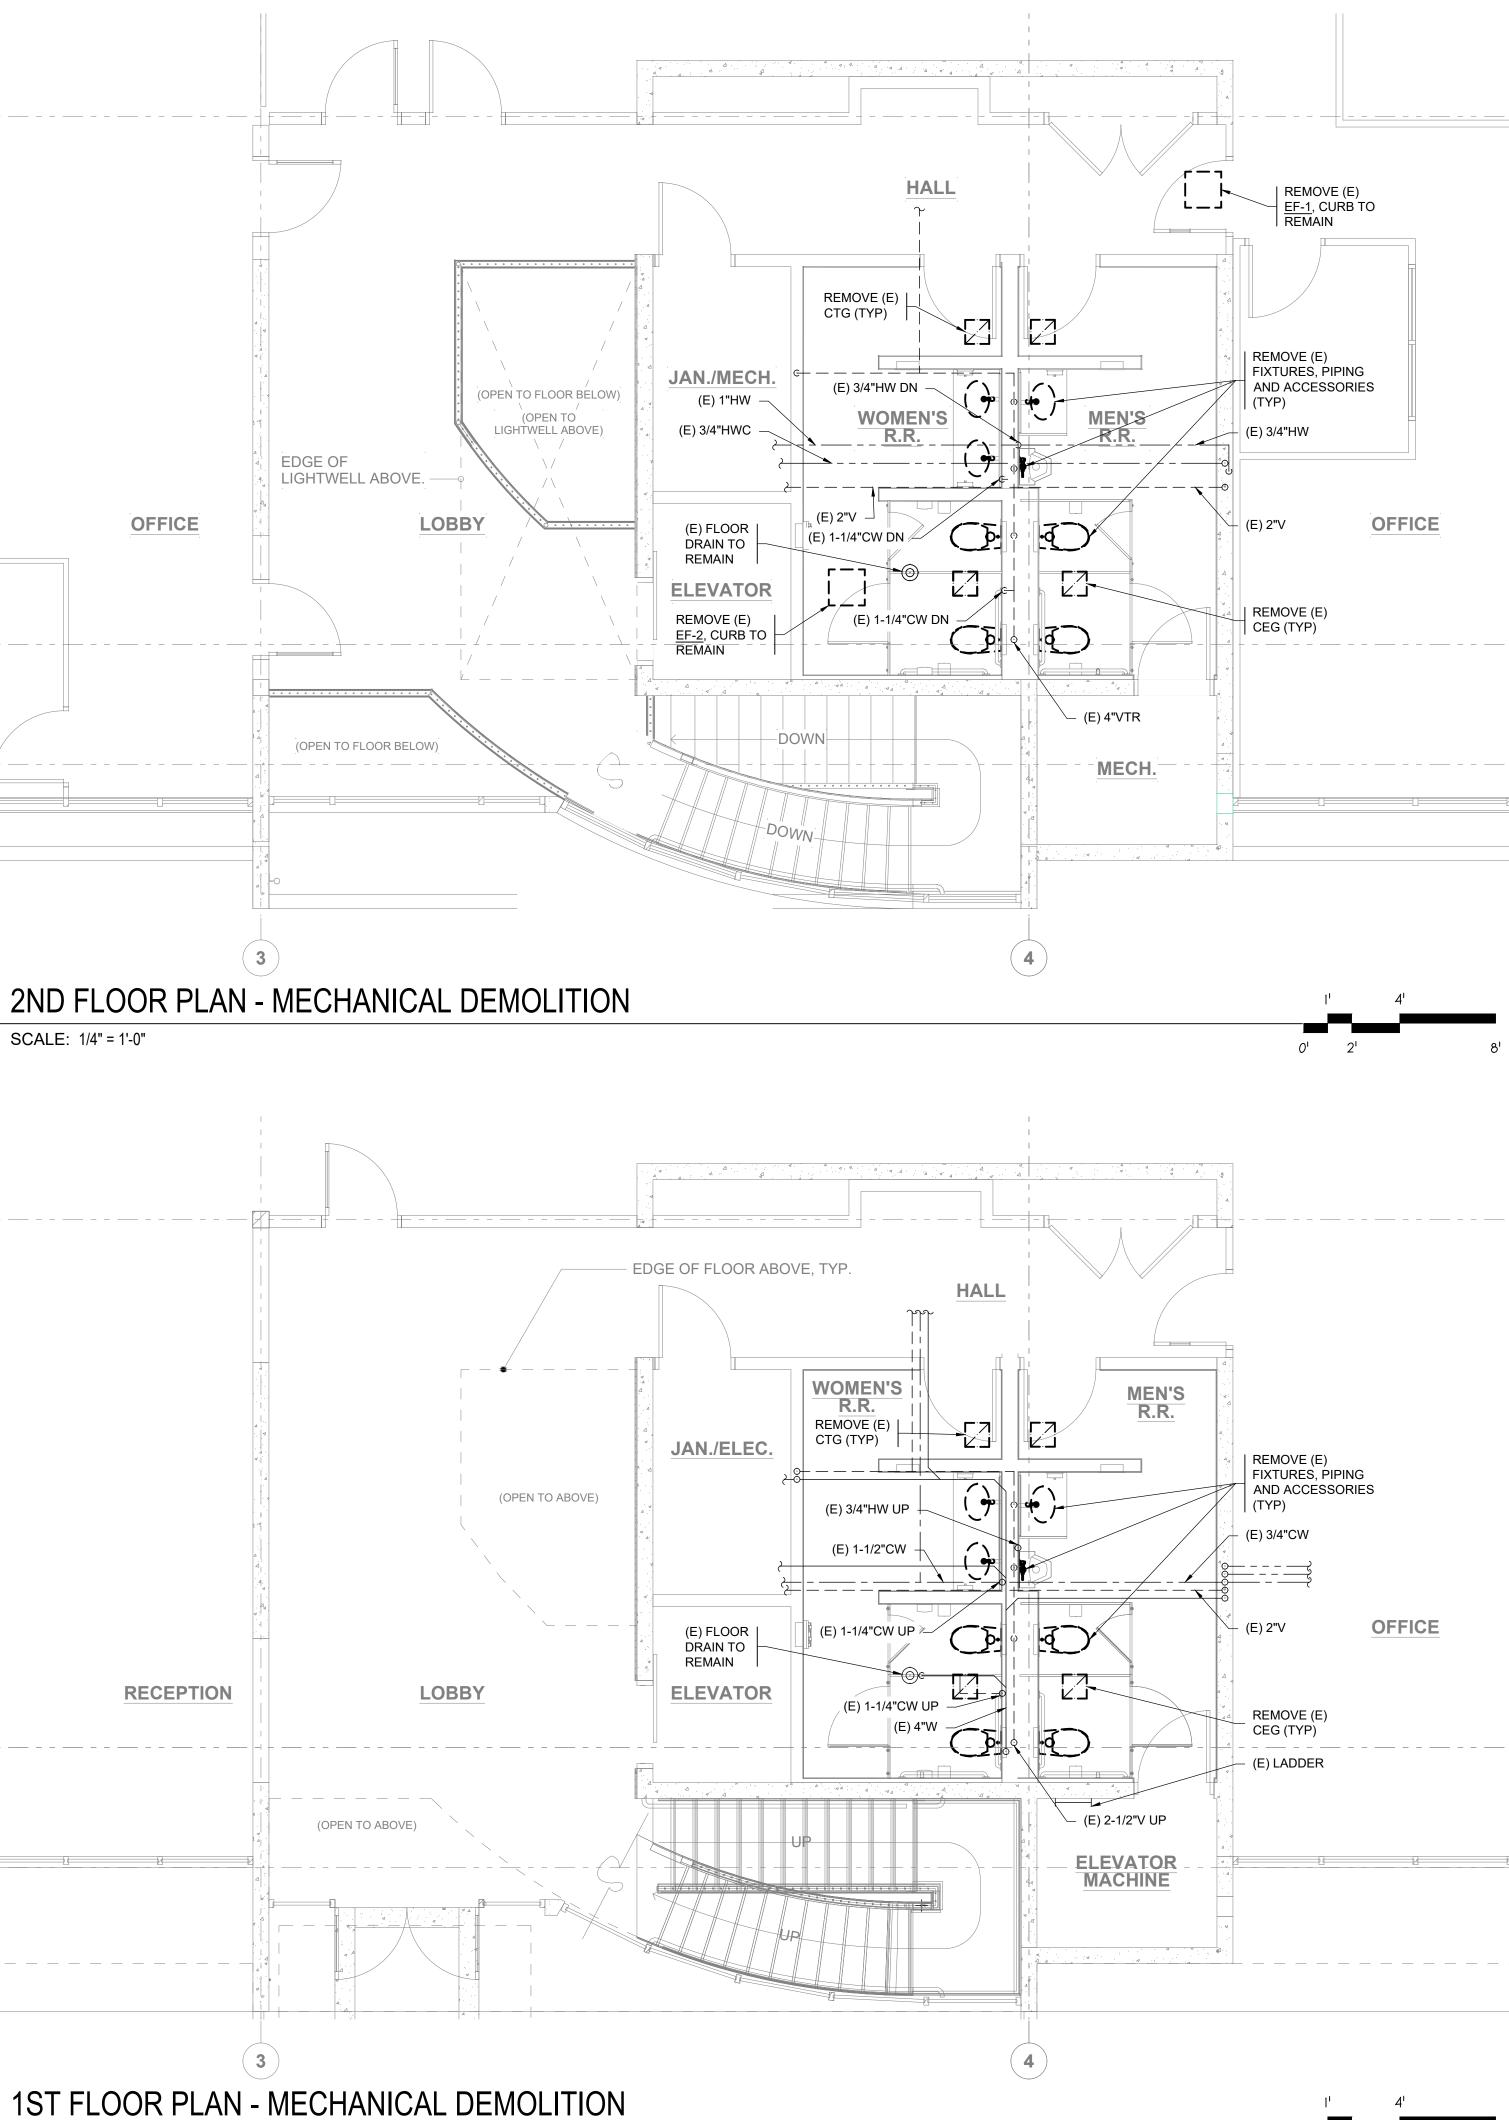1. SEE MECHANICAL GENERAL NOTES AND MECHANICAL DEMOLITION NOTES ON SHEET M0-1.

LAWHEAD ARCHITECTS P.S.









#### +----PHASE ...


Construction Documents

+---JOB NO... 24-08

<del>\_\_\_\_</del> Date... 9/23/24

SHEET TITLE... ENLARGED DEMOLITION PLANS

SHEET NO...

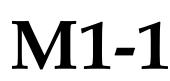

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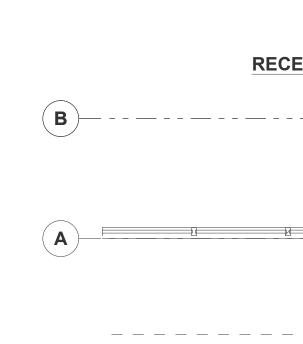
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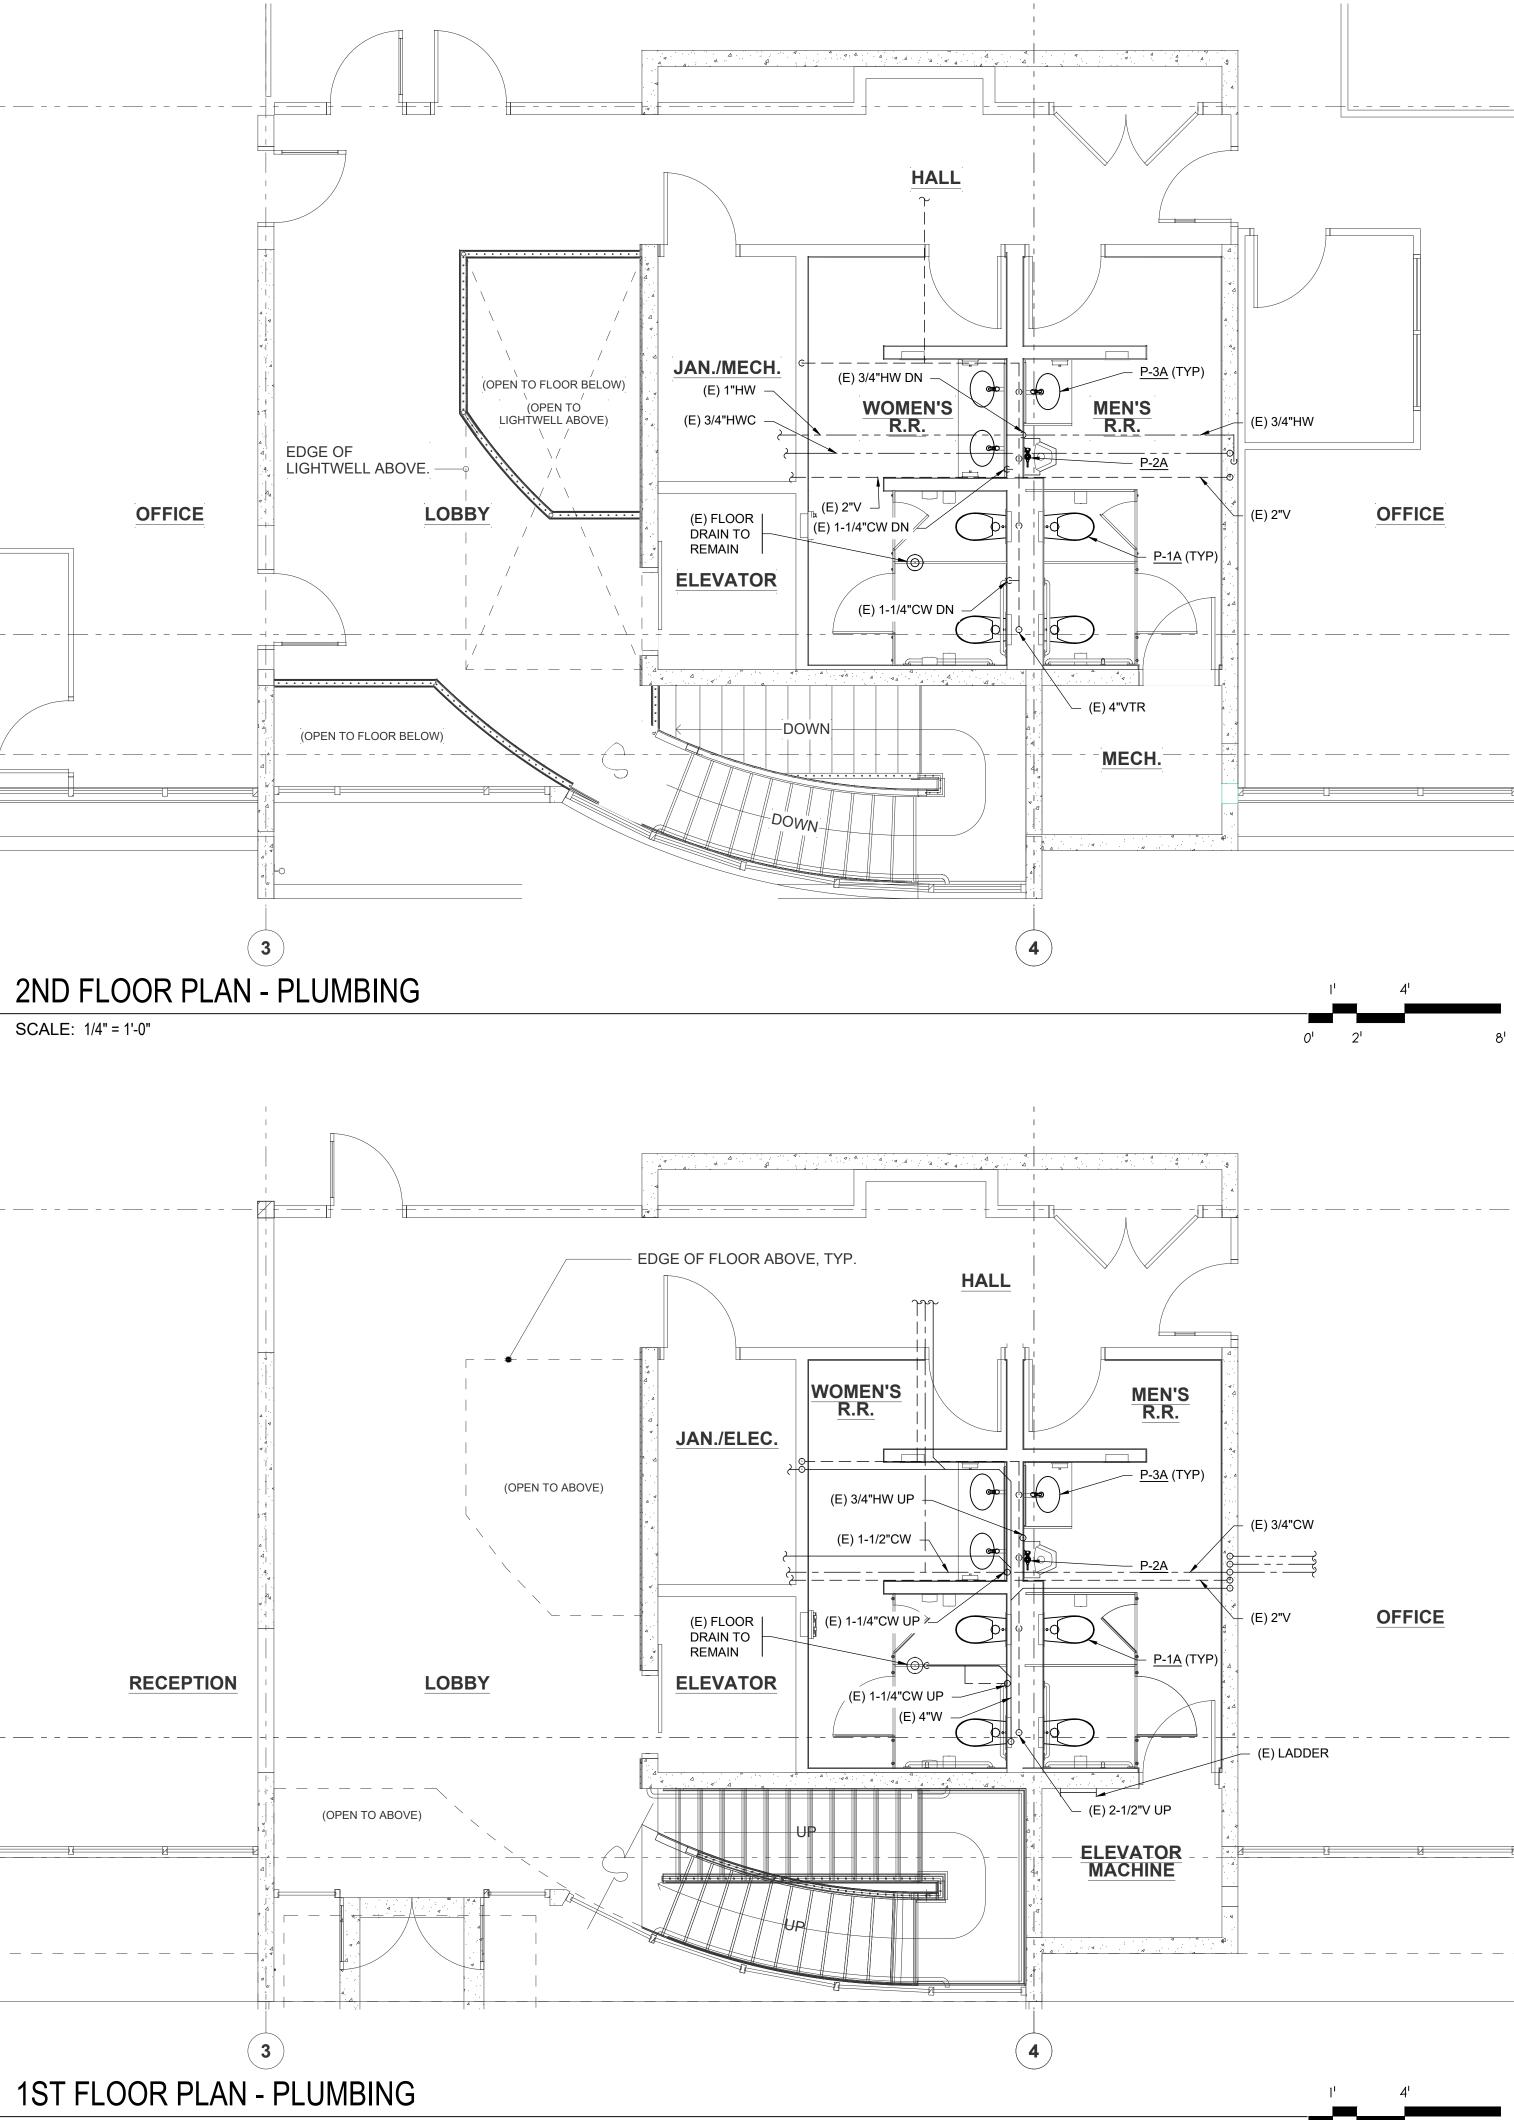














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# GENERAL NOTES:

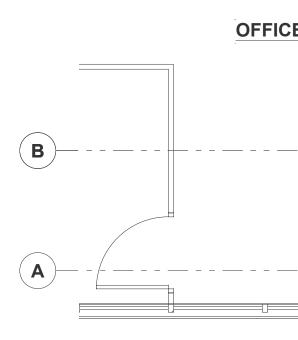- 1. SEE MECHANICAL GENERAL NOTES SEE SHEET M0-1.
- 2. REVISE EXISTING PLUMBING ROUGH-IN AS REQ'D TO ACCOMMODATE NEW FIXTURES.







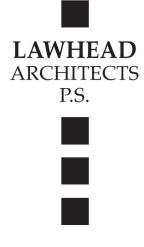



#### +----PHASE ...

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24-08

DATE... 9/23/24

SHEET TITLE... ENLARGED PLUMBING PLANS

SHEET NO...

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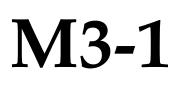
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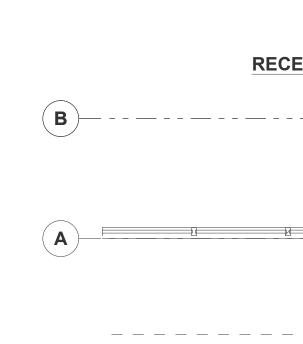
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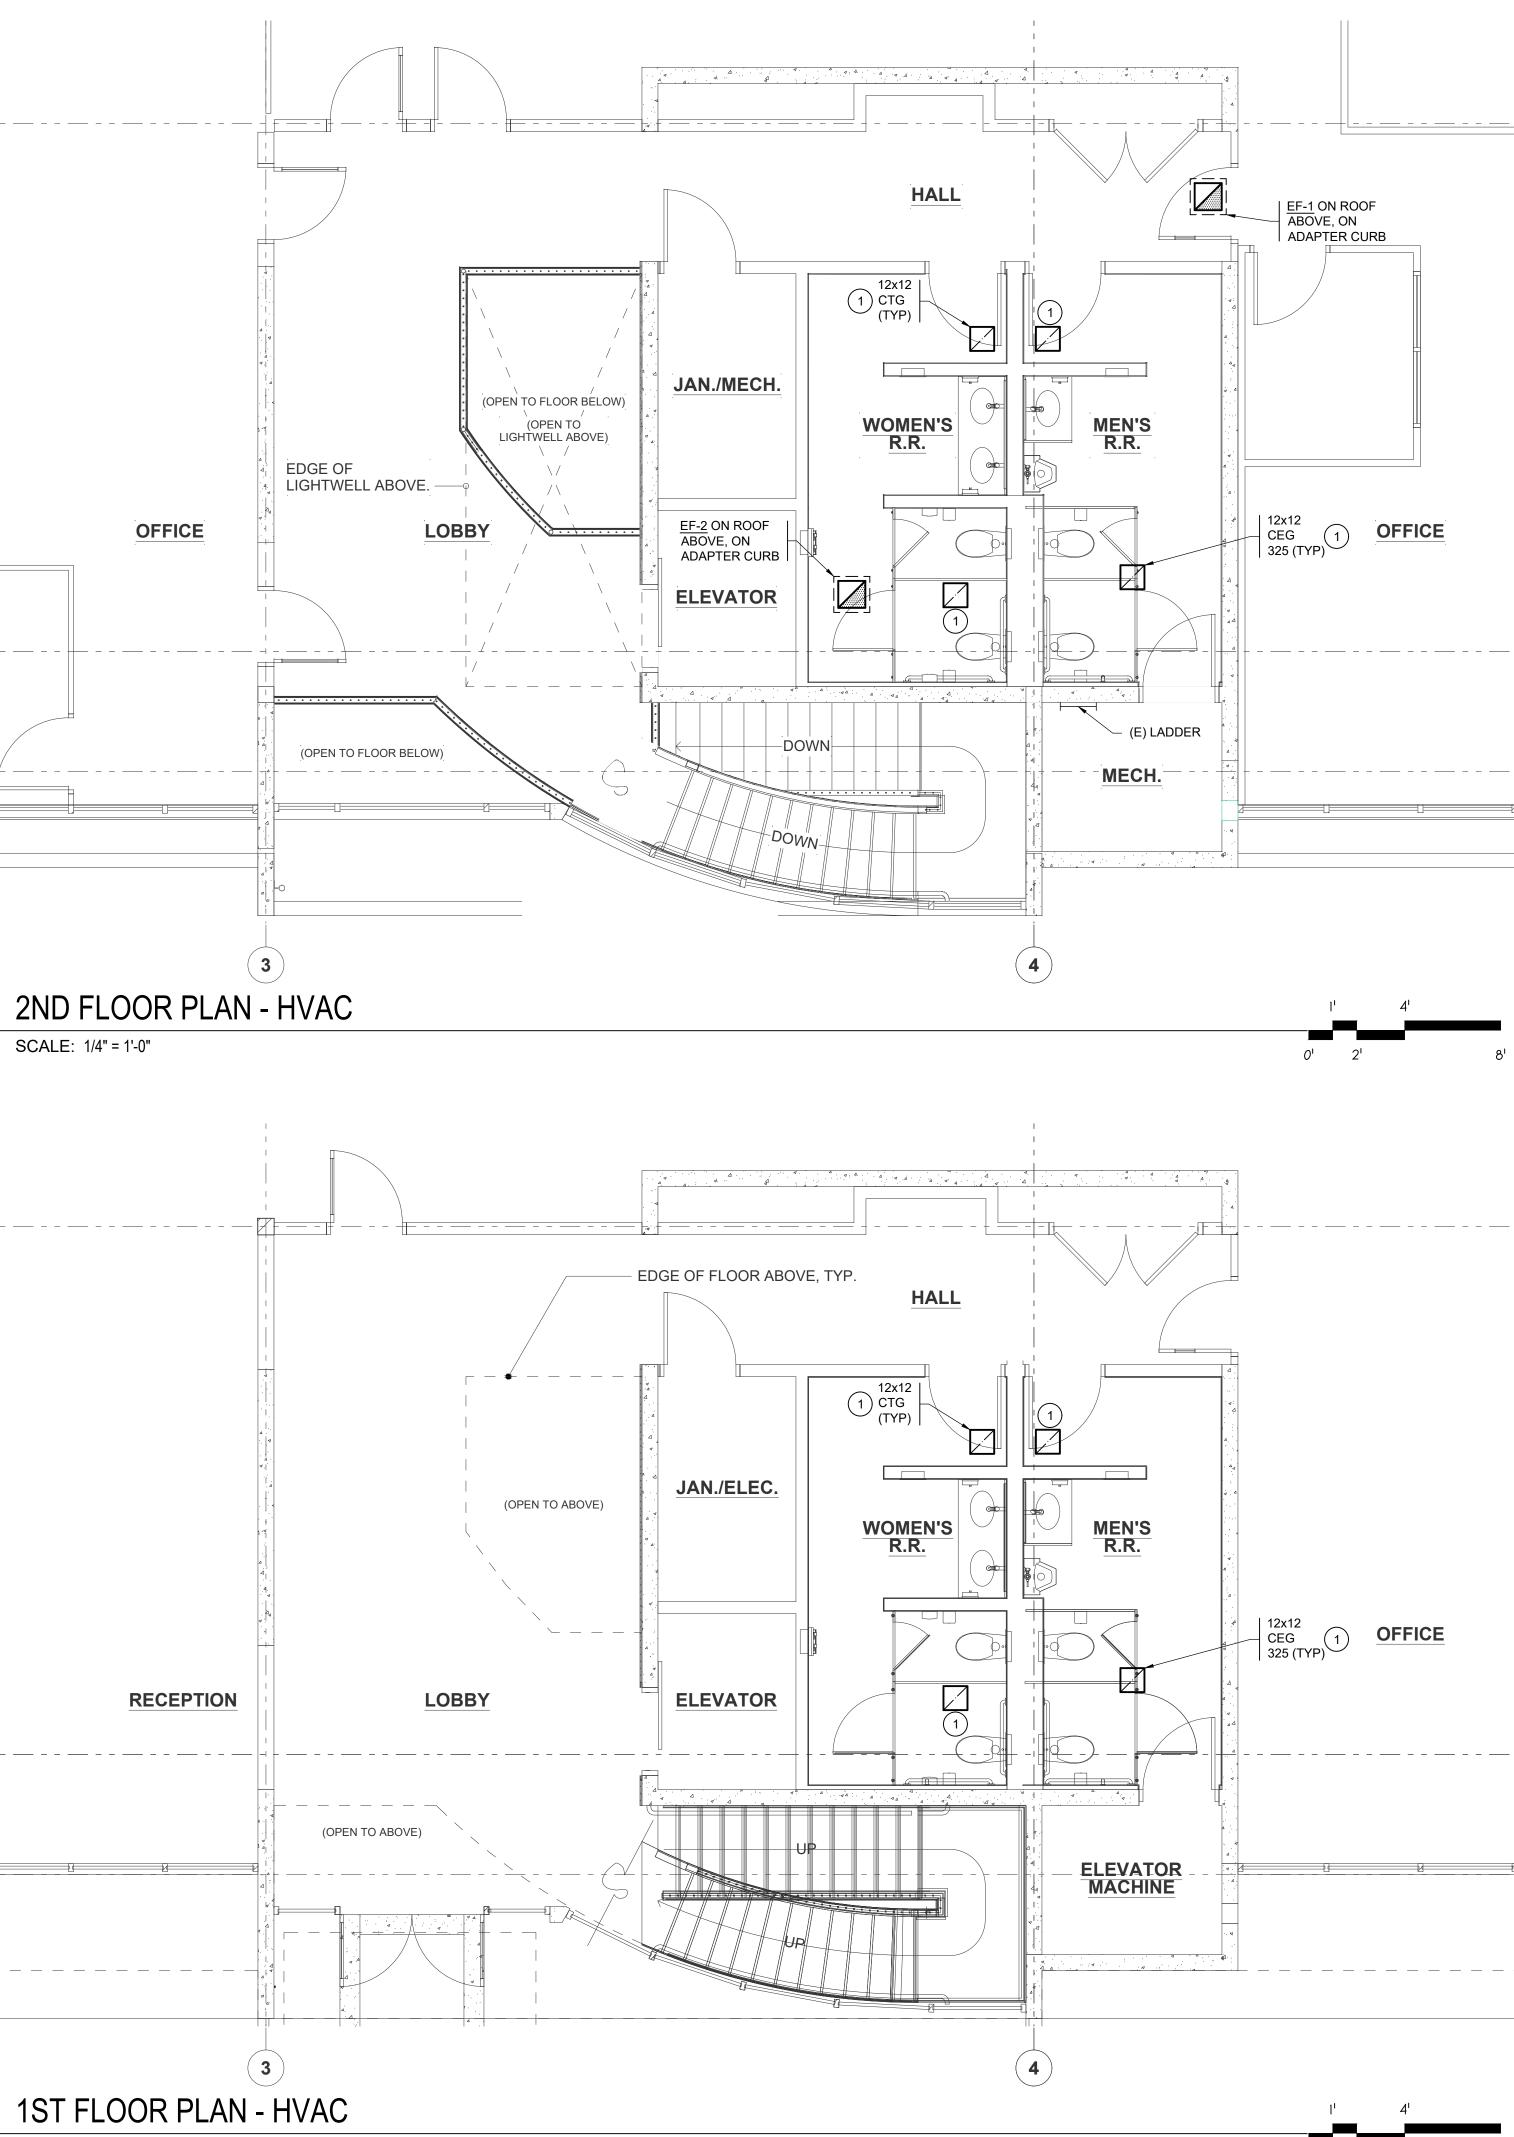













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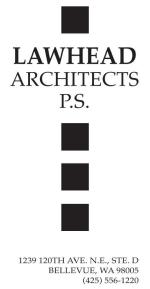
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# GENERAL NOTES:

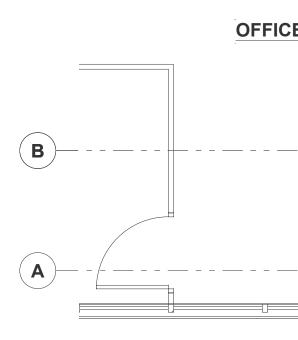- 1. SEE MECHANICAL GENERAL NOTES SEE SHEET M0-1.
- 2. NEW EXHAUST FANS TO BE CONTROLLED SAME AS THE EXISTING (RETAIN EXISTING RELAYS/CONTROLS). REVISE AS NEEDED TO OPERATE NEW FANS.

# **KEYED NOTES:**

1 EXTEND/REVISE EXISTING DUCTWORK AS NEEDED TO FIT NEW CEILING. FIELD VERIFY SIZE AND LOCATION.











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24-08

DATE... 9/23/24

SHEET TITLE... ENLARGED HVAC PLANS

SHEET NO...



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# ABBREVIATIONS

(SOME ABBREVIATIONS MAY NOT BE USED ON DRAWINGS)							
ABBREVIATIO N	DESCRIPTION	ABBREVIATIO N	DESCRIPTION				
A or AMP	AMPERES	MECH	MECHANICAL				
AC	ALTERNATING CURRENT	МН	MANHOLE				
A/C	AIR CONDITIONING	MIN	MINIMUM				
AIC	AMPERE INTERRUPTING CAPACITY	MLO	MAIN LUGS ONLY				
AL	ALUMINUM	MOP, MOCP	MAXIMUM OVERCURRENT PROTECTION				
ARCH	ARCHITECTURAL	MTD	MOUNTED				
ATC	AUTOMATIC TEMPERATURE CONTROL	MTG	MOUNTING				
ATS	AUTOMATIC TRANSFER SWITCH	NC	NORMALLY CLOSED				
AWG	AMERICAN WIRE GAUGE	N, NEUT	NEUTRAL				
BIL		NIC	NOT IN CONTRACT				
BKR	BREAKER	NO					
BLDG	BUILDING	NTS	NOT TO SCALE				
C C O							
C.O. °C		OD					
СВ	DEGREES CELSIUS CIRCUIT BREAKER	OH PA	OVERHEAD PUBLIC ADDRESS				
CCTV	CLOSED CIRCUIT TELEVISION	PB	PULLBOX				
CFM	CUBIC FEET PER MINUTE	PF	POWER FACTOR				
CKT	CIRCUIT	Ø or PH	PHASE				
CL	CENTER LINE	PNL	PHASE				
CLG	CEILING	PNL PR	PANEL				
CONC	CONCRETE	PRI	PRIMARY				
CT	CURRENT TRANSFORMER	PT	POTENTIAL TRANSFORMER				
CU	COPPER	PT PVC	POLYVINYL CHLORIDE				
	COPPER COLD WATER		RECEPTACLE				
CW BD	DECIBELS	RECPT REQ	REQUIRED				
DC DIA	DIRECT CURRENT DIAMETER	RF RM	RADIO FREQUENCY ROOM				
DIA DIV	DIVISION	RMS	ROOM ROOT MEAN SQUARE				
DPDT	DOUBLE POLE, DOUBLE THROW	SEC	SECONDARY				
DPDT	DOUBLE POLE, SINGLE THROW	SEC	SHEET				
DWG	DRAWING	SMR	SURFACE METAL RACEWAY				
EGC	EQUIPMENT GROUND CONDUCTOR	SMR	SOLID NEUTRAL				
ELEC	ELECTRIC	SP	SINGLE POLE				
ELEC	ELECTRICAL METALLIC TUBING	SPD	SINGLE POLE SURGE PROTECTIVE DEVICE				
EXST, (E)	EXISTING	SPD	SINGLE POLE, DOUBLE THROW				
ETR	EXISTING EXISTING TO REMAIN	SPDT	SINGLE POLE, SINGLE THROW				
°F	DEGREES FAHRENHEIT	SFST	STAINLESS STEEL				
FA	FIRE ALARM	STD	STANDARD				
FC	FOOTCANDLE	SW	SWITCH				
FLA	FULL LOAD AMPS	SWBD	SWITCHBOARD				
FLEX	FLEXIBLE CONDUIT	TEL	TELEPHONE				
GALV	GALVANIZED	TV	TELEVISION				
GFCI	GROUND FAULT CIRCUIT INTERRUPTER	TTB	TELECOMMUNICATIONS TERMINAL BOARD				
GND	GROUND	TYP	TYPICAL				
H-O-A	HAND - OFF - AUTO	UL	UNDERWRITERS LABORATORY				
HP	HORSEPOWER	UF	UNDERFLOOR				
HPF	HIGH POWER FACTOR	UG	UNDERGROUND				
H & V	HEATING AND VENTILATION	v v	VOLTS				
HVAC	HEATING, VENTILATION & AIR CONDITIONING	VA	VOLT AMPERES				
HZ	HERTZ	VAC	VOLTS ALTERNATING CURRENT				
IDF	INTERMEDIATE DISTRIBUTION FRAME	VAR	REACTIVE VOLT AMPERES				
J-BOX	JUNCTION BOX	VAV	VARIABLE AIR VOLUME				
KV	KILOVOLTS	VD	VOLTAGE DROP				
KVA	KILOVOLT AMPERES	VDC	VOLTS DIRECT CURRENT				
KVAR	REACTIVE KILOVOLT AMPERES	VFD	VARIABLE FREQUENCY DRIVE				
KW	KILOWATTS	VT	VAPORTIGHT				
KWH	KILOWATT HOURS	W	WATTS				
LT	LIGHT	WP	WEATHERPROOF				
LTG	LIGHTING	/w	WITH				
MAX	MAXIMUM	W/O	WITHOUT				
MCA	MINIMUM CIRCUIT AMPS	XFER	TRANSFER				
MCB	MAIN CIRCUIT BREAKER	XFMR	TRANSFORMER				
MCC	MOTOR CONTROL CENTER	XLP	CROSS-LINKED POLYETHYLENE				
MCM, KCM	THOUSAND CIRCULAR MILS	ХР	EXPLOSION PROOF				
		z	IMPEDANCE				

ELECTRICAL LEGEND							
	(SOME SYMBOLS MAY NOT		,				
SYMBOL	DESCRIPTION	SYMBOL	DESCRIPTION				
(#)	BUBBLE NOTE TAG SYMBOL: # – IDENTIFYING NUMBER	₩ L¢	DUPLEX RECEPTACLE (NEMA 5-20R)				
	SCHEDULED EQUIPMENT CONNECTION (INCLUDE	₩ I	FOURPLEX RECEPTACLE (NEMA 5-20R)				
$\bigcirc$	ALL WIRING, DISCONNECTING MEANS, CONTROL AND OTHER REQUIREMENTS SCHEDULED)	Ħ	GFCI DUPLEX RECEPTACLE (NEMA 5–20R) SUBSCRIPT: REF REFRIGERATOR DW DISHWASHER				
0	LIGHTING OUTLET - CEILING		FREZ CHEST FREEZER				
<b>  </b>	STRIP LUMINAIRE (LENGTH TO SCALE)		MWO MICROWAVE OVEN				
	LUMINAIRE (TO SCALE ON DRAWINGS)	₩*	ASTERISK INDICATES COUNTER HEIGHT OUTLET (DUPLEX RECEPTACLE SHOWN)				
0	RECESSED FIXTURE - ROUND	₩	DRYER RECEPTACLE (NEMA 14-30R)				
$\otimes$	EXIT FIXTURE LUMINAIRE WITH EMERGENCY	Þ	SPLIT WIRED RECEPTACLE, 1/2 OF RECEPTACLE IS CONTROLLED BY OCCUPANCY SENSOR OR TIMESWITCH				
	LIGHTING UNIT	H <del>≹</del>	SPLIT WIRED FOURPLEX (1) DUPLEX RECEPTACLE				
لې بې	LAY-IN LUMINAIRE EMERGENCY SURFACE FIXTURE		UNSWITCHED, (1) DUPLEX RECEPTACLE CONTROLLED BY OCCUPANCY SENSOR OR TIME SWITCH				
	EMERGENCY FIXTURE - TWIN HEAD		COPY MACHINE RECEPTACLE (NEMA 5-20R)				
$\otimes$	EXIT FIXTURE		JUNCTION BOX				
S	SINGLE POLE TOGGLE SWITCH		INDOOR POWER POLE				
\$	DIGITAL SWITCH STATION	Q	MOTOR CONNECTION				
\$ <sub>WP.</sub> S3	SWITCH SUBSCRIPTS:		PANELBOARD				
⊤ ₩ <b>F</b> , ⊂ 3	2 DOUBLE POLE		DISCONNECT SWITCH				
	3 THREE WAY 4 FOUR WAY	$\square$	DRY TYPE TRANSFORMER				
	D DIMMER	$\triangleleft$	DATA (COMPUTER) OUTLET WITH JACK				
	EP EXPLOSION PROOF K KEY OPERATED	200-4-G	FEEDER CALLOUT X-Y-Z. SEE SCHEDULE.				
	LV LOW VOLTAGE MASTER	200/150-3P	DEVICE SIZE / FUSE OR TRIP RATING – No. OF POLES				
	M MANUAL MOTOR STARTER W/OVERLOADS MC MOMENTARY CONTACT	₽	HEAVY LINE WEIGHT = NEW WORK (RECEPTACLE SHOWN)				
	P SWITCH W/PILOT LIGHT T TIMER	Þ	STANDARD LINE WEIGHT = EXISTING TO REMAIN (RECEPTACLE SHOWN)				
	WP WEATHERPROOF a, b, c MULTIGANG SWITCH STATION	中	BROKEN LINE WORK = ELECTRICAL DEMOLITION (RECEPTACLE SHOWN)				
OS	OCCUPANCY SENSOR - CEILING MOUNT						
igodot	DAYLIGHT SENSOR						

	MECHANICAL EQUIPMENT CONNECTION SCHEDULE													
				MAXIMUM RATINGS					(CU) FEEDER		DISCONNECT		CON	
NAME	DESCRIPTION	LOCATION	HP	KVA	FLA	MCA	MOCP	VOLT/PH	#12 EACH PHASE	BY	DESCRIPTION		STA	
									+ NEUTRAL +GND, UNO.	Ы		BY	DESC	
EF-1	EXHAUST FAN	ROOF	1/4	0.70	5.8	7.3	15	120 1	3/4"C-2#12 + #12G	•	TOGGLE			
EF-2	EXHAUST FAN	ROOF	1/4	0.70	5.8	7.3	15	120 1	3/4"C-2#12 + #12G	•	TOGGLE			

#### QUIPMENT CONNECTION SCHEDULE NOTES:

VERIFY VOLTAGE, PHASE, FLA/MCA OF EACH CONNECTION WITH EQUIPMENT SUPPLIER PRIOR TO ROUGH-IN. NOTIFY ARCHITECT/ENGINEER WHEN SCHEDULED SUPPLY WILL NOT MEET NEC REQUIREMENTS.

DUTLETS, DISCONNECTS, CONTROLLERS, AND EQUIPMENT CONNECTIONS FOR ROOF TOP AND OTHER OUTDOOR EQUIPMENT SHALL BE WEATHER PROOF.

LOCATION OF OUTLETS, DISCONNECTS, CONTROL DEVICES, AND EQUIPMENT CONNECTIONS ARE DIAGRAMMATIC AND TO BE LOCATED IN FIELD BY THE CONTRACTOR AS APPROVED BY THE ENGINEER. UNLESS OTHERWISE INDICATED O NTROL DEVICES IN SIGHT OF EQUIPMENT. ARRANGE WIRING AND EQUIPMENT TO AVOID INTERFERENCE WITH OTHER WORK AND TO MAXIMIZE ACCESSIBILITY FOR MAINTENANCE AND REPAIRS.

COORDINATE WITH THE OTHER INSTALLING CONTRACTORS TO ENSURE NEC REQUIRED ACCESS TO DISCONNECTS IS PROVIDED FOR EACH PIECE OF EQUIPMENT.

PROVIDE SMOKE DUCT DETECTORS IN HEATING AND COOLING SYSTEMS PER INTERNATIONAL MECHANICAL CODE. SEE DIVISION 25 EQUIPMENT SCHEDULES FOR ADDITIONAL UNITS RATED COMBINED 2000 CFM OR GREATER AND PROVIDE DUCT DETECTOR AS REQUIRED.

WIRING BETWEEN EQUIPMENT DISCONNECT AND POINT OF CONNECTION SHALL COMPLY WITH NEC BASED ON EQUIPMENT NAMEPLATE RATING EXCEPT MINIMUM BRANCH CIRCUIT RATING SHALL BE 20 AMPERES.

SIZE OF DISCONNECT SWITCH AND MOTOR STARTER SHALL BE SIZED TO COMPLY WITH NEC REQUIREMENTS. WHERE INDICATED MOTOR CONTROL IS NOT LOCATED IN SIGHT OF MOTOR AS DEFINED BY NEC, PROVIDE ADDITIONAL DISCONNECTING MEANS TO COMPLY WITH NEC 430.102. WIRING SIZES ARE BASED ON 60 DEGREE C. FOR AMPACITIES 100 AMPERES AND LESS. FOR FEEDERS LESS THAN 100 FEET IN LENGTH, CONDUCTOR SIZES MAY BE SELECTED BASED ON 75 DEGREE C. WHERE EQUIPMENT INSTALLED IS LABELED FOR 75 DEGREE C. WIRING.

CHEDULE LEGEND:

FURNISH AND INSTALL NEW UNDER DIVISION 26 O = INSTALL UNDER DIVISION 26; FURNISHED WITH EQUIPMENT OR BY OTHERS.

X = FURNISH AND INSTALL BY OTHERS (NOT DIVISION 26) \* = EXISTING, RELOCATED EQUIPMENT

## GENERAL ELECTRICAL NOTES:

- 1. SEE ARCHITECTURAL PLANS FOR LOCATION OF FIRE RATED CONSTRUCTION.
- 2. BRANCH CIRCUIT NOTES:
- A. VERIFY BRANCH CIRCUIT WIRE COUNT BEFORE PULLING CONDUCTORS. PROVIDE REQUIRED CONDUCTORS TO EACH OUTLET AND DEVICE FOR PHASE, NEUTRAL AND EQUIPMENT GROUND BASED ON CIRCUIT DESIGNATIONS SHOWN AND AS OTHERWISE INDICATED ON PLANS OR NOTE BELOW.
- B. PROVIDE SEPARATE NEUTRAL CONDUCTOR FOR BRANCH CIRCUITS SERVING RECEPTACLE OUTLETS UNLESS OTHERWISE INDICATED.
- C. MINIMUM BRANCH CIRCUIT CONDUCTOR SIZE FOR OUTDOOR AND EXTERIOR BUILDING LIGHTING SHALL BE MINIMUM NO. #10 AWG. PROVIDE LARGER SIZE FEEDER PER CODE WHERE EQUIPMENT MCA EXCEEDS 30 AMPS.
- 3. MINIMUM CONDUIT SIZE FOR HOMERUNS SHALL BE 3/4 INCH.
- 4. REFER TO ARCHITECTURAL PLANS FOR LIGHT FIXTURE LOCATIONS AND FOR MOUNTING HEIGHT OF SUSPENDED AND WALL MOUNTED LIGHT FIXTURES. REFER TO REFLECTED CEILING PLANS, INTERIOR ELEVATIONS, EXTERIOR ELEVATIONS, ROOM SECTIONS, AND DETAILS SHOWN ON ARCHITECTURAL CONTRACT DOCUMENTS PRIOR TO ROUGH-IN. REPORT CONFLICTS TO ARCHITECT/ENGINEER FOR RESOLUTION.
- 5. REFER TO ARCHITECTURAL ELEVATIONS FOR LOCATION AND MOUNTING HEIGHT OF WIRING DEVICES. REPORT CONFLICTS TO ARCHITECT/ENGINEER FOR RESOLUTION.
- 6. VERIFY BACK BOX REQUIREMENTS OF EQUIPMENT FURNISHED UNDER OTHER THAN DIVISION 26, 27 OR 28 SECTIONS AND EQUIPMENT FURNISHED BY OWNER.

#### ENERGY CODE COMPLIANCE NOTES

- 1. MANUAL LIGHTING CONTROL: PROVIDE EACH ROOM WITH MANUAL LIGHTING CONTROL AS INDICATED. REMOTE LIGHTING CONTROLS SHALL IDENTIFY WHERE LIGHTS ARE CONTROLLED AND ON/OFF STATUS. MANUAL CONTROLS FOR SPACES NOT COVERED IN C405.2.1 LISTED EXCEPTIONS SHALL INCLUDE PROVISION FOR 50% LIGHT REDUCTION.
- 2. OCCUPANCY SENSORS: PROVIDE OCCUPANCY SENSORS IN ALL CLASSROOMS, CONFERENCE/MEETING ROOMS, LUNCH AND BREAK ROOMS, PRIVATE OFFICES, RESTROOMS, WAREHOUSE AND STORAGE SPACES, JANITORIAL CLOSETS, AND OTHER SPACES 300 SQUARE FEET OR LESS.
- 3. MOTORS SHALL COMPLY WITH EFFICIENCY REQUIREMENTS OF C405.8, SEE MECHANICAL DOCUMENTS FOR MOTOR EFFICIENCY DATA.

DRAWING INDEX						
SHEET #	DESCRIPTION					
E0-1	ABBREVIATIONS, LEGEND, & NOTES					
E1-1	ELECTRICAL DEMOLITION PLANS					
E2-1	ELECTRICAL POWER AND LIGHTING PLANS					
E5-1	ONE-LINE DIAGRAM					

NTROLS	REMARKS
ARTER	
SCRIPTION	




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9/23/24

SHEET TITLE... ABBREVIATIONS, LEGEND, & NOTES SHEET NO...




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general@hultzbhu.com Job Number: 24-145

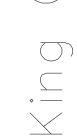**E0-**]

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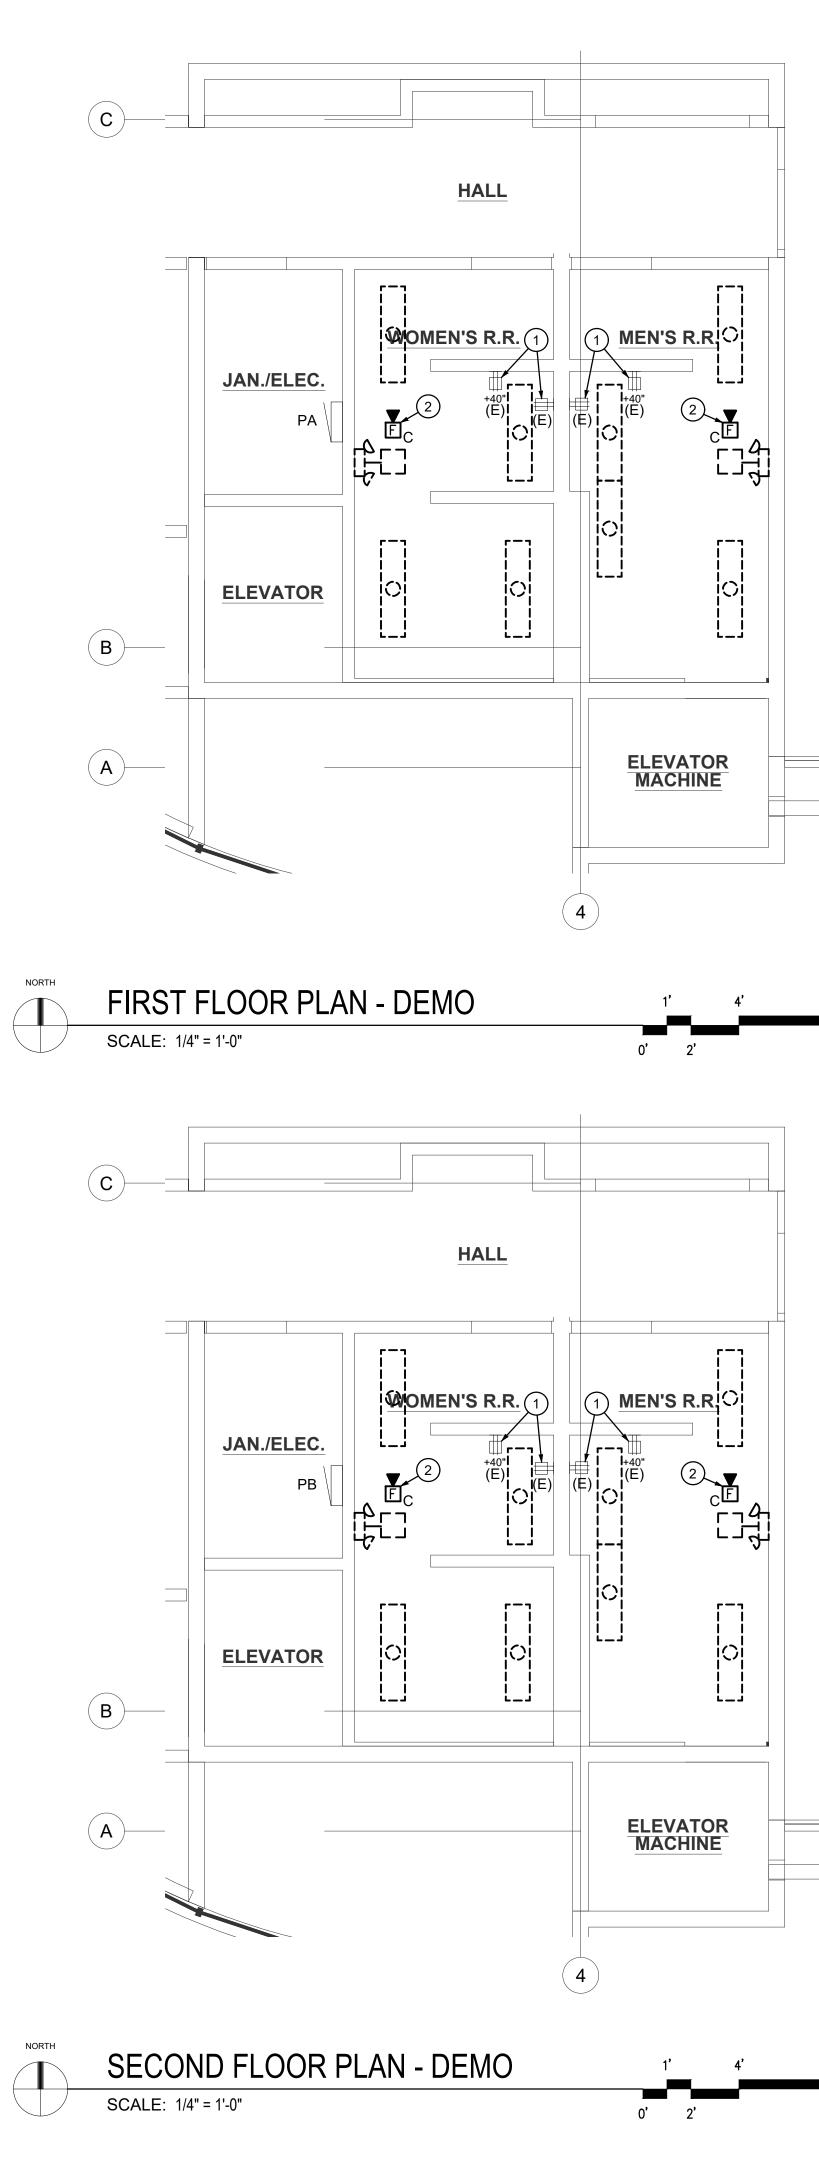
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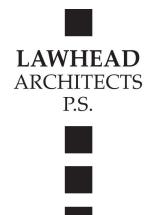
Housing

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PLO1 FILE

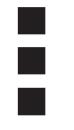



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SIGNED 9-23-2024

King County Housing Authority

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+---OWNER...

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SIGNATURE.

# **GENERAL NOTES:**

- 1. REFER TO GENERAL ELECTRICAL NOTES ON SHEET E0-1 FOR ADDITIONAL INFORMATION.
- 2. CONTRACTOR TO VERIFY ALL CIRCUITING PRIOR TO BEGINNING WORK. ALL CIRCUITS IDENTIFY ARE BASED ON LIMITED FIELD OBSERVATIONS AND OWNER PROVIDED AS-BUILTS.

# PLAN NOTES:

- 1 EXISTING OUTLETS TO BE REPLACED. REMOVE EXISTING GFCI DUPLEX OUTLET AND FACEPLATE. EXISTING WIRING TO REMAIN FOR RECONNECTION.
- 2 SALVAGE FIRE ALARM HORN/STROBE FOR REINSTALLATION. WIRING IS TO REMAIN FOR RECONNECTION.





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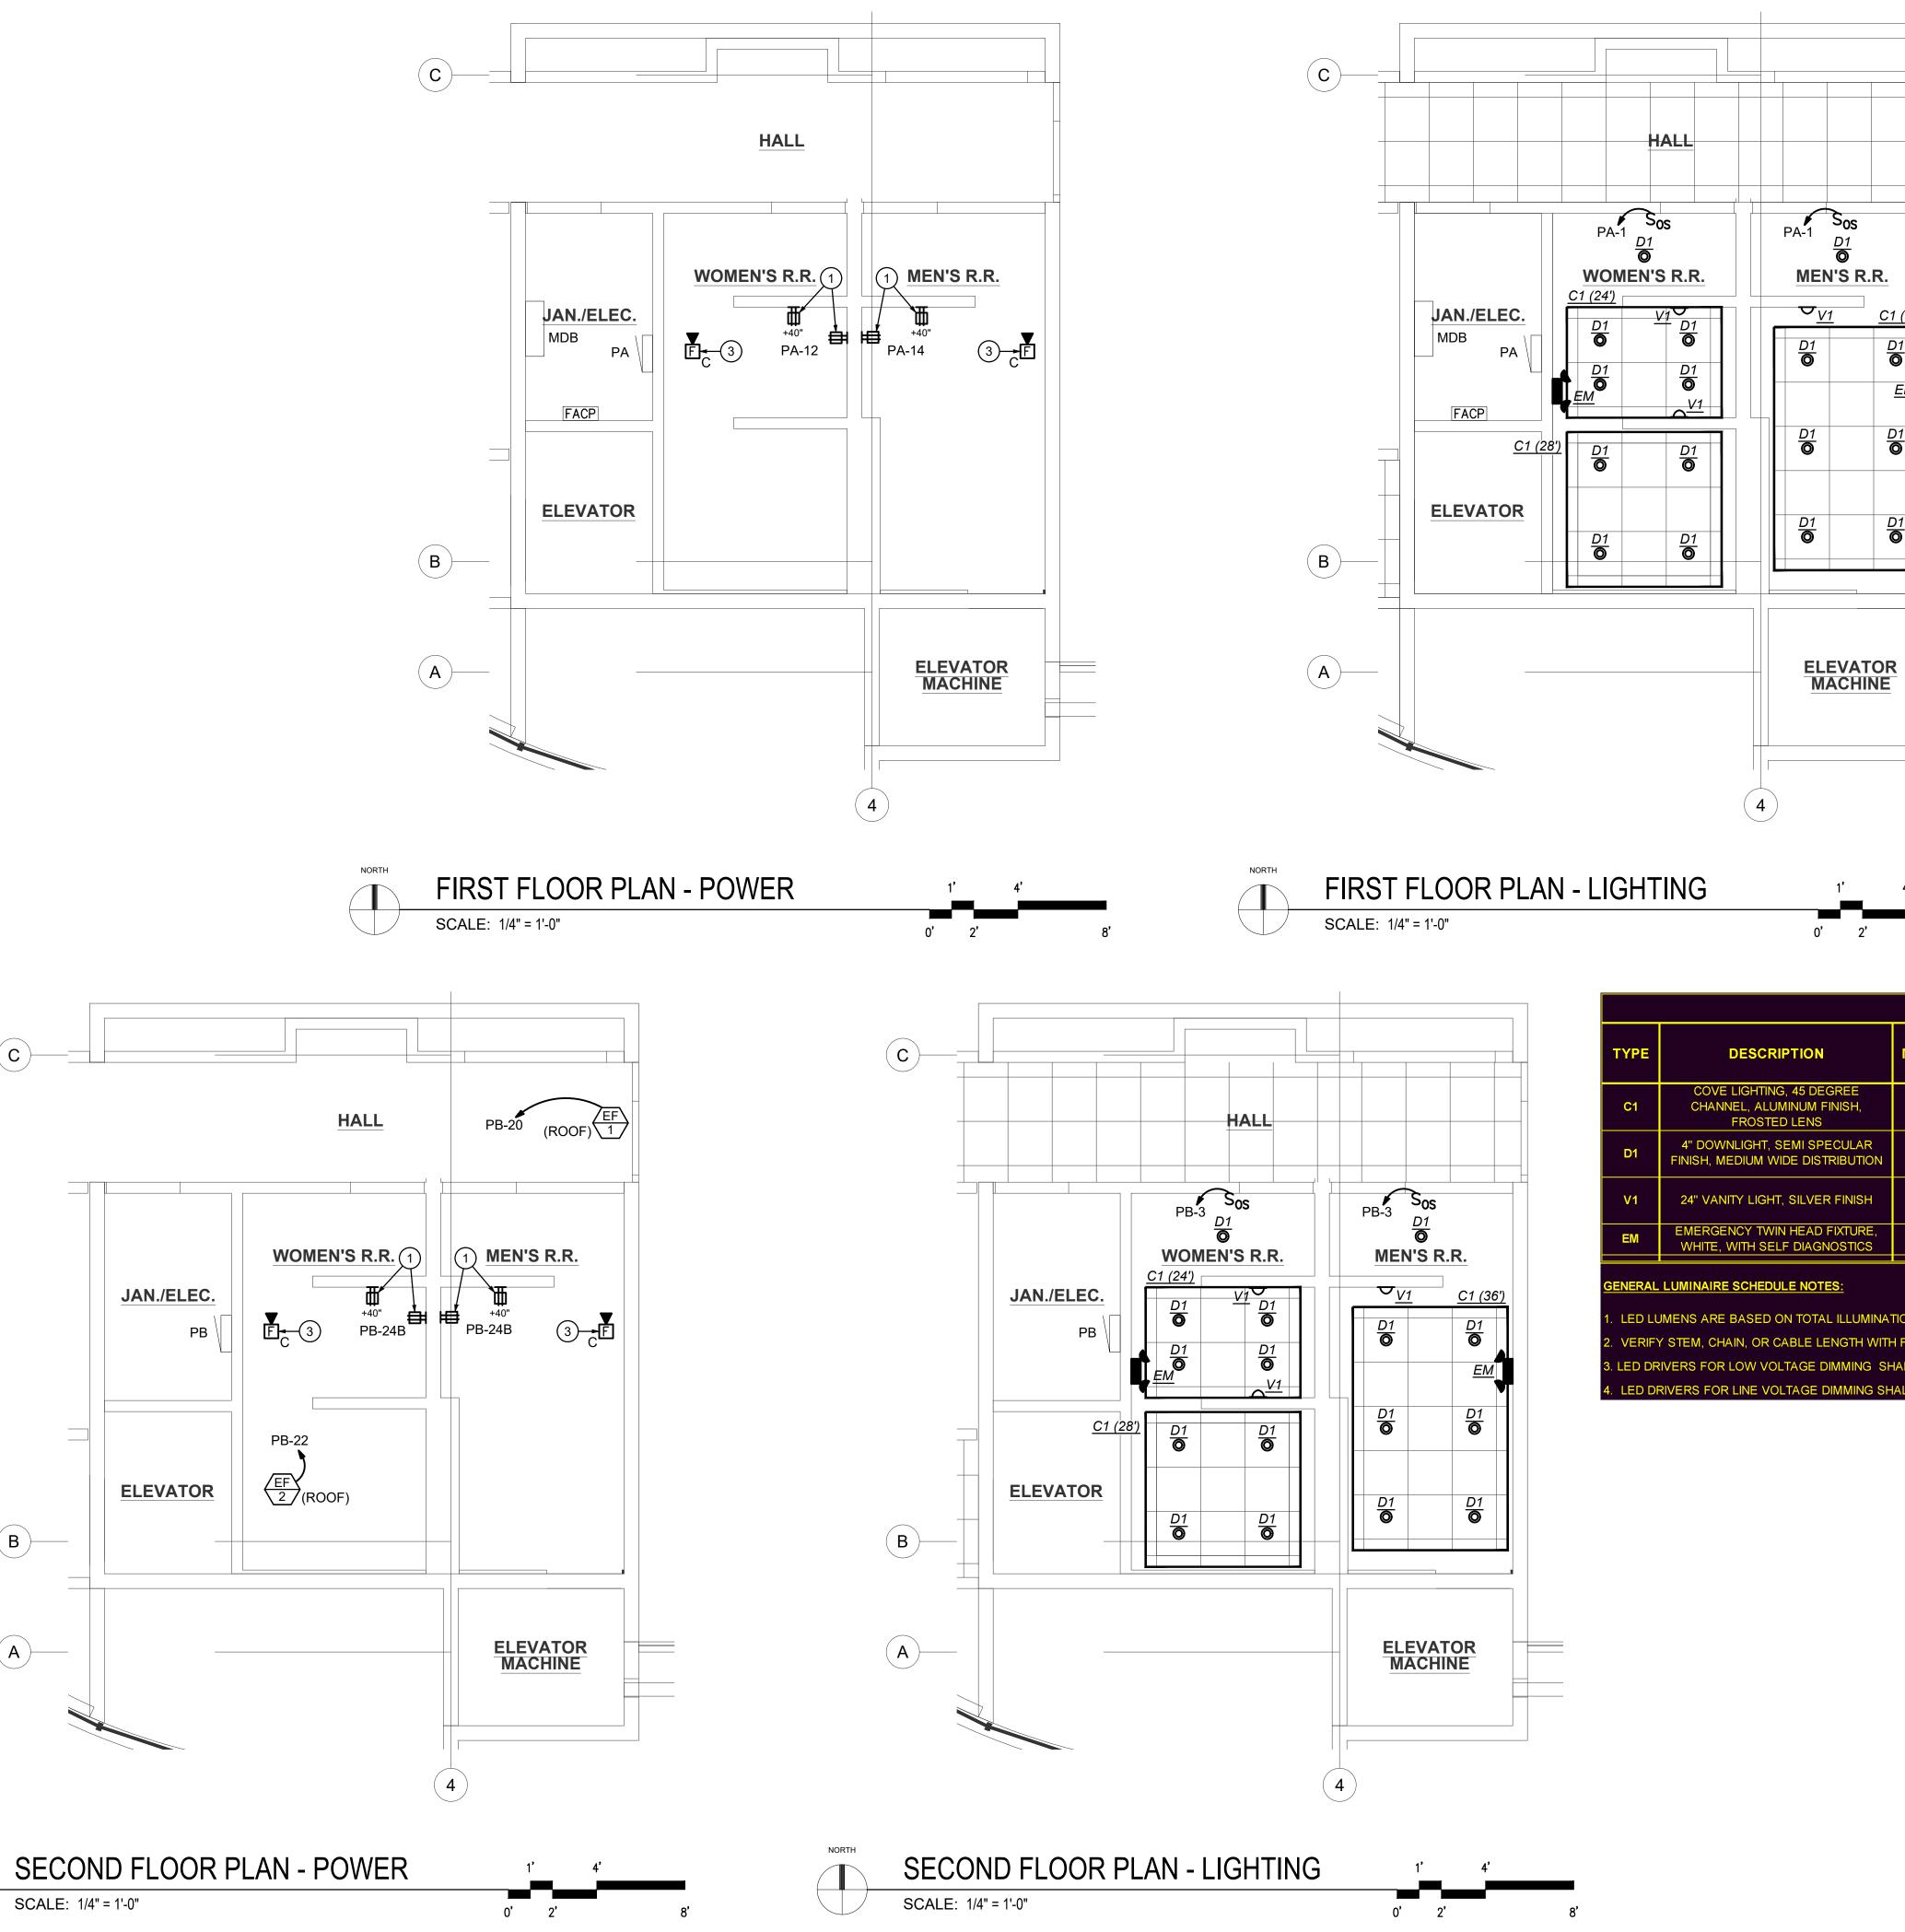
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ELECTRICAL DEMOLITION PLANS SHEET NO...



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NORTH



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# **GENERAL NOTES:**

- REFER TO GENERAL ELECTRICAL NOTES ON SHEET E0-1 FOR 1. ADDITIONAL INFORMATION.
- 2. CONTRACTOR TO VERIFY ALL CIRCUITING PRIOR TO BEGINNING WORK. ALL CIRCUITS IDENTIFY ARE BASED ON LIMITED FIELD OBSERVATIONS AND OWNER PROVIDED AS-BUILTS.

# PLAN NOTES:

- 1 EXISTING OUTLETS TO BE REPLACED WITH NEW. PROVIDE NEW GFCI DUPLEX OUTLET AND NEW FACEPLATE. CONNECT TO EXISTING CIRCUIT.
- 2 NOT USED
- 3 REINSTALL SALVAGED FIRE ALARM HORN/STROBE. RECONNECT TO EXISTING WIRING.





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	4'	
2'		8'

C1 (36')

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D1

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<u>D1</u>

LUMINAIRE SCHEDULE							
	MANUFACTURER	LAMP	VOLTAGE	INPUT WATTS	BALLAST/ DRIVER	REMARKS	
REE ISH,	DIODELED BLAZE SERIES	LED 3500K 126 LM/FT	24VDC	1.5W / FT	0-10V	PROVIDE POWER SUPPLY AS REQUIRED. LENGTH VARIES, SEE PLANS	
ULAR BUTION	LITHOINA LIGHTING LDN4 SERIES	LED 3500K 1500 LUMENS	120V	19	0-10V		
INISH	INDESSA 444 SERIES	LED 3500K 2380 LUMENS	120V	24	0-10V		
KTURE, STICS	LITHONIA LIGHTING ELM2L SERIES	LED	120V	2.4	-		

LED LUMENS ARE BASED ON TOTAL ILLUMINATION OUTPUT OF THE LUMINAIRE UNLESS OTHERWISE INDICATED.

(ERIFY STEM, CHAIN, OR CABLE LENGTH WITH FIXTURE VENDOR AS REQUIRED TO ACCOMMODATE THE INDICATED MOUNTING HEIGHT MEASURED TO BO OR LOW VOLTAGE DIMMING SHALL BE 0-10 VOLTS [ DIGITAL SIGNAL DIMMING INTERFACE TYPE ] UNLESS OTHERWISE INDICATED. ED DRIVERS FOR LINE VOLTAGE DIMMING SHALL BE REVERSE PHASE ELECTRONIC LOW VOLTAGE (ELV) UNLESS OTHERWISE APPROVED BY THE ARCH





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DATE...


9/23/24

-<del>†\_\_\_</del> SHEET TITLE... ELECTRICAL POWER AND LIGHTING PLANS = SHEET NO...




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general@hultzbhu.com Job Number: 24-145

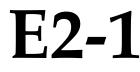

PARLE MDB         VICLIAGE 2007.0         VICLIAGE 2007.0<	LOAD CALCULATION - 30 DAY MINIMUM RECORDING		REVISED THREE PHASE PANEL SCHEDULE				REVISED THREE PHASE PANEL SCHEDULE			
LEACH JON     LEACH	480/277V - 3PH		ΡΑ	VOLTAGE: 208/120 🔽 4W	RATING: 200 A MAIN:	LUG	PB	VOLTAGE: 208/120 🖌 4W	RATING: 225 A MAIN:	BREAKER
Norma         Norma <th< th=""><th></th><th></th><th>- GRID</th><th>ENCLOSURE</th><th>_ACCESSORIES_</th><th>_AIC ASSEMBLY</th><th>GRID</th><th>ENCLOSURE</th><th>_ACCESSORIES_</th><th>AIC ASSEMBLY</th></th<>			- GRID	ENCLOSURE	_ACCESSORIES_	_AIC ASSEMBLY	GRID	ENCLOSURE	_ACCESSORIES_	AIC ASSEMBLY
Number of the second	DESCRIPTION	REMARKS	SECTION 1 OF1	FLUSH	ISOLATED GROUND	SERVICE RATED	SECTION 1 OF1	FLUSH	ISOLATED GROUND	SERVICE RATED
Norm			LOCATION: ELEC CLOSET	X SURFACE	SPD	SERIES RATED	LOCATION: ELEC CLOSET	X SURFACE	SPD	SERIES RATED
CODINIE FIELD         VEX.         FUEL         VEX.         FUEL         CODINIE FIEL         COUNT         VEX.         FUEL         FUEL         COUNT         VEX.         FUEL         FUEL         COUNT         VEX.         FUEL         FUEL        FUEL         FUEL        FUEL										
Displand     Displ				NEMA TYPE 3R	FEED THRU LUGS	22K		NEMA TYPE 3R	FEED THRU LUGS	22K
Construct         Construct <t< td=""><td>CORDING PERIOD 12/8/2022 TO 1/10/2023</td><td>HIGHEST RECORDED</td><td></td><td></td><td></td><td></td><td></td><td></td><td></td><td></td></t<>	CORDING PERIOD 12/8/2022 TO 1/10/2023	HIGHEST RECORDED								
CALA MARKES         1/3.2         AVR         1/4.0         VA         4         201         201         2         1/4.0         4         201         201         2         201         2         201         2         201         2         201         2         2         4         201         2         2         4         201         2         2         4         201         2         2         4         201         2         4         201         2         4         201         2         4         201         2         4         201         201         2         4         201         201         2         4         201         201         2         4         201        201         201 <t< td=""><td></td><td></td><td></td><td>* VA BKR CKT A</td><td>B C CKT BKR VA</td><td></td><td></td><td>* VA BKR CKT A</td><td>B C CKT BKR VA</td><td></td></t<>				* VA BKR CKT A	B C CKT BKR VA			* VA BKR CKT A	B C CKT BKR VA	
FACK/NAL ADULTINITY       1008       NA       PRC0PTALES       120       201       <				<b>508</b> 20/1* 1 1228				720 20/1 1 2220	2 20/1 1500	AC UNIT RECEPTACLE
DUDIE DEVENUE         TONINUE DECLIPANCE         TONINUE DECLIPANCE         RECEPTACES         140/2020         7         80         200         60         2000         60         2000         7         140         200         7         20         RECEPTACES         700         RECEPTACES         140/2020         7         80         20         70         RECEPTACES         100 </td <td></td> <td>A</td> <td></td> <td></td> <td></td> <td></td> <td></td> <td><b>508</b> 20*/20 3</td> <td>758 4 20/1 250</td> <td>CIRCULATION PUMP</td>		A						<b>508</b> 20*/20 3	758 4 20/1 250	CIRCULATION PUMP
CCUPNON DRAT         DDS         CCUPNOLES         CCUPNOLES         RECEPTACLES         RECE								1440 20/20 5	2440 6 20/1 1000	CORE LIGHTING
Distribution     D	DJUSTED DEMAND 104.0 KVA	A						1440 20/20 7 2880	8 20/20 1440	RECEPTACLES
Under U	CCUPANCY ADJUSTMENT 100%	CONTINOUS OCCUPANCY						1440 20/20 9		RECEPTACLES
NAME DATE       NEC2087       REC2087	DJUSTED DEMAND 104.0							1440 20/20 11		RECEPT. PERIMETER
CACA ADDED         383.5         KVA         SERVICE UPGRADE         Toto IPADE         Toto IPADE <td></td> <td>NEC 220 87</td> <td></td> <td></td> <td></td> <td></td> <td></td> <td>500 20/20 13 1940</td> <td></td> <td>RECEPTACLES</td>		NEC 220 87						500 20/20 13 1940		RECEPTACLES
CAD ALODED         363.3         KVA         SERVICE UPGRADE         Total Product						PANEL PB		500 20/20 15	1940 16 20/20 1440	RECEPTACLES / FURNACE
EW LOAD ADDED     2.4     KVA     THS PROJECT     TELEPHONE RECEPTACLES     360     2.7     740     360     2.8     700     700     2.2     700<									2880 18 20/20 1440	RECEPTACLES / FURNACE
NLLOAD       S20.3       WA       RCCPTACLES       Math       Math <td></td> <td></td> <td></td> <td></td> <td></td> <td></td> <td>220 OUTLET</td> <td></td> <td></td> <td>RESTROOM EXHAUST FAN</td>							220 OUTLET			RESTROOM EXHAUST FAN
NUAD       55.3       KV       63.4       AMPS       100       801       27       72       72       72       72       72       72       74       500       97.01	EW LOAD ADDED 2.4 KVA								1196 22 20/1* 696	RESTROOM EXHAUST FAN
ALLOAD       S20.3       KVA       FREE_ARM PANEL       500       201       720<										RECEPTACLES
G3.4       AMPS       PRECUPALLES       720       201	ALLOAD 526.3 KVA	Α								RECEPTACLES
ADD TAYEED       ADD TAYEED <td></td> <td></td> <td></td> <td></td> <td></td> <td>PANEL P5</td> <td></td> <td></td> <td></td> <td>RECEPTACLES</td>						PANEL P5				RECEPTACLES
AWORK STATIONS RECEPTACLES       100       20/1       33       1500       9680       34       20/1       500       L/W WOLTAGE PANEL See of the See of the SWITCHED NEUTRAL, S=SHUNT TRP       A=AFCL G=G-GCL N=SWITCHED NEUTRAL, S=SHUNT TRP       VA         WORK STATIONS       20/1       37       940       9680       34       1003       8960       PANEL P2       10876       9804       13990       VA         WORK STATIONS       500       20/1       37       940       40       8960       PANEL P2       10876       9890       VA         Sold       30/2       33       940       9400       40       8960       SPACE       100/2       10	000.4 AM							1440 20/20 29		RECEPTACLES
RECEPTACLES       20/1       35       20/1       35       36       100/3       8960       PANEL P2       K-KEYED, P=PADLOCK ATTACHMENT       K-KEYED, P=PADLOCK ATTACHMENT       VA       Amps         2 WORK STATIONS       500       30/2       37       3776									5 8934 13960 VA PANEL PB	
MAIN ENTRY LIGHTS (DESK)       500       2V1       37       9460 <th< td=""><td></td><td></td><td></td><td></td><td></td><td></td><td></td><td></td><td></td><td></td></th<>										
2 WORK STATIONS       500       30/2       39       9460       40       3960       SPACE       ILGHTING       KVA       KVA       TOTAL LOAD       KVA       AMPS         SBREAKER CODE: A=AFCI, G=GFCI, N=SWITCHED NEUTRAL, S=SHUNT TRIP       S706       33736       30760       VA       PANEL PA       SPACE       ILGHTING       X       1.0       X       100%       1.0       X       CONNECTED 33.8       93.7         A=AFCI, G=GFCI, N=SWITCHED NEUTRAL, K=KEYED, P=PADLOCK ATTACHMENT       STOR       33736       30780       VA       PANEL PA       RECEPTACLES OVER 10K       20.9       X       500%       10.4       CALULATED 23.7       65.8         LIGHTING       2.6       X       125%       30780       VA       VA       VA       VA       RECEPTACLES OVER 10K       20.9       X       500%       10.4         LIGHTING       2.6       X       125%       33       COTAL LOAD       KMPS       MOTORS       X       100%       X       10.0       X       <						PANEL P2	K=KEYED, P=PADLOCK ATTACHMI			
Image: Solution of the state in the sta										44450
BREAKER CODE:			2 WORK STATIONS							
K=AFCI, G=GFCI, N=SWITCHED NEUTRAL, S=SHUNT TRIP       VA       VA       VA       VA       RECEPTACLES OVER 10K       20.9       X       50%       10.4       *       *       Component of the						SPACE				
K=KEYED, P=PADLOCK ATTACHMENT       VA       VA       VA       VA       MOTORS       1.4       X       10%       1.4       X       1.4       X       10%       1.4       X					33736 30786 VA PANEL PA					65.8
KVAKVAKVAANPSLARGEST MOTORX125%* EQUIPMENT REPLACED LIKELIGHTING2.6X125%337360786VA SUB-TOTAL LOADKVAAMPSKITCHENX100%* NEW LOAD ON EXISTING BRELIGHTING2.6X125%10.0277.5NONCOINCIDENTX0%*NOWRECEPTACLES0.0X10.0CALCULATED62.0172.1NONCOINCIDENTX100%*NEW LOAD ON EXISTING BREAKERMOTORS1.4X100%1.4****NEW LOAD ON EXISTING BREAKEREV CHARGERX125%LIGHT LINE WEIGHT EQUALS EXISTING BREAKERNONCOINCIDENT2.8X100%6.2X100%5.2***										
KVAKVATOTAL LOADKVAAMPSKITCHENX100%**NEW LOAD ON EXISTING BRELIGHTING2.6X125%3.3CONNECTED10.0277.5NONCOINCIDENTX0%RECEPTACLES10.0X10.0CALCULATED62.0172.1REMAINDERX100%EV CHARGERX125%NOTORS1.4X100%1.4****NEW LOAD ON EXISTING BREAKEREV CHARGERX125%LIGHT LINE WEIGHT EQUALS EXISTINGNONCOINCIDENTX125%125%125%*NEW LOAD ON EXISTING BREAKEREV CHARGERX100%X100%NONCOINCIDENTX100%6.2X100%6.2*NEW LOAD ON EXISTING BREAKERHEAVY LINE WEIGHT EQUALS NEWNONCOINCIDENTX0%X0%X100%KITCHENKITCHENKITCHENKITCHENKITCHENNONCOINCIDENTX100%5.2*NEW LOAD ON EXISTING BREAKERKITCHENKITCHENKITCHENKITCHENKITCHENKITCHENKITCHENNONCOINCIDENTX100%6.2X100%6.2*NEW LOAD ON EXISTING BREAKERKITCHEN <t< td=""><td></td><td></td><td>K=KEYED, P=PADLOCK ATTACHM</td><td></td><td></td><td></td><td></td><td>N 4050/</td><td></td><td></td></t<>			K=KEYED, P=PADLOCK ATTACHM					N 4050/		
LIGHTING       2.6       X       125%       3.3       CONNECTED 100.0 277.5       NONCOINCIDENT       X       0%         RECEPTACLES       10.0       X       100%       10.0       CALCULATED 62.0       172.1       REMAINDER       X       100%         RECEPTACLES OVER 10K       77.2       X       50%       38.6       *       *       100%       EV       KEMAINDER       X       100%         MOTORS       1.4       X       100%       1.4       *						4400				
RECEPTACLES10.0X10.0%10.0CALCULATED62.0172.1REMAINDERX100%RECEPTACLES OVER 10K77.2X50%38.6**EV CHARGERX125%LIGHT LINE WEIGHT EQUALS EXISTINGMOTORS1.4X100%1.4*****EMARKS125%LIGHT LINE WEIGHT EQUALS EXISTINGLARGEST MOTORX125%***NEW LOAD ON EXISTING BREAKER**HEAVY LINE WEIGHT EQUALS NEWNONCOINCIDENT6.2X100%6.2X100%6.2*****									NEW LOAD ON EXIST	ING BREAKER
RECEPTACLES OVER 10K       77.2       X       50%       38.6         MOTORS       1.4       X       100%       1.4         LARGEST MOTOR       X       125%       LIGHT LINE WEIGHT EQUALS EXISTING         KITCHEN       6.2       X       100%       6.2         NONCOINCIDENT       X       0%       -										
MOTORS1.4X100%1.4* REMARKSLIGHT LINE WEIGHT EQUALS EXISTINGLARGEST MOTORX125%* NEW LOAD ON EXISTING BREAKERHEAVY LINE WEIGHT EQUALS NEWKITCHEN6.2X100%6.2NONCOINCIDENTX0%					CALCULATED 62.0	1/2.1				
LARGEST MOTORX125%* NEW LOAD ON EXISTING BREAKERKITCHEN6.2X100%6.2NONCOINCIDENTX0%								A 125%		SEVISTING
KITCHEN         6.2         X         100%         6.2           NONCOINCIDENT         X         0%         0%         0%										
NONCOINCIDENT X 0%					* NEW LOAD ON EXIST					
REMAINDER 2.5 X 100% 2.5										
EV CHARGER X 125%			EV CHARGER	X 125%						

HEAVY LINE WEIGHT EQUALS NEW



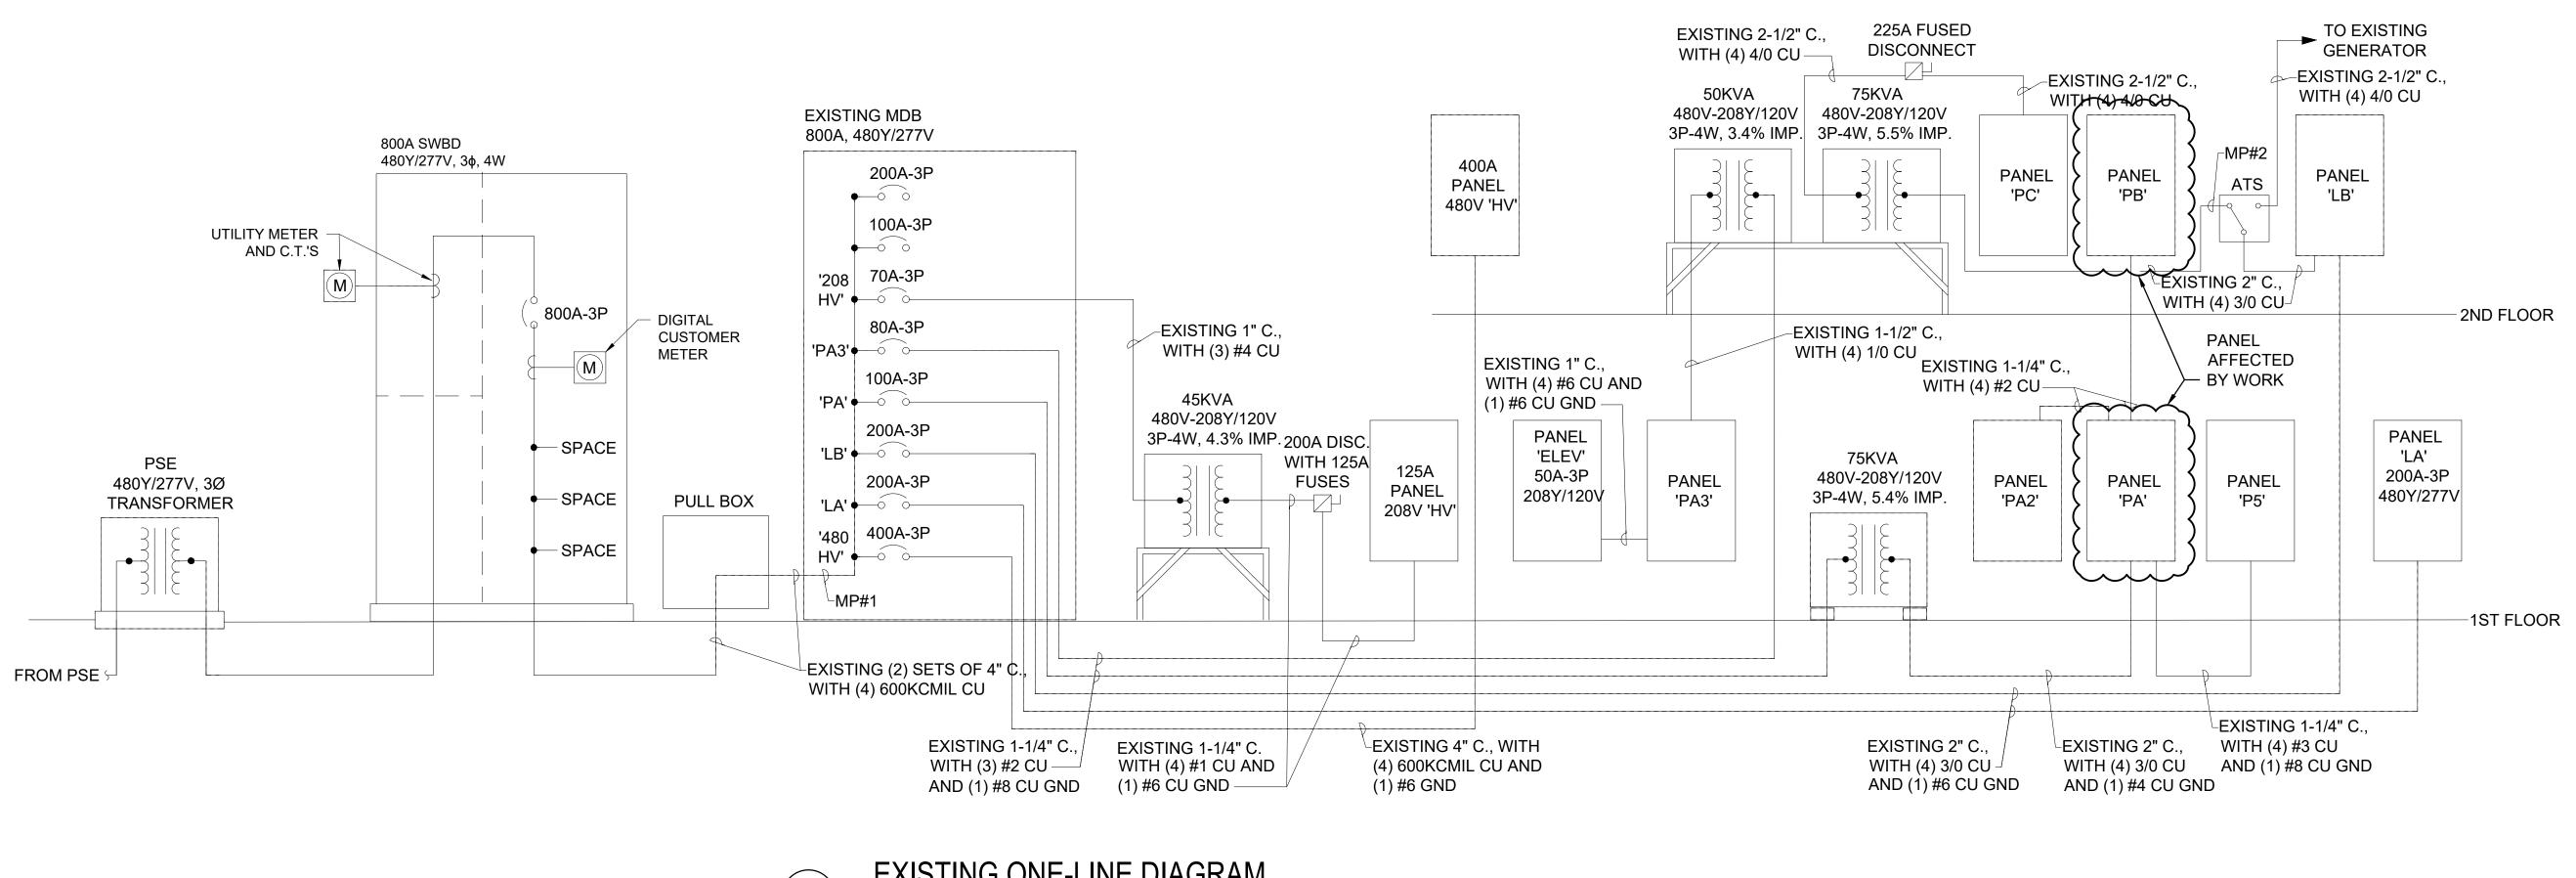

SCALE: N.T.S.



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SIGNED 9-23-2024 OWNER... King County Housing Authority +۰ —  $\subseteq$  $\stackrel{\text{A}}{\vdash}$  $( \ )$  $\underbrace{ }$  $\overline{}$  $\bigcirc$ 

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9/23/24

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**ONE-LINE** DIAGRAM

+---SHEET NO...



